

*ONLY STANDARD SHEETS MARKED WITH AN "✓" ARE IN THIS PROJECT #


**REVISED OR ADDED

✓*	SHEET NO.	TITLE	APPROVAL DATE**	✓*	SHEET NO.	TITLE	APPROVAL DATE**
	HW-506_01	ENDWALLS, SLOPE PAVED INLETS AND OUTLETS	1-26-12		HW-821_05a	TRANSITION - 45" (1145) F-SHAPE TO 54" (1372) VERTICAL SHAPE SHEET 1	1-26-12
	HW-506_02	TYPE "D-G" & "L" ENDWALLS	7-13-12		HW-821_05b	TRANSITION - 45" (1145) F-SHAPE TO 54" (1372) VERTICAL SHAPE SHEET 2	1-26-12
	HW-506_03	ENDWALLS FOR PIPE ARCH	9-18-09		HW-821_06	54" (1372) VERTICAL SHAPE BARRIER	2-6-12
✓	HW-507_01	TYPE "C", "C-L" & DROP INLET CATCH BASIN	7-24-13		HW-821_07	MISCELLANEOUS DETAILS FOR BARRIER TRANSITIONS	7-12-12
	HW-507_02	TYPE "C", "C-L" & DOUBLE GRATE TYPE - I	7-24-13		HW-822_01	TEMPORARY PRECAST CONCRETE BARRIER CURB	7-24-13
	HW-507_03	TYPE "C", "C-L" & DOUBLE GRATE TYPE - II	7-24-13		HW-905_01	FENCES AND BARWAYS	7-13-12
	HW-507_04	TYPE "C", "C-L" & ROUND PRECAST CONCRETE CB	11-10-11	✓	HW-910_01	W- BEAM METAL BEAM RAIL HARDWARE	6-09-11
	HW-507_05	TYPE "C" & "C-L" PRECAST CONCRETE CB DOUBLE GRATE TYPE - I	11-10-11	✓	HW-910_02	METAL BEAM RAIL (TYPE R-B 350) GUIDERAIL	6-09-11
	HW-507_06	TYPE "C" & "C-L" PRECAST CONCRETE CB DOUBLE GRATE TYPE - II	11-10-11		HW-910_03	METAL BEAM RAIL (TYPE MD-B 350)	6-09-11
✓	HW-507_07	TYPE "C" & "C-L" CATCH BASIN TOPS AND CURBS	11-10-11		HW-910_04	METAL BEAM RAIL (TYPE R-B 350) SYSTEMS 5, 5A, & 6	6-09-11
✓	HW-507_08	CATCH BASIN FRAMES AND GRATES	9-18-09		HW-910_05	METAL BEAM RAIL R-B 350 SPAN TYPE I, II, III SECTIONS	7-24-13
	HW-507_09	HEAVY DUTY LOCK DOWN TOPS	7-12-12	✓	HW-910_06	R-B 350 BRIDGE ATTACHMENT SAFETY SHAPE PARAPET	6-09-11
✓	HW-507_10	MANHOLE - FRAME & COVER	7-24-13		HW-910_07	R-B 350 BRIDGE ATTACHMENT VERTICAL SHAPE PARAPET	6-09-11
	HW-601_01	FIGURES FOR DATES ON BRIDGE PARAPETS	6-09-11		HW-910_08	R-B 350 BRIDGE ATTACHMENT TRAILING END	6-09-11
✓	HW-651_01	C.C.M. PIPE INSTALLATIONS IN FILL & ROCK SLOPES & PIPE TRENCH DETAIL	7-24-13		HW-910_09a	MISCELLANEOUS GUIDERAIL TRANSITIONS SHEET 1	1-26-12
	HW-651_02	SLOTTED DRAIN PIPE 12"- 15"-18"-24"-30" (305-381-457-610-762)	7-12-12		HW-910_09b	MISCELLANEOUS GUIDERAIL TRANSITIONS SHEET 2	7-25-12
✓	HW-652_01	PIPE ENDS	7-24-13		HW-910_10	METAL BEAM RAIL 8" (203) X 6" (152) BOX BEAM	7-24-13
	HW-751_01	UNDERDRAINS AND UNDERDRAIN OUTLETS	7-12-12		HW-910_11	CURVED GUIDERAIL TREATMENT DETAIL	7-25-12
	HW-803_01	PAVED DITCH AND PAVED APRON	7-12-12		HW-910_12a	MERRITT PARKWAY GUIDERAIL ATTACHMENT - SYSTEM 2 & 3	7-24-13
✓	HW-811_01	CURBING	7-12-12		HW-910_12b	MERRITT PARKWAY GUIDERAIL	7-24-13
	HW-813_01	GRANITE STONE TRANSITION CURBING	7-24-13		HW-910_12c	MERRITT PARKWAY GUIDERAIL TRAILING END ATTACHMENTS	7-24-13
	HW-821_01a	TRANSITION 45" (1145) F-SHAPE TO 45" (1145) VERTICAL SHAPE SHEET 1	1-26-12		HW-910_12d	MERRITT PARKWAY MEDIAN GUIDERAIL AND END ANCHOR	6-09-11
	HW-821_01b	TRANSITION 45" (1145) F-SHAPE TO 45" (1145) VERTICAL SHAPE SHEET 2	10-18-10		HW-910_13a	THRIE-BEAM METAL BEAM RAIL HARDWARE	7-24-13
	HW-821_01c	TRANSITION 45" (1145) F-SHAPE TO 45" (1145) VERTICAL SHAPE SHEET 3	1-26-12		HW-910_13b	THRIE-BEAM TRANSITIONS	7-24-13
✓	HW-821_02a	45" (1145) F-SHAPE PRECAST CONCRETE BARRIER CURB SHEET 1	7-24-13		HW-910_14a	THRIE-BEAM 350 BRIDGE ATTACHMENT	6-09-11
✓	HW-821_02b	45" (1145) F-SHAPE PRECAST CONCRETE BARRIER CURB SHEET 2	7-24-13		HW-910_14b	THRIE-BEAM 350 GUIDERAIL TRANSITION TO R-B 350 GUIDERAIL	6-09-11
	HW-821_03a	TRANSITION - 32" (813) JERSEY SHAPE TO 45" (1145) VERTICAL SHAPE SHEET 1	1-26-12		HW-910_15	MD-B 350 MEDIAN BARRIER SAFETY SHAPE ATTACHMENT TYPE I	6-09-11
	HW-821_03b	TRANSITION - 32" (813) JERSEY SHAPE TO 45" (1145) VERTICAL SHAPE SHEET 2	10-18-10		HW-910_16	MD-B 350 MEDIAN BARRIER SAFETY SHAPE ATTACHMENT TYPE II	6-09-11
	HW-821_03c	TRANSITION - 32" (813) JERSEY SHAPE TO 45" (1145) VERTICAL SHAPE SHEET 3	10-18-10		HW-910_17	R-B TERMINAL SECTION	7-24-13
	HW-821_03d	TRANSITION - 32" (813) JERSEY SHAPE TO 45" (1145) VERTICAL SHAPE SHEET 4	10-18-10		HW-910_18	METAL BEAM RAIL (TYPE MD-I)	10-18-10
	HW-821_03e	TRANSITION - 32" (813) JERSEY SHAPE TO 45" (1145) F-SHAPE	7-24-13		HW-910_19a	METAL BEAM RAIL (MODIFIED TYPE R-I) AND END ANCHORAGE TYPE I	7-24-13
	HW-821_04a	MERRITT PARKWAY NARROW MEDIAN BARRIER	6-09-11		HW-910_19b	METAL BEAM RAIL (MODIFIED TYPE R-I) AND END ANCHORAGE TYPE II	7-24-13
	HW-821_04b	MERRITT PARKWAY - 2' (610) WIDE MEDIAN BARRIER AND ROADSIDE BARRIER	7-24-13		HW-910_19c	METAL BEAM RAIL (MODIFIED TYPE R-I) SYSTEMS 2 AND 3	7-24-13


***ONLY STANDARD SHEETS MARKED WITH AN "✓" ARE IN THIS PROJECT #**

****REVISED OR ADDED**


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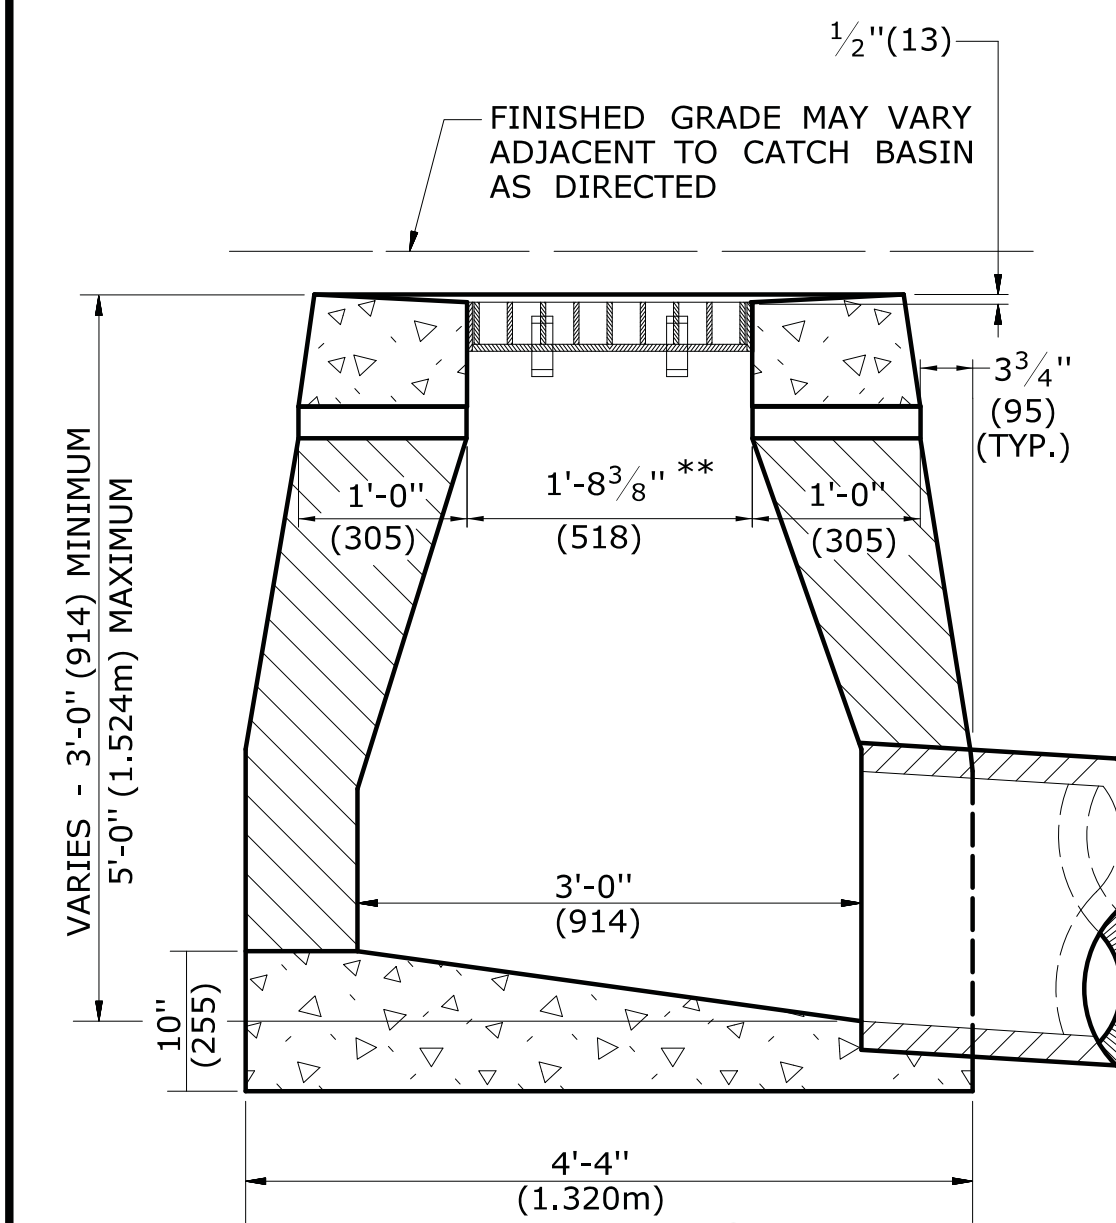
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TYPE "C-L" CATCH BASIN

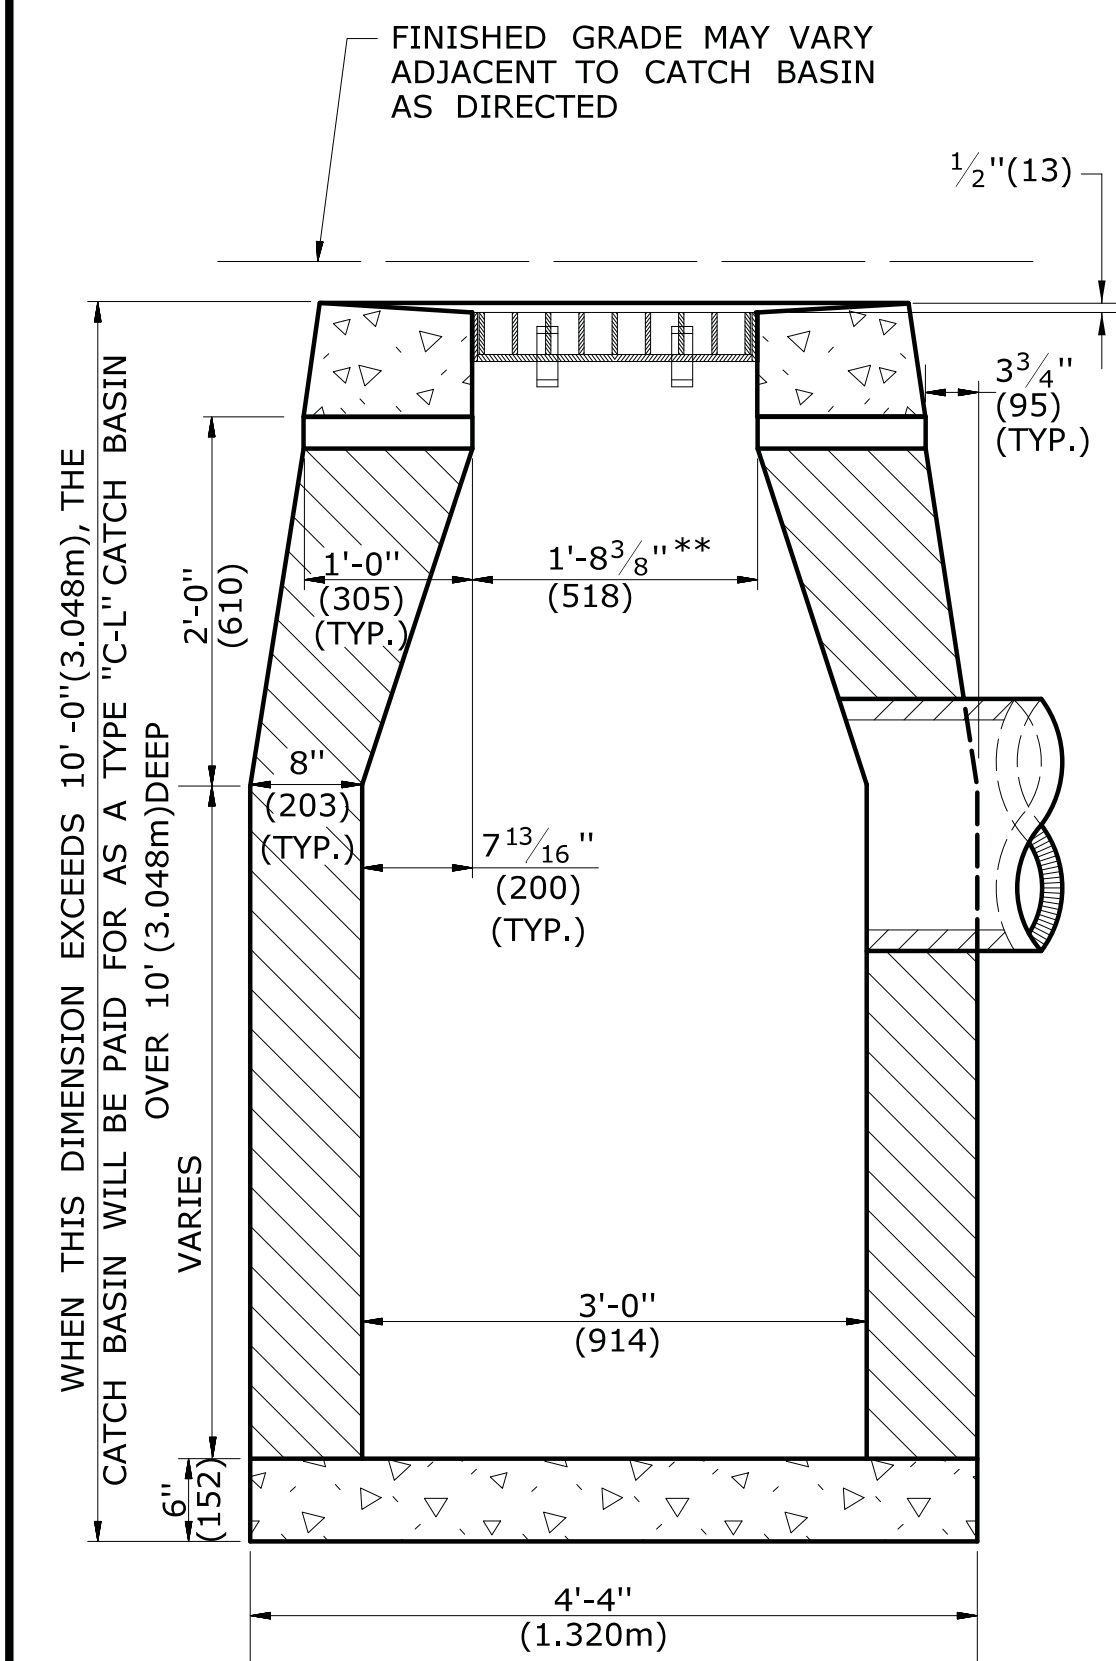


SECTION A
**TYPE "C" & "C-L" CATCH BASIN
(TYPE "C" TOP SHOWN)**

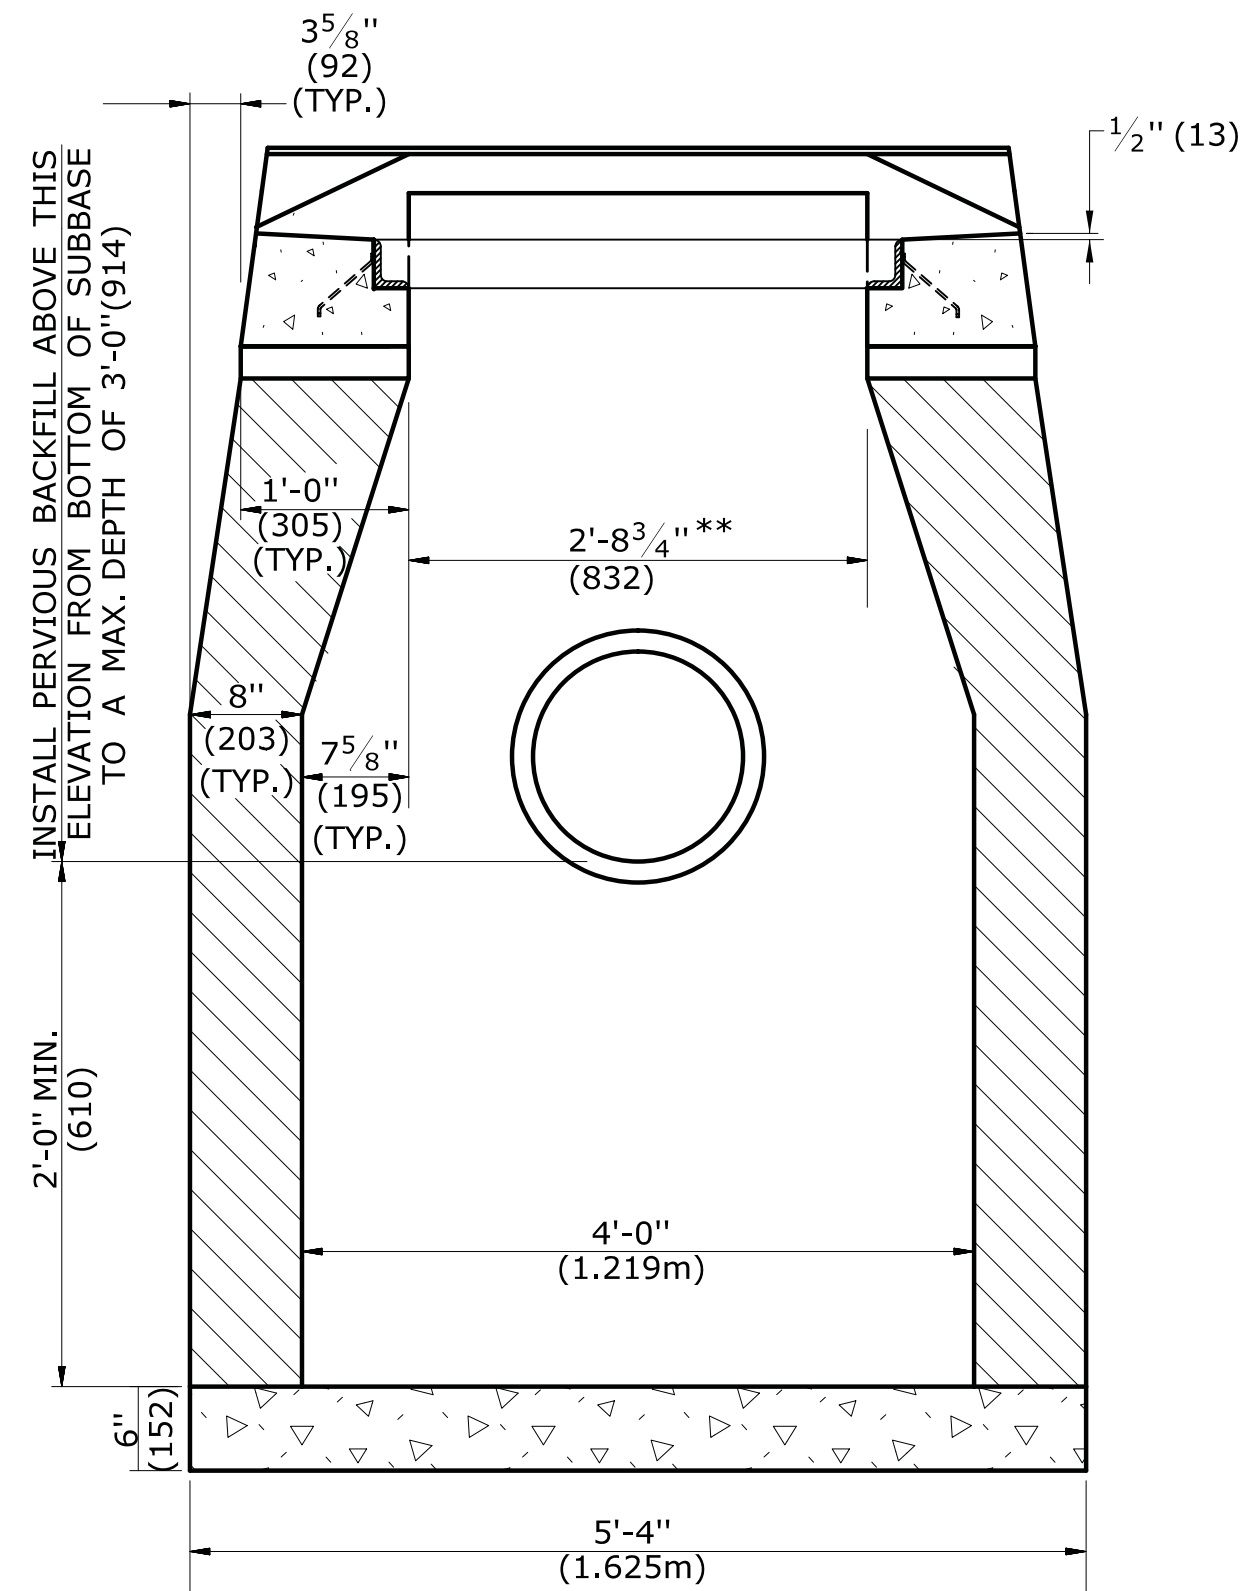


SECTION B
TYPE "C" CATCH BASIN

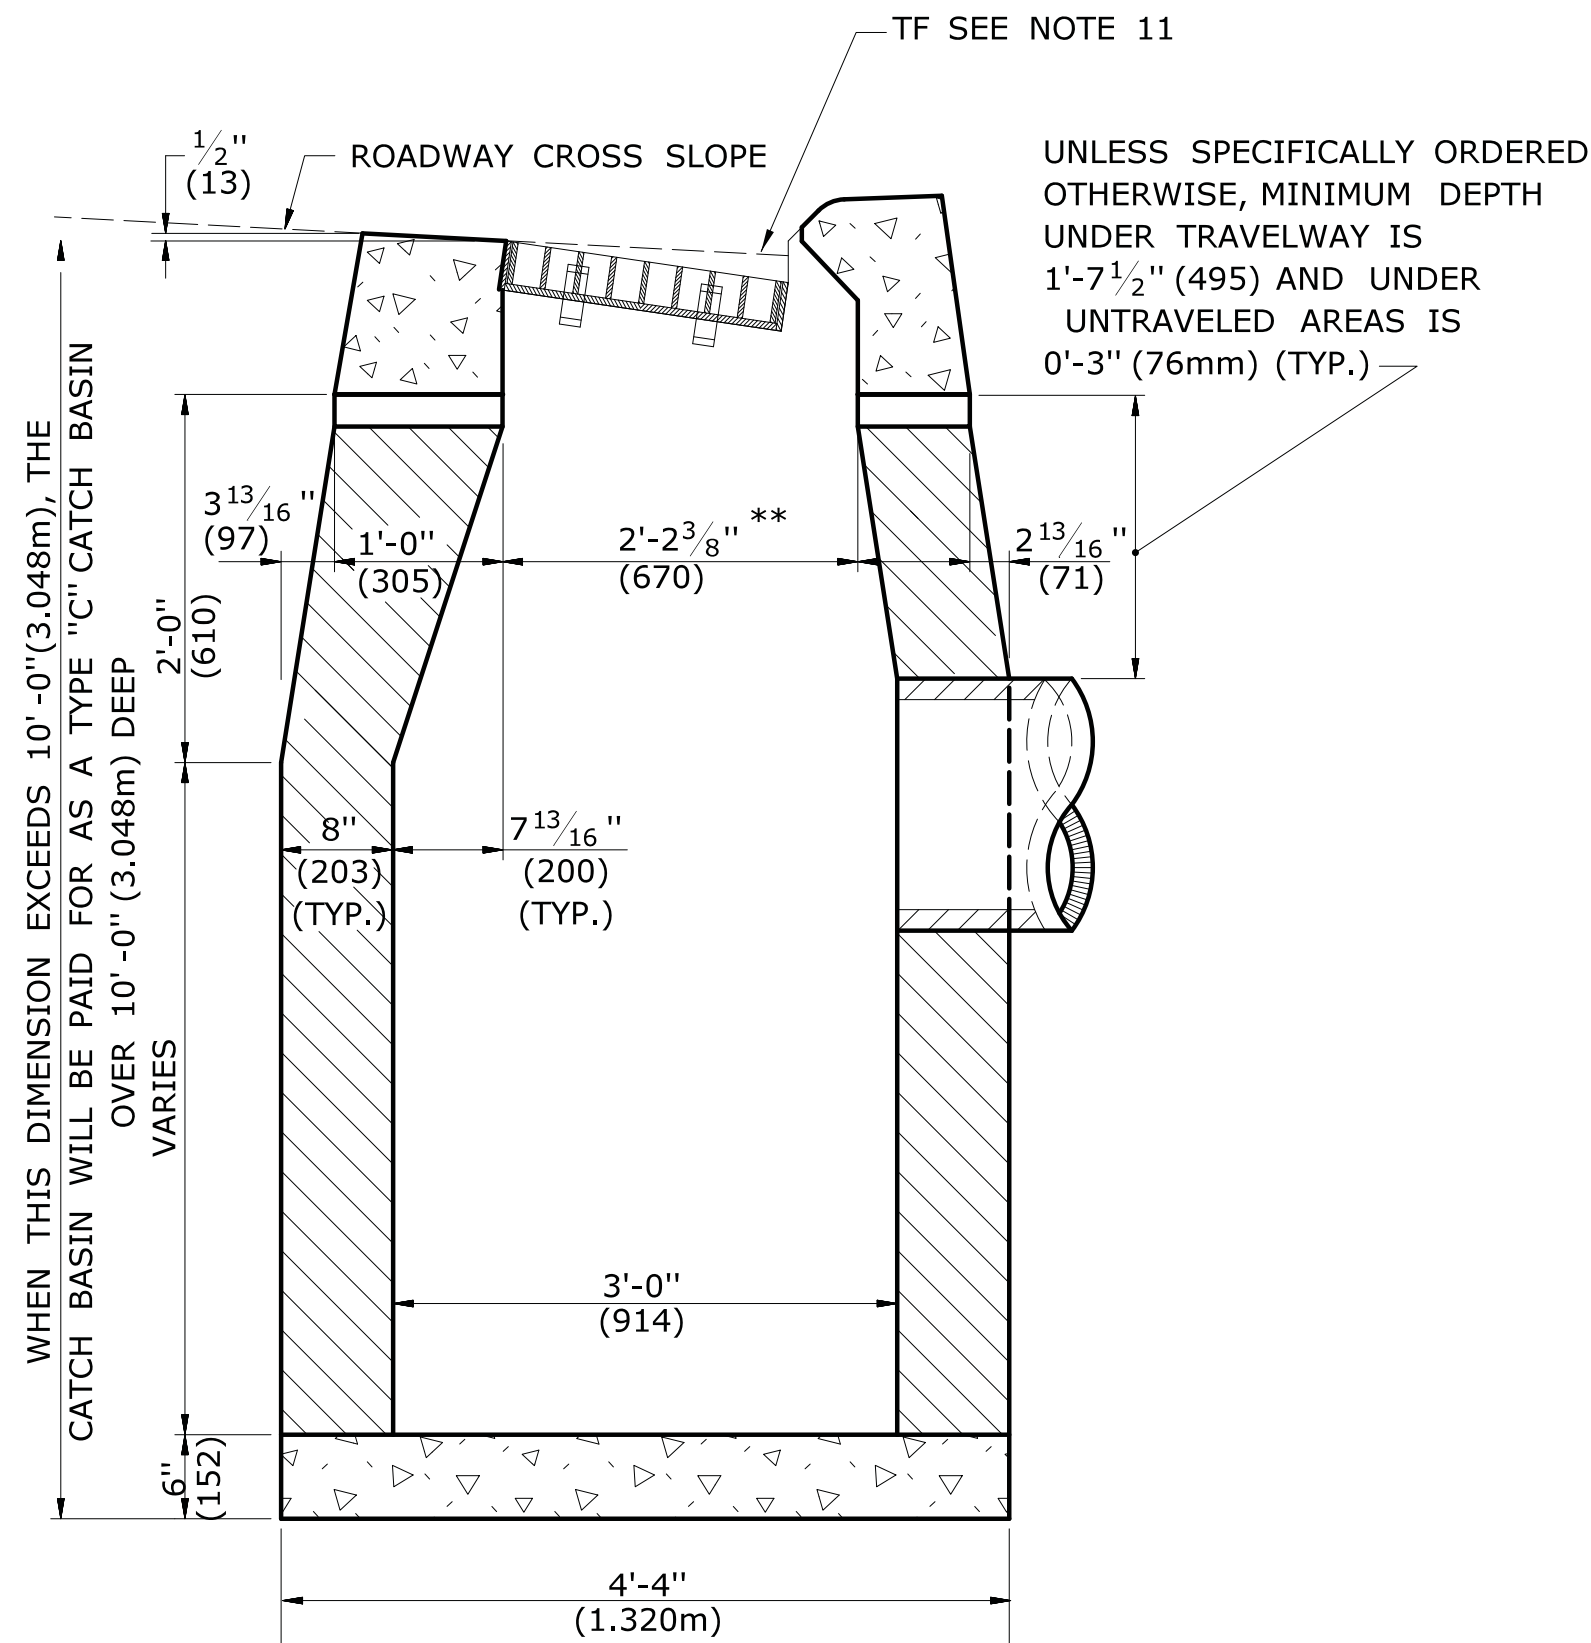

SECTION B
TYPE "C-L" DROP INLET

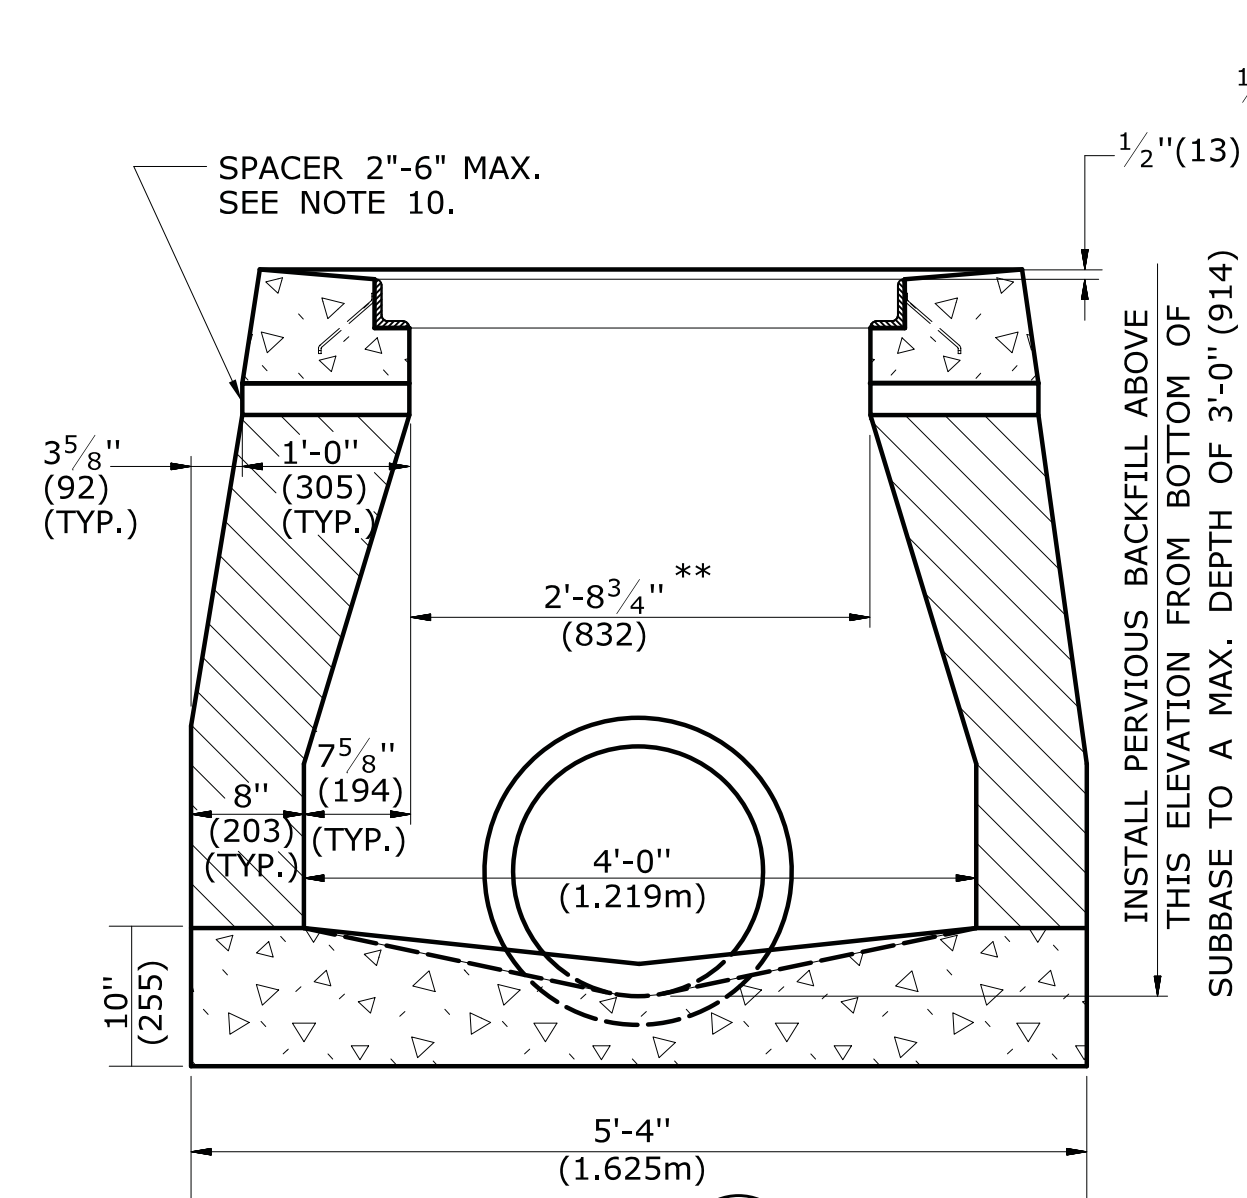


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**TYPE "C" & "C-L" DROP INLET
(TYPE "C-L" TOP SHOWN)**

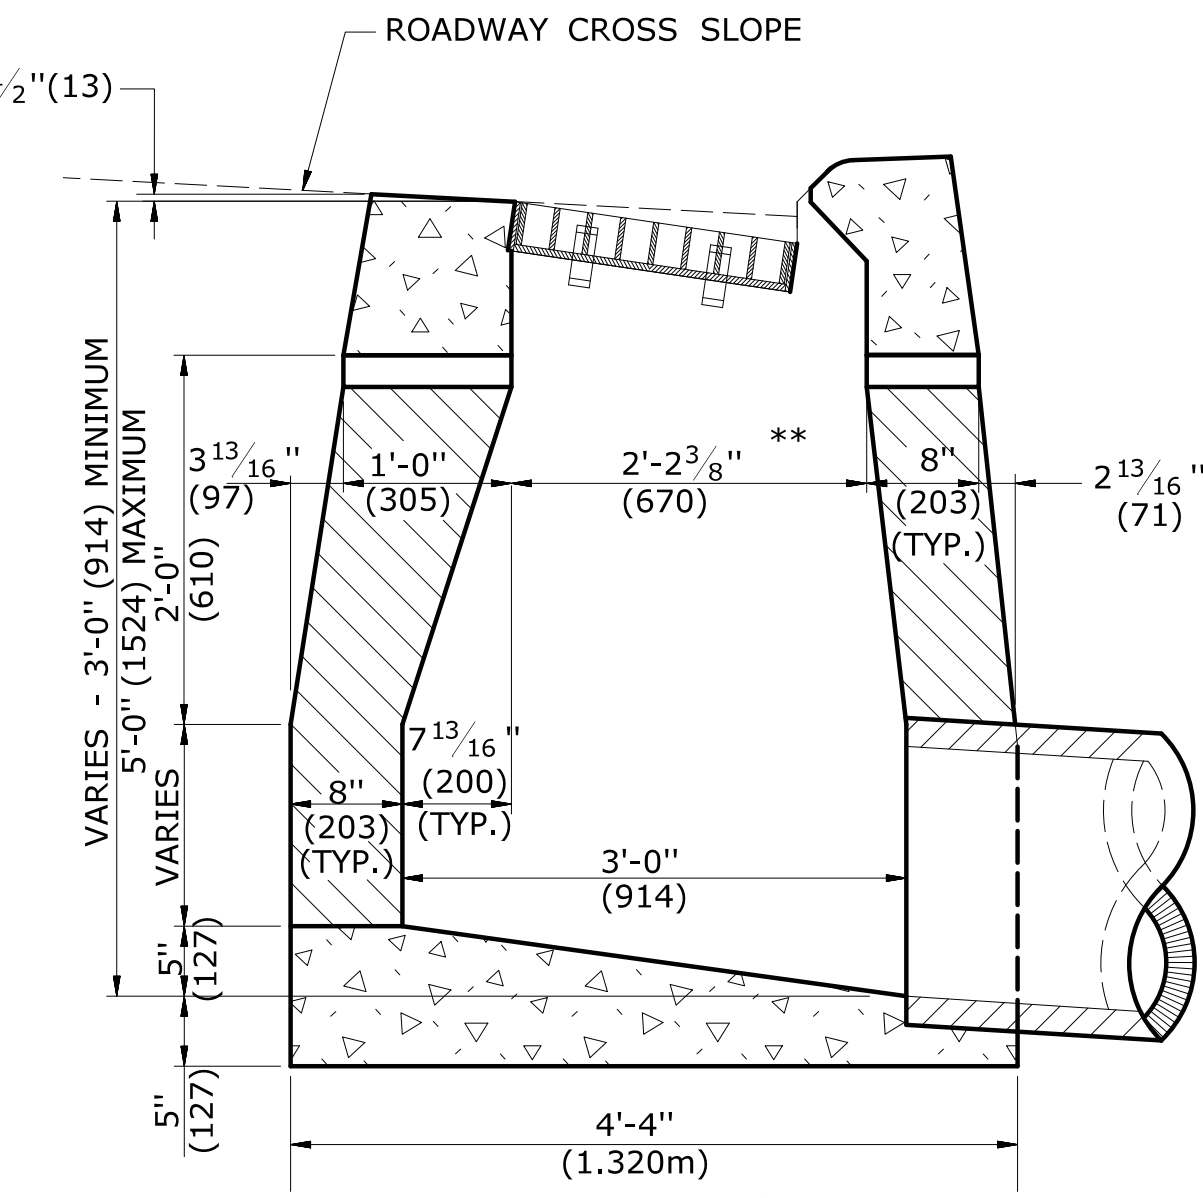


SECTION B
TYPE "C" DROP INLET

GENERAL NOTES:


- FOR DETAILS OF FRAME AND GRATE SEE STANDARD SHEET HW-507-08.
- USE APPROPRIATE CONCRETE TOP FOR CURBING SHOWN ON PLANS. IF CURBING IS NOT SPECIFIED ON THE PLANS, IT SHALL BE CONSTRUCTED AS DIRECTED BY THE ENGINEER.
- ALL FACES OF STRUCTURES IN CONTACT WITH CONCRETE PAVEMENT SHALL BE COVERED WITH A LAYER OF TAR PAPER OR APPROVED EQUAL. THE COST FOR THE PAPER SHALL BE INCLUDED IN THE BID PRICE FOR THE TYPE OF CATCH BASIN INSTALLED.
- USE 6'-0" (1.830m) ON UPGRADE SIDE OF CONTINUOUS GRADE AND 1'-0" (305mm) ON DOWNGRADE SIDE OF CONTINUOUS GRADE OR AS DIRECTED.
- IF MASONRY UNITS ARE REQUIRED, THE BASIN SHALL BE CONSTRUCTED IN CONFORMANCE WITH THE OVER ALL DIMENSIONS SHOWN HERE AND SECTION 5.07 OF THE STATE OF CONNECTICUT'S STANDARD SPECIFICATIONS. CORBELLING SHALL BE PERMITTED TO A MAXIMUM OF 3" (75mm.) NO PROJECTION SHALL EXTEND INSIDE THE LIMITS NOTED BY **.
- WALL THICKNESS OF ALL CB'S OVER 10' (3.048m) DEEP SHALL BE INCREASED TO 12" (305mm) THICK. INSIDE DIMENSION SHALL REMAIN THE SAME. 12" (305mm) THICKNESS WILL START AFTER THE FIRST 10' (3.048m).
- TO CONVEY SUBSURFACE DRAINAGE, OPENINGS SHALL BE FORMED IN THE FOUR WALLS AT OR IMMEDIATELY ABOVE THE BOTTOM OF THE PERVIOUS BACKFILL.
- MINIMUM CONCRETE COMPRESSIVE STRENGTH OF F'c = 4000 PSI (27,580 kPa) SHALL BE OBTAINED PRIOR TO SHIPPING.
- LATEST STATE OF CONNECTICUT'S STANDARD SPECIFICATIONS AND SUPPLEMENTALS SHALL GOVERN.
- SPACER MAY BE CMU OR PRECAST WITH REQUIRED REINFORCING (RECOMMENDED BY THE MANUFACTURER) AS NEEDED TO PROVIDE PROPER GRADE SHOWN ON PLANS.
- TOP OF FRAME (TF) ELEVATION SHALL BE MEASURED IN THE CENTER OF GRATE @ GUTTER LINE.

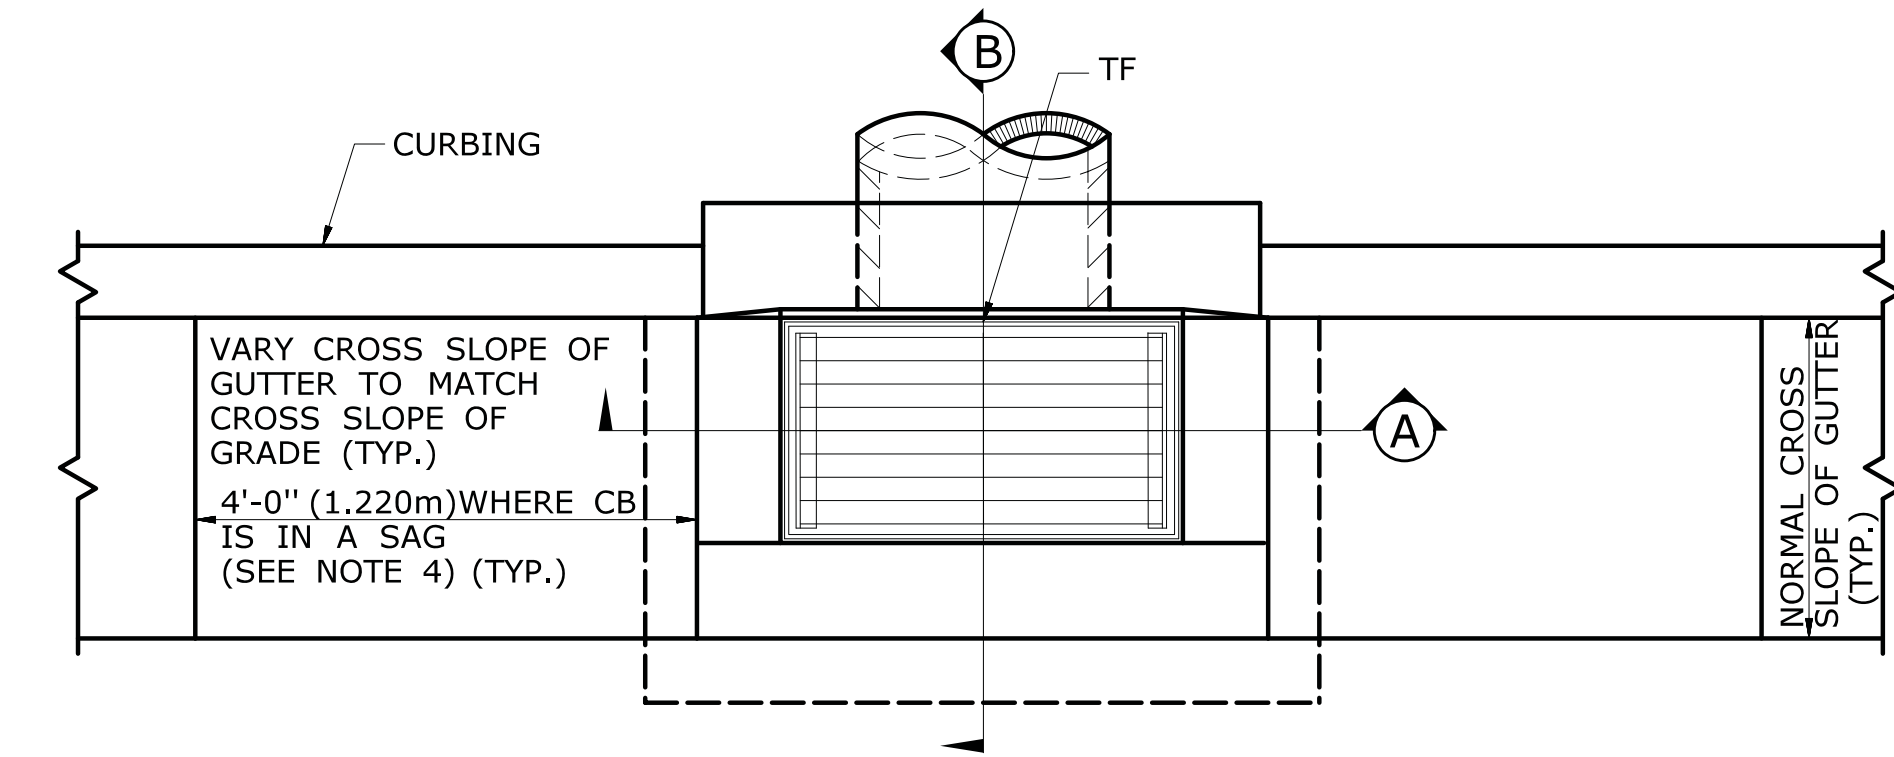


PLAN

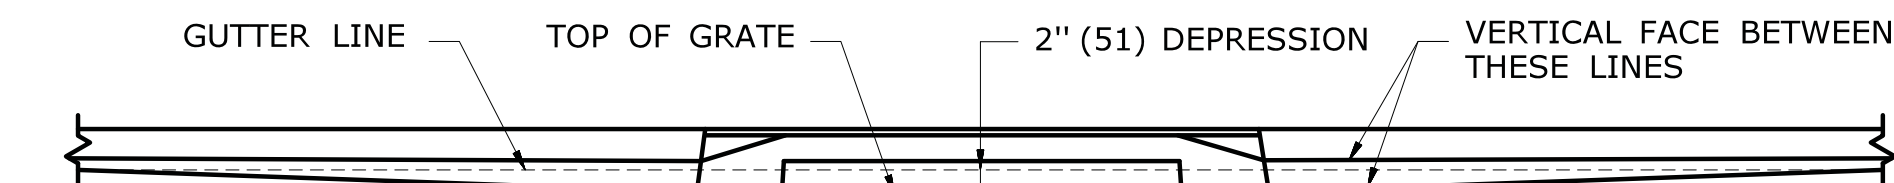


FOR CATCH BASINS IN A LINE OF 4" (102) CONCRETE PARK CURBING OR 4" (102) BITUMINOUS CONCRETE PARK CURBING

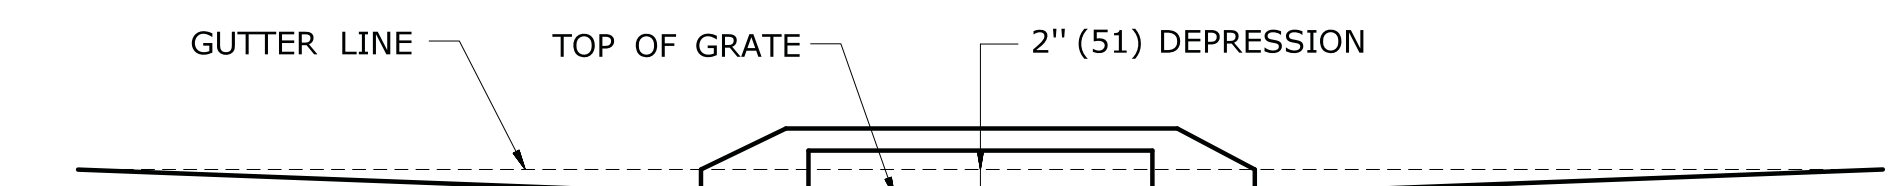

FOR CATCH BASINS WHERE NO CURBING OF ANY TYPE EXISTS OR IS PROPOSED

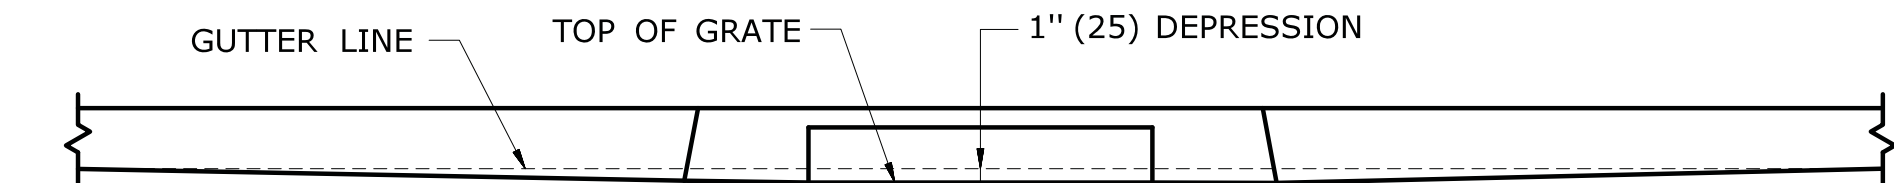

FOR CATCH BASINS IN A LINE OF 6" (152) CONCRETE CURBING OR 6" (152) STONE CURBING




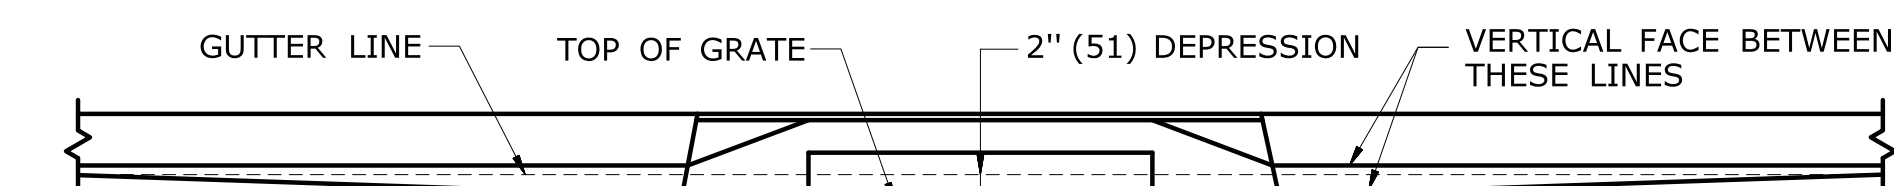


FOR CATCH BASINS IN A LINE OF 6" (152) BITUMINOUS CONCRETE LIP CURBING (MACHINE FORMED)

DETAILS OF DEPRESSED GUTTER STRIP FOR TYPE "C" CATCH BASIN











ALL METRIC DIMENSIONS ARE IN MILLIMETERS (mm) UNLESS OTHERWISE NOTED.




4	7/13	ADD NOTE 11	-	THE INFORMATION, INCLUDING ESTIMATED QUANTITIES OF WORK, SHOWN ON THESE SHEETS IS BASED ON LIMITED INVESTIGATIONS BY THE STATE AND IS IN NO WAY WARRANTED TO INDICATE THE CONDITIONS OF ACTUAL QUANTITIES OF WORK WHICH WILL BE REQUIRED.	NOT TO SCALE	STATE OF CONNECTICUT DEPARTMENT OF TRANSPORTATION	FILENAME: CTDOT.HIGHWAY.STD2013.dgn	SUBMITTED BY: NAME/DATE/TIME:	CTDOT STANDARD SHEET	STANDARD SHEET TITLE: TYPE "C", "C-L" & DROP INLET CATCH BASIN	STANDARD SHEET NO.: HW-507_01
3	9/30/11	ADD SPACERS AND NOTE 10.	-					APPROVED BY: NAME/DATE/TIME:	OFFICE OF ENGINEERING		
2	9/15/11	MODIFIED DETAILS TO BE CONSISTANT WITH PRECAST	-								
1	7/28/11	REMOVE MIN. DROP NOTE	-								
REV.	DATE	REVISION DESCRIPTION		Plotted Date: 6/10/2013							

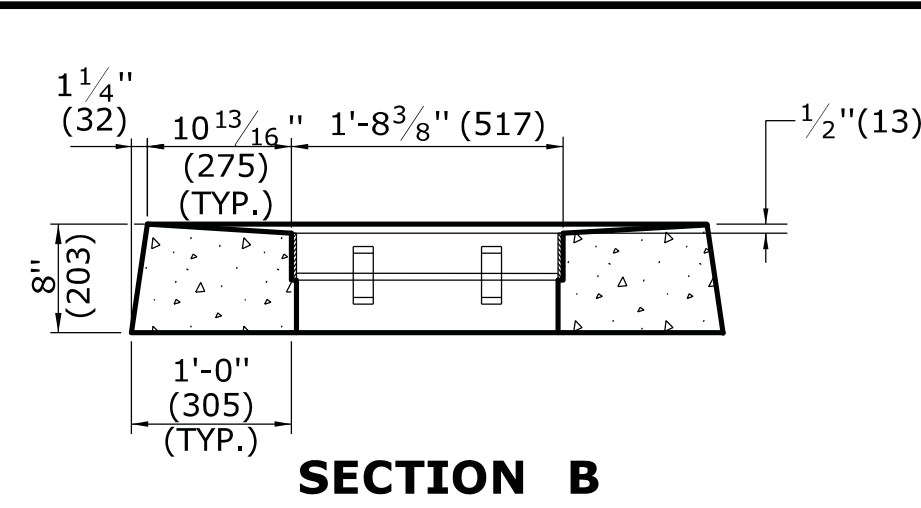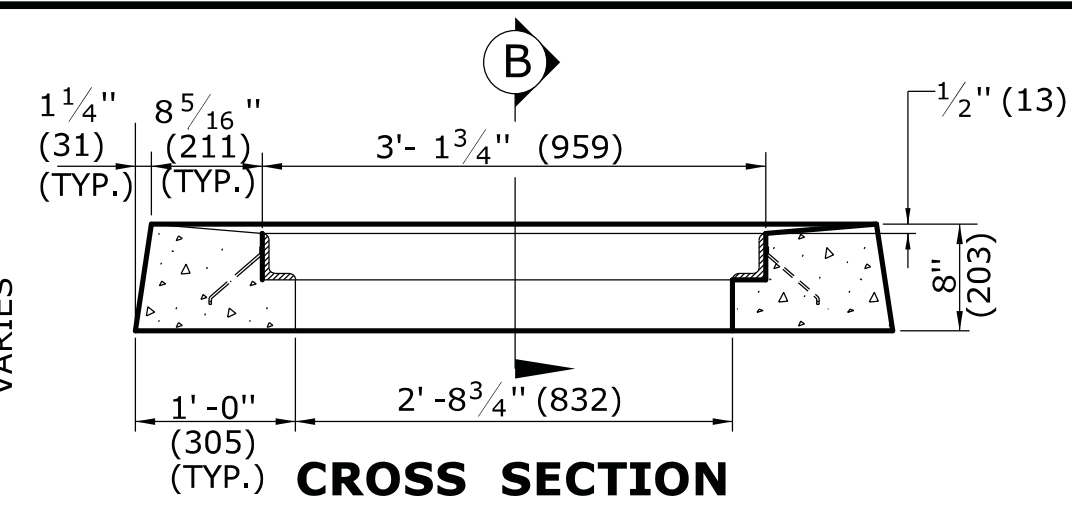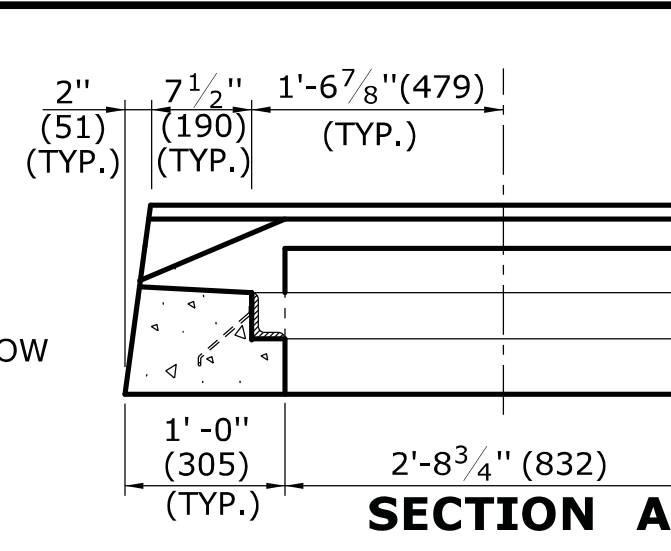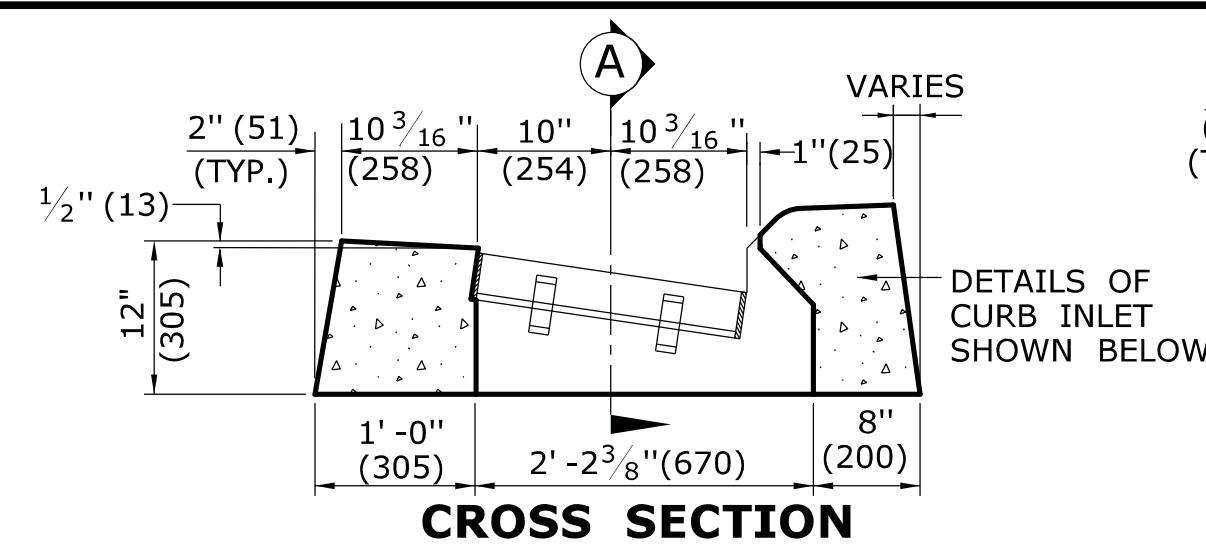

GENERAL NOTES:

1. FOR DETAILS OF FRAME AND GRATE SEE STANDARD SHEET HW-507-08.
2. ALL STEEL, EXCEPT REINFORCING BARS, SHALL BE GALVANIZED IN CONFORMANCE WITH SECTION M06.03 OF CONNECTICUT'S STANDARD SPECIFICATIONS.
3. ALL BARS SHALL HAVE A MINIMUM 2" (51) COVER.

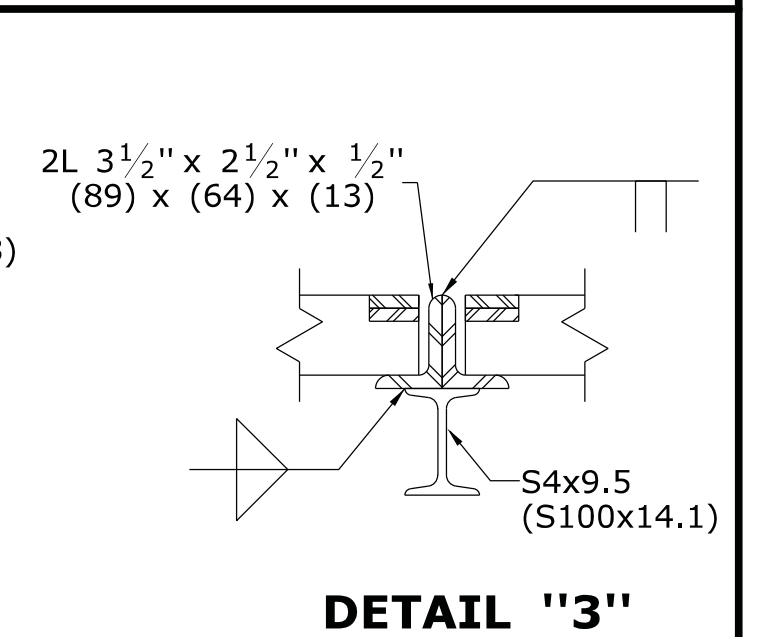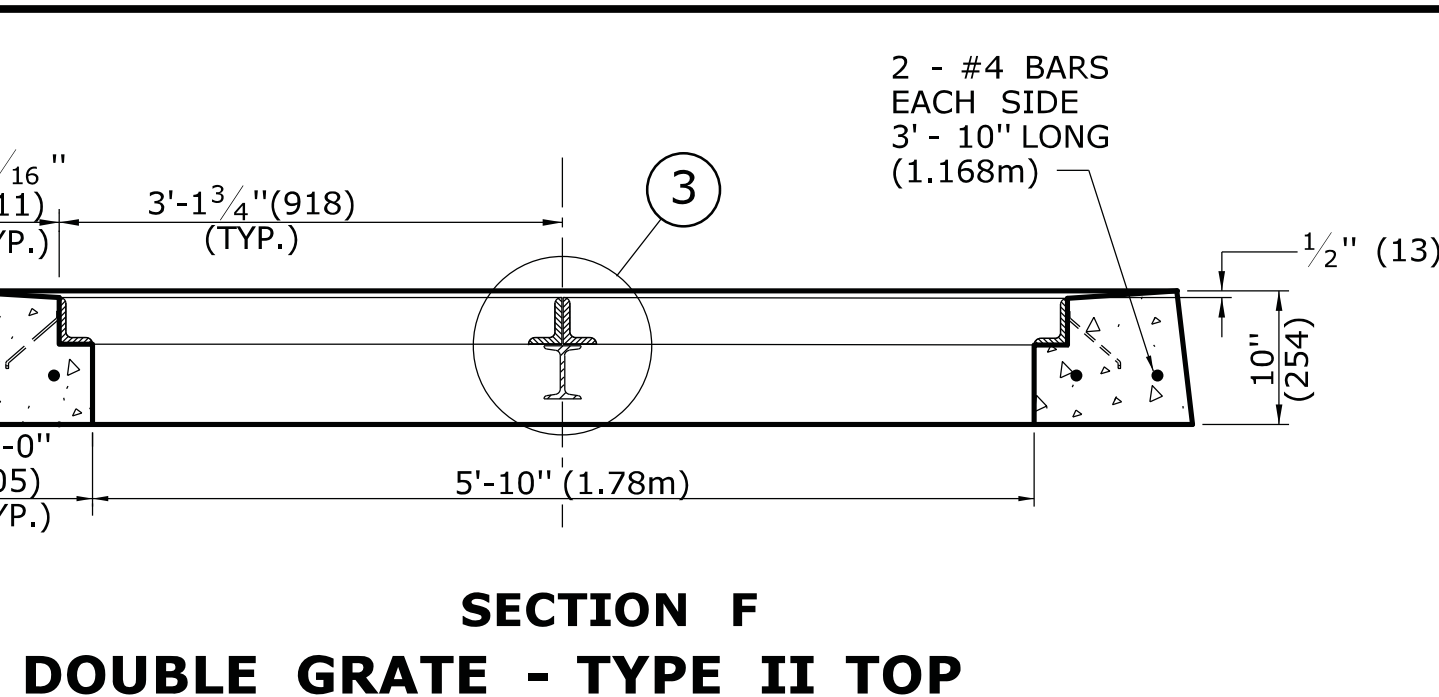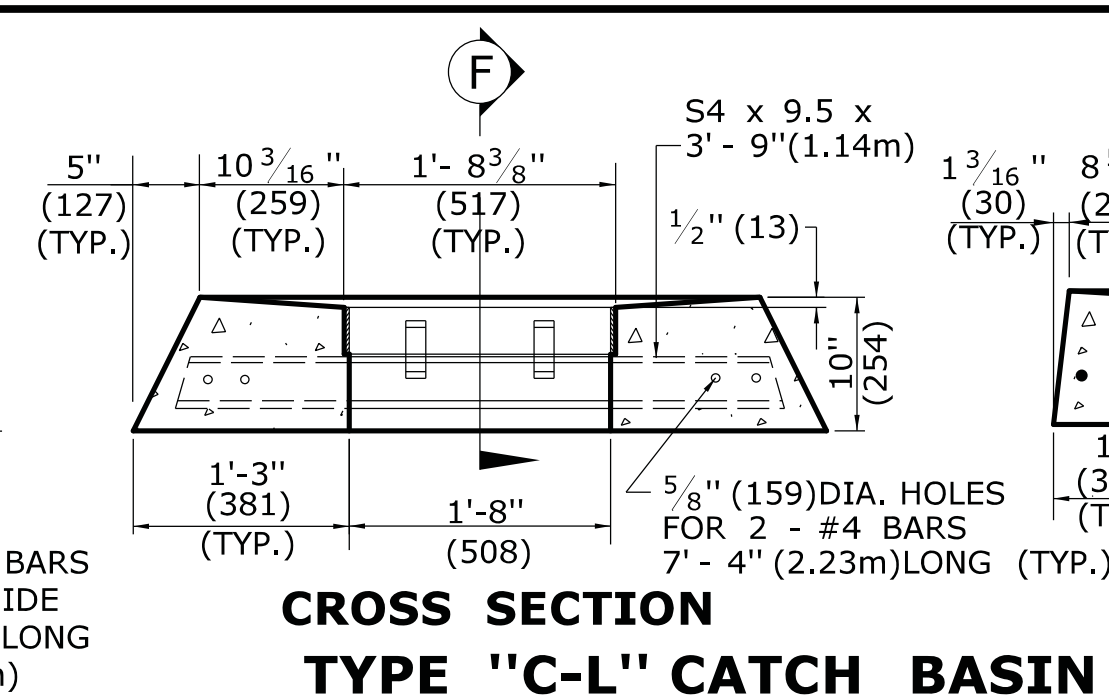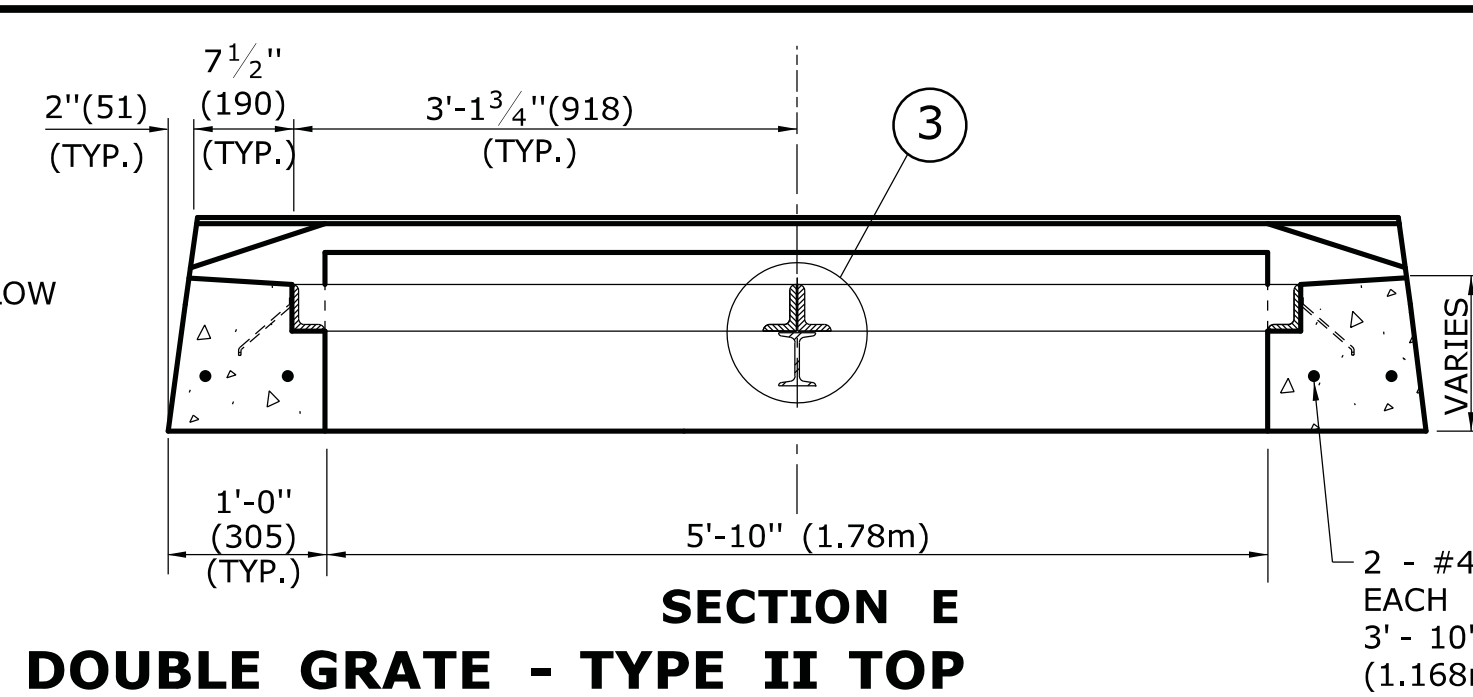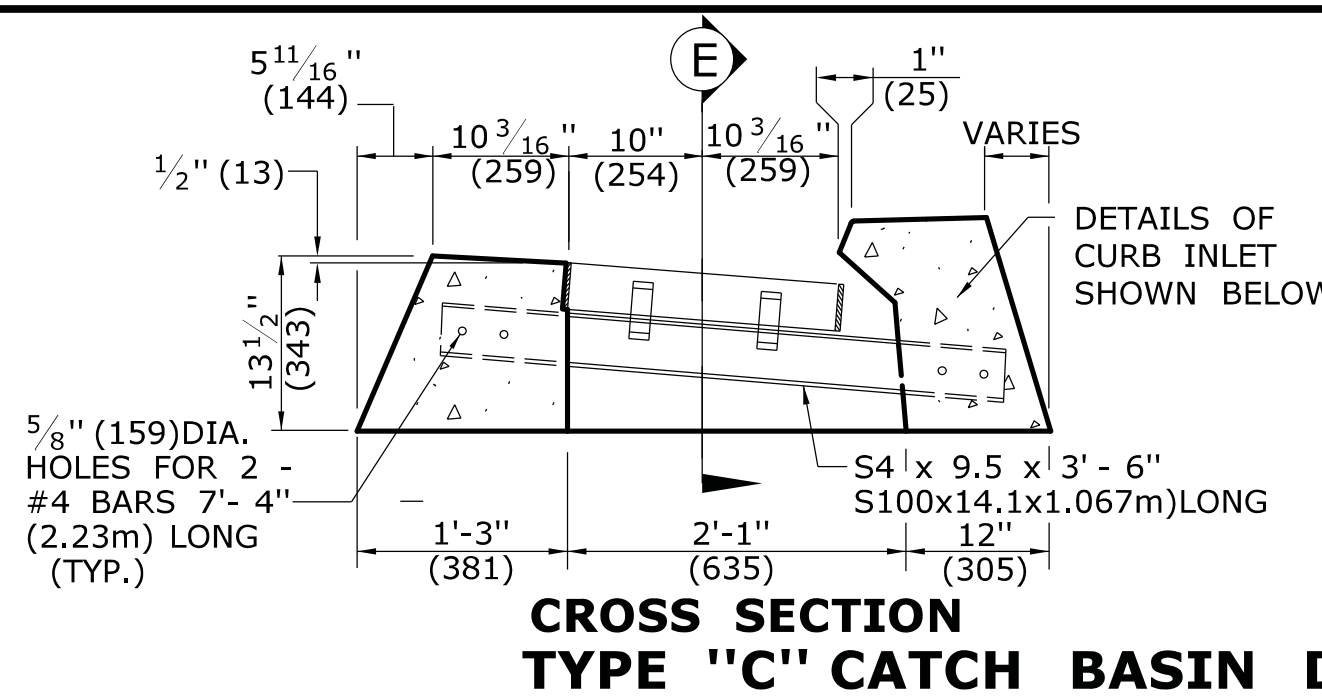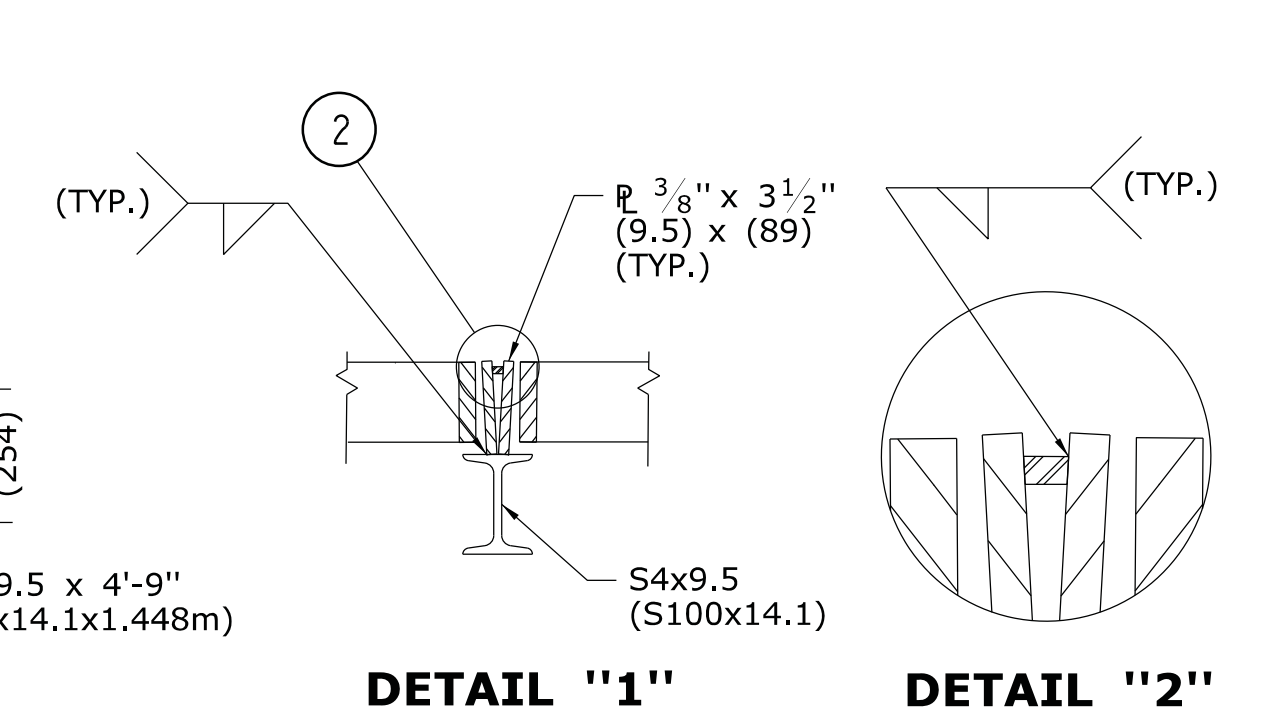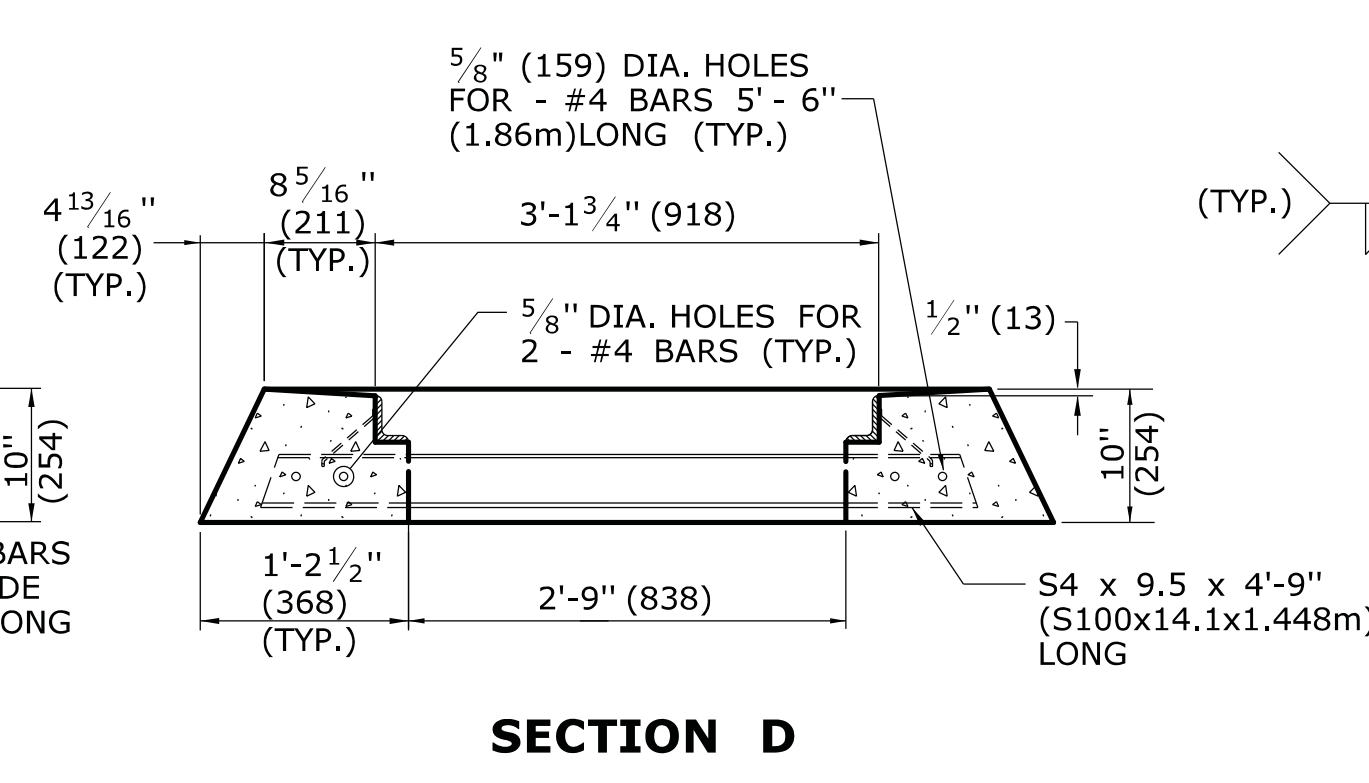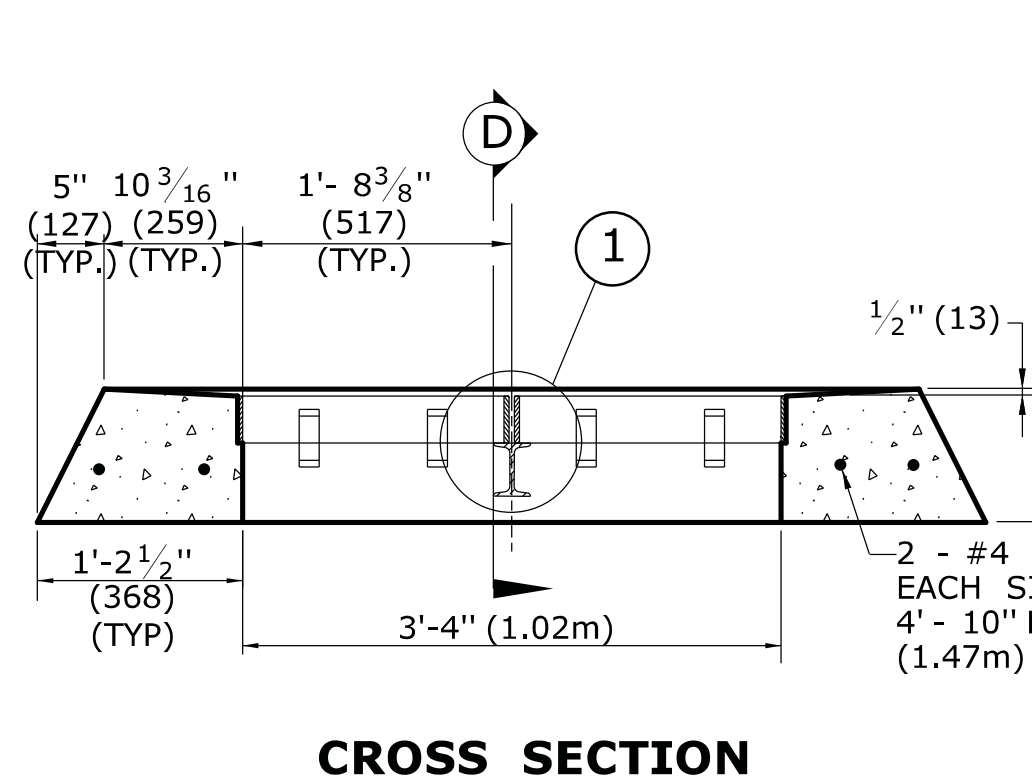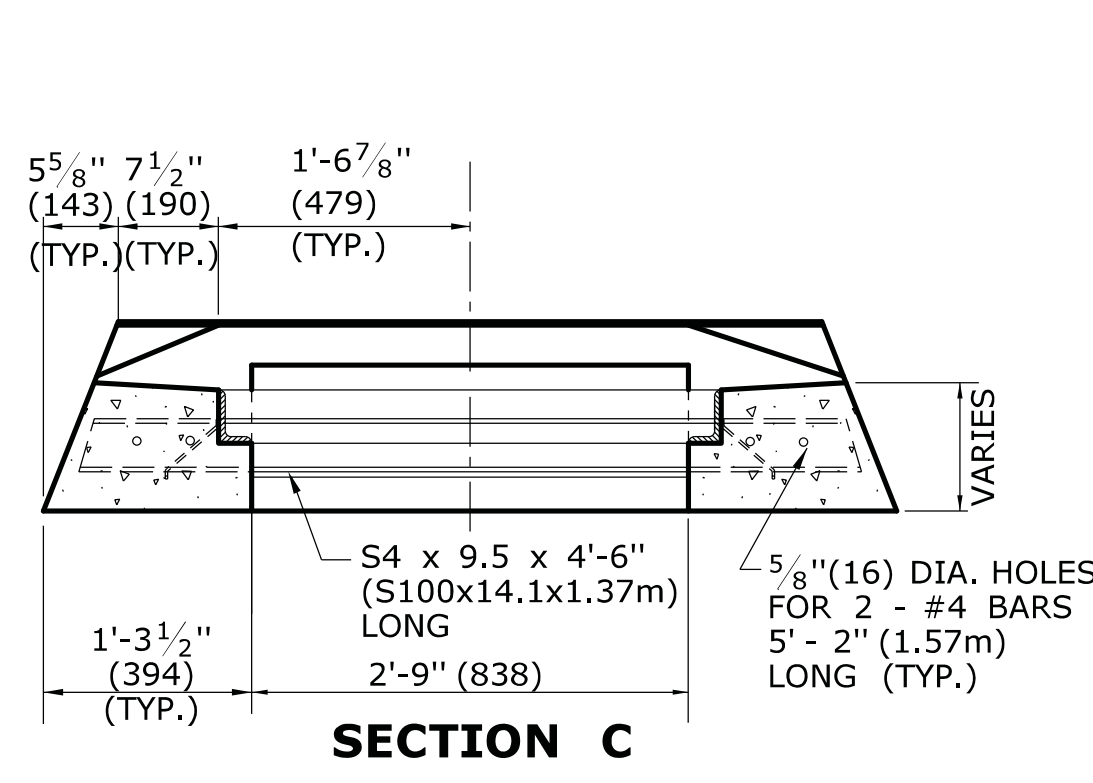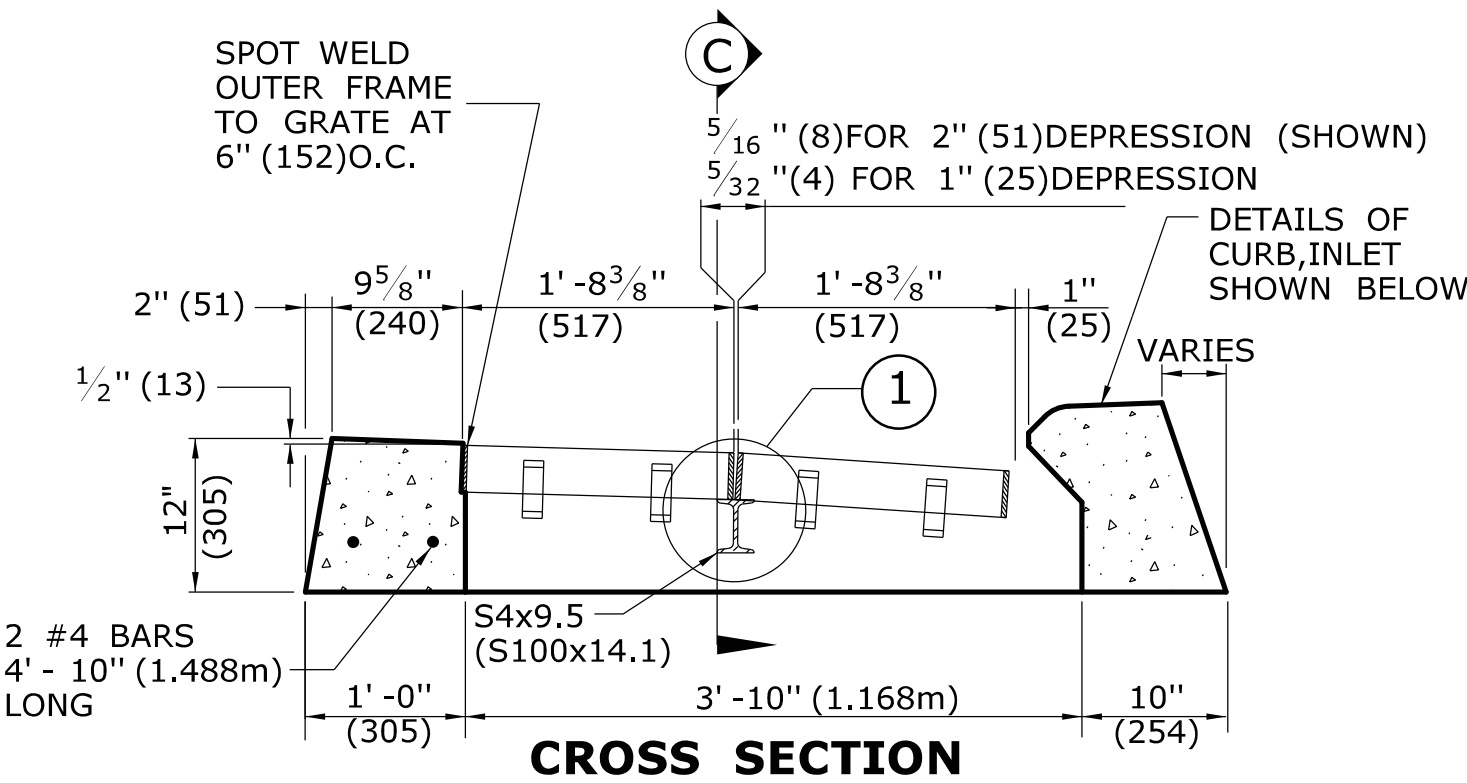

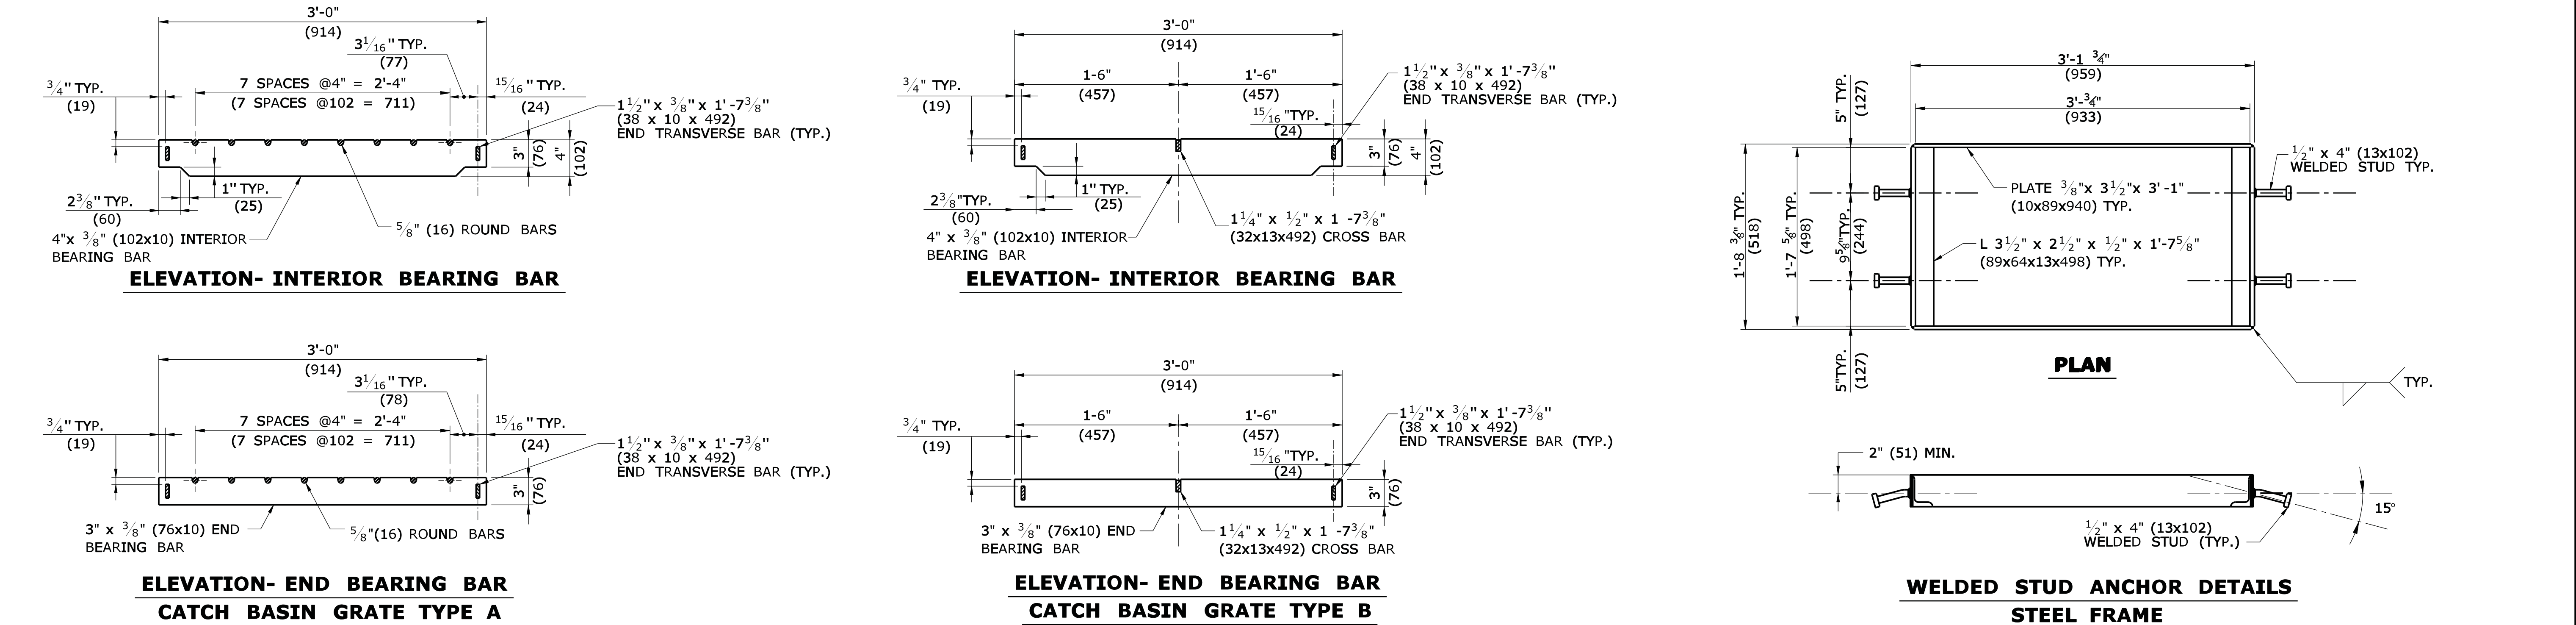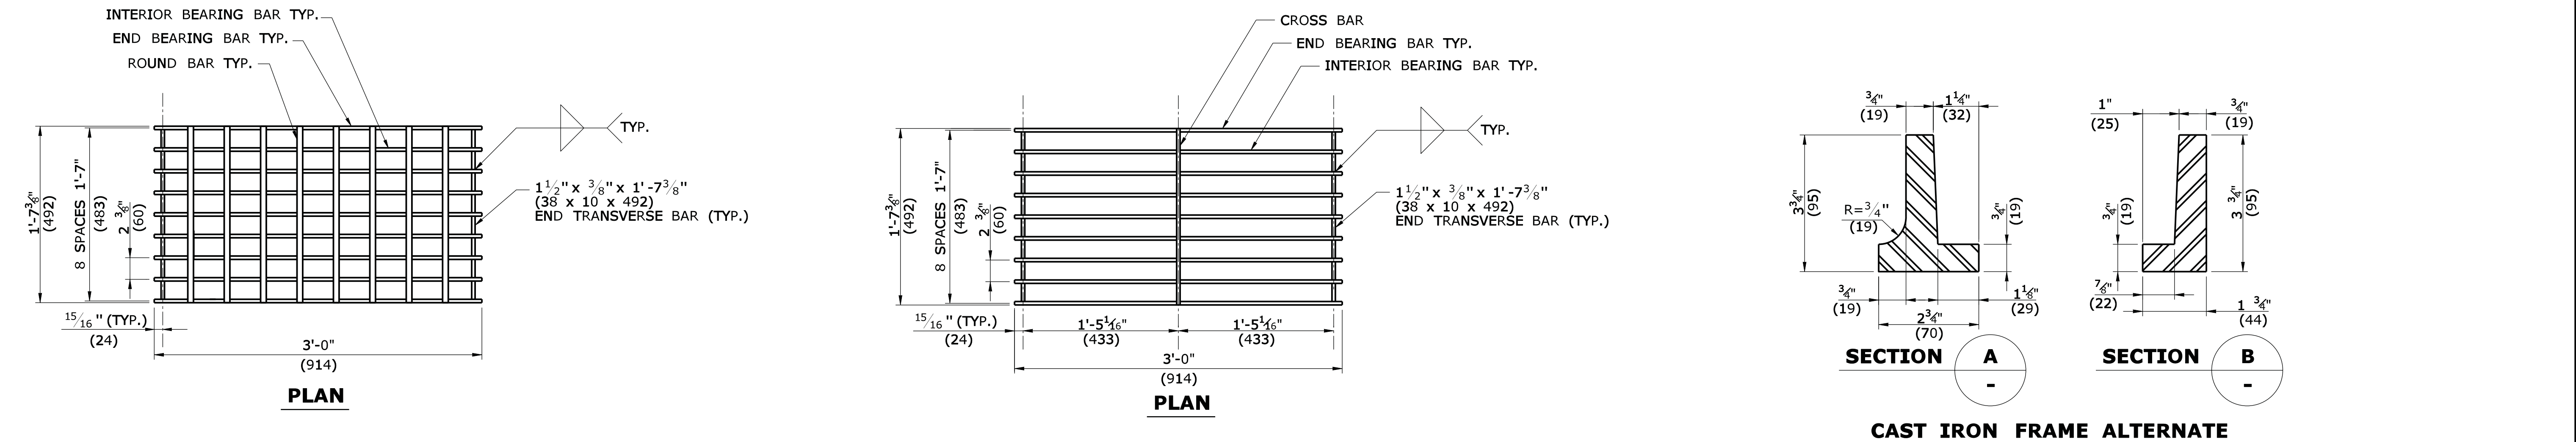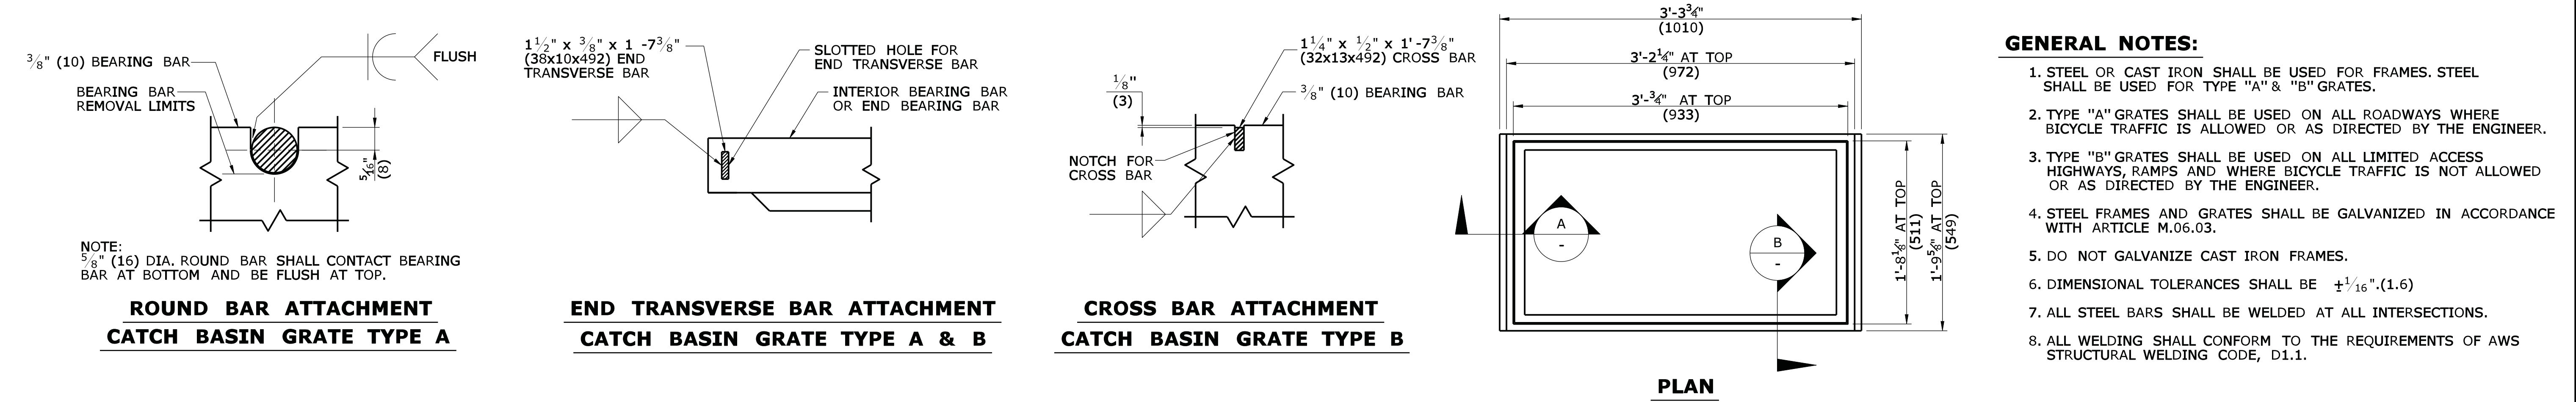

ALL METRIC DIMENSIONS ARE IN MILLIMETERS (mm) UNLESS OTHERWISE NOTED			STANDARD SHEET TITLE:		STANDARD SHEET NO.:	
THE INFORMATION, INCLUDING ESTIMATED QUANTITIES OF WORK, SHOWN ON THESE SHEETS IS BASED ON LIMITED INVESTIGATIONS BY THE STATE, AND IS IN NO WAY WARRANTED TO INDICATE THE CONDITIONS OF ACTUAL QUANTITIES OF WORK WHICH WILL BE REQUIRED.			CATCH BASIN FRAMES AND GRATES		HW-507_08	
NOT TO SCALE			OFFICE OF ENGINEERING			
Plotted Date: 9/11/2009						
Filename: CTDOT_HIGHWAY STD.dgn Model: HW-507_08						
Submitted By: NAME/DATE/TIME:			CTDOT STANDARD SHEET			
Approved By: NAME/DATE/TIME:			OFFICE OF ENGINEERING			
REV. DATE			REVISION DESCRIPTION			

GENERAL NOTES:




1. CHANNELS MAY BE SHAPED IN CONCRETE BASE OF MANHOLE OR FORMED USING BRICK OR MASONRY.
2. A FRAME DIAMETER OF 3'-3" (991) WITH 4" (102) FLANGE MUST BE USED WHEN THE TOP DIAMETER OF THE PRECAST CONE IS LESS THAN 3'-6" (1067). ALL OTHER FRAME DIMENSIONS SHALL REMAIN THE SAME.
3. COVER:

CAST IRON


STEEL

MIN. COVER WEIGHT


134LB.(61kg)134LB.(61kg)
4. ALL DIMENSIONS SUBJECT TO MANUFACTURING TOLERANCES.

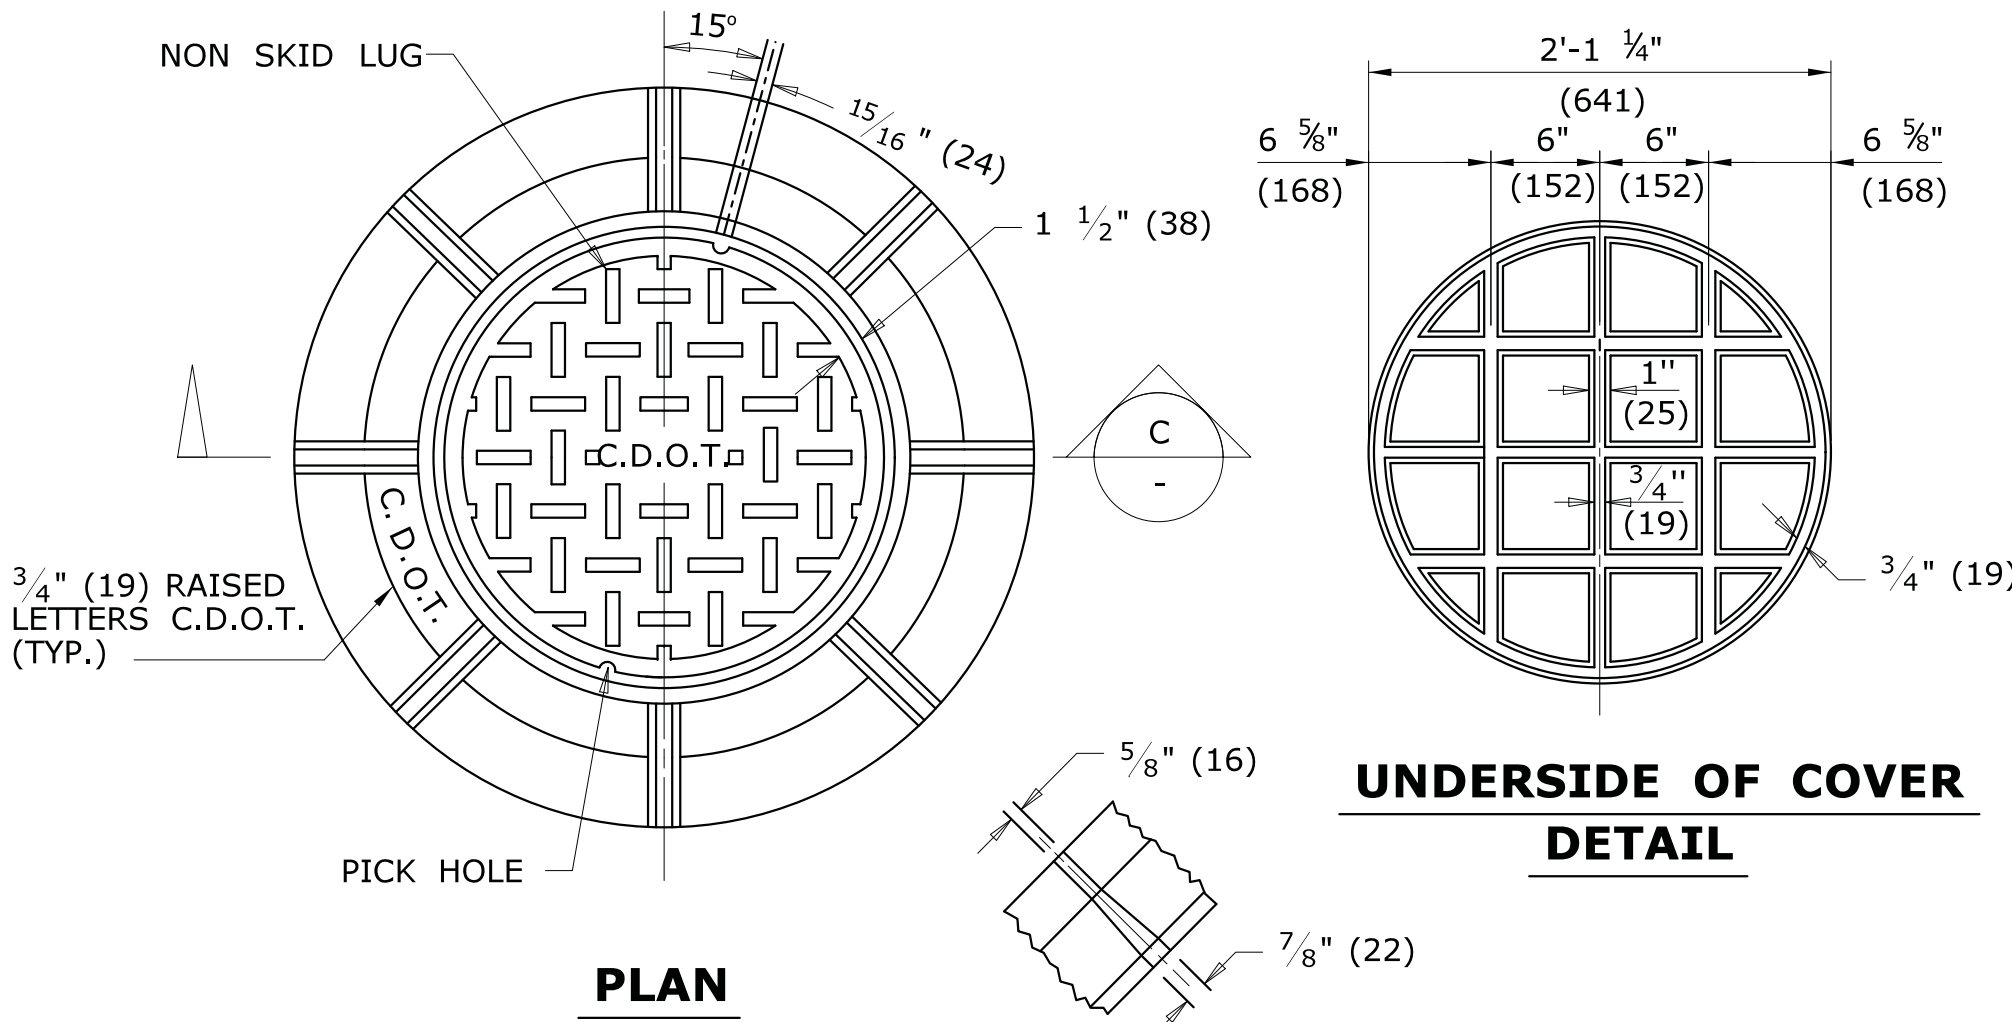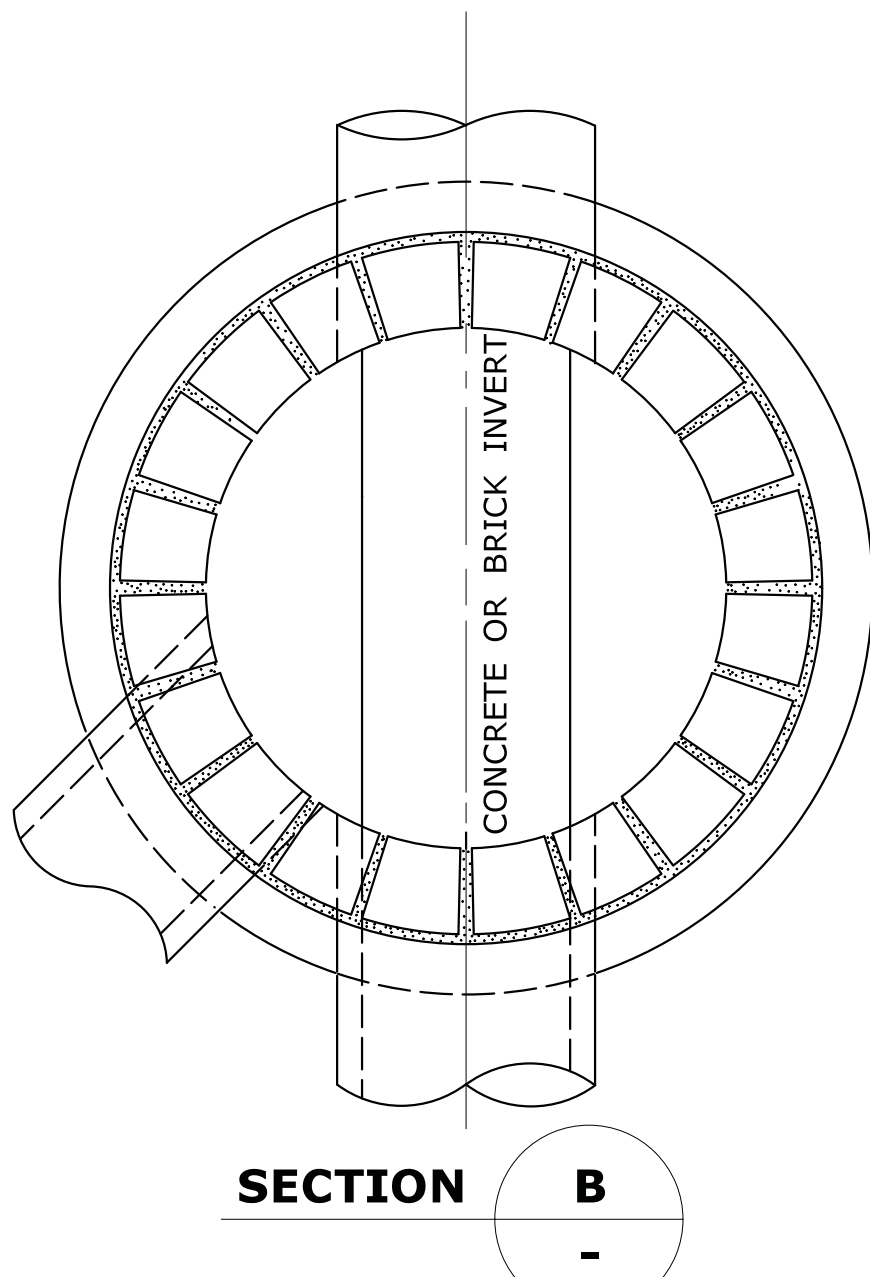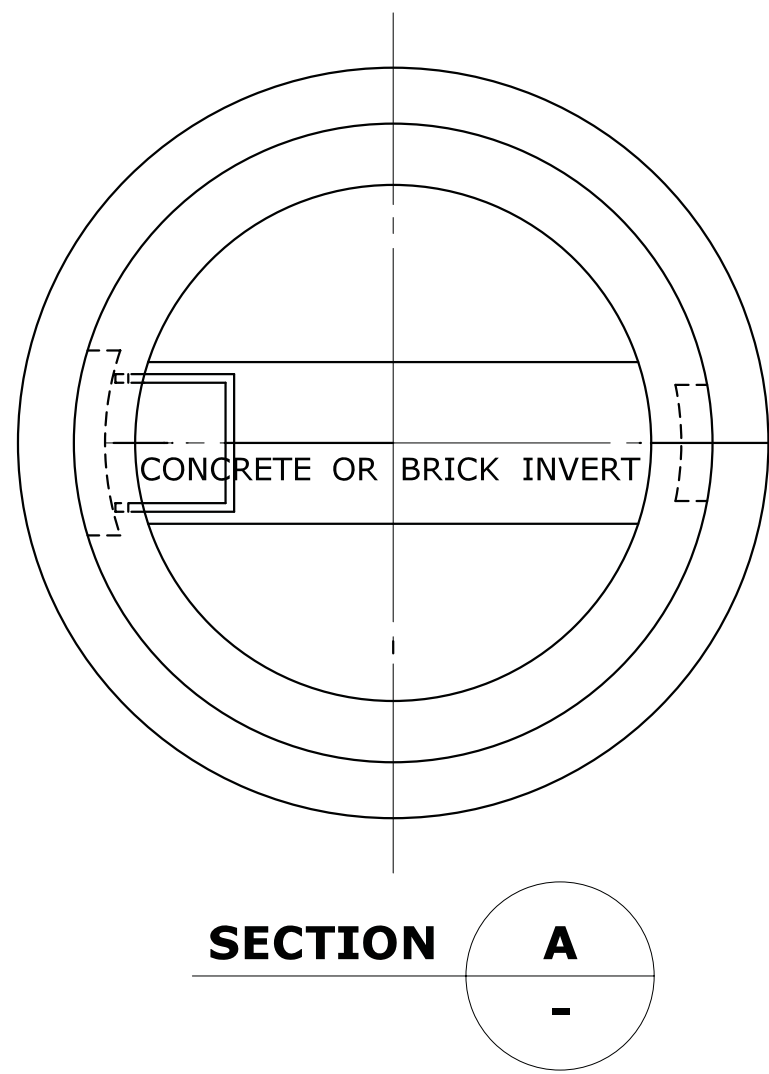


UNDERSIDE OF COVER
DETAIL

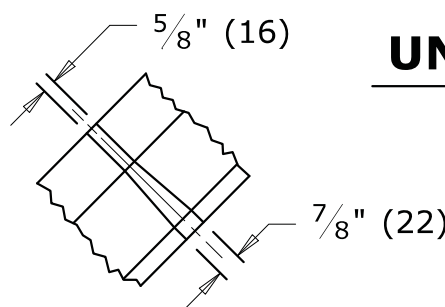


PLAN

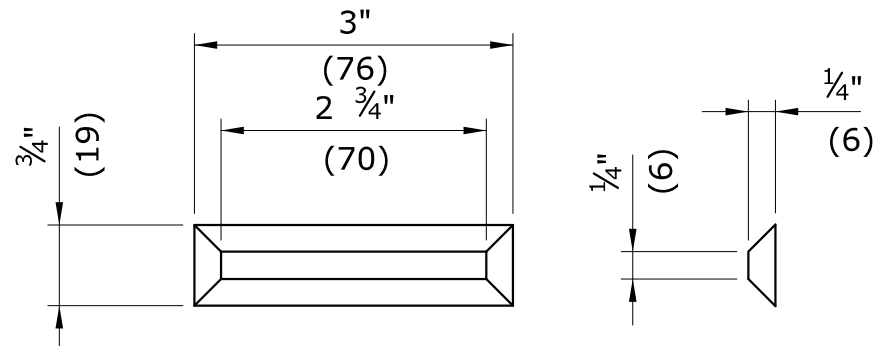

NON SKID LUG
DETAIL

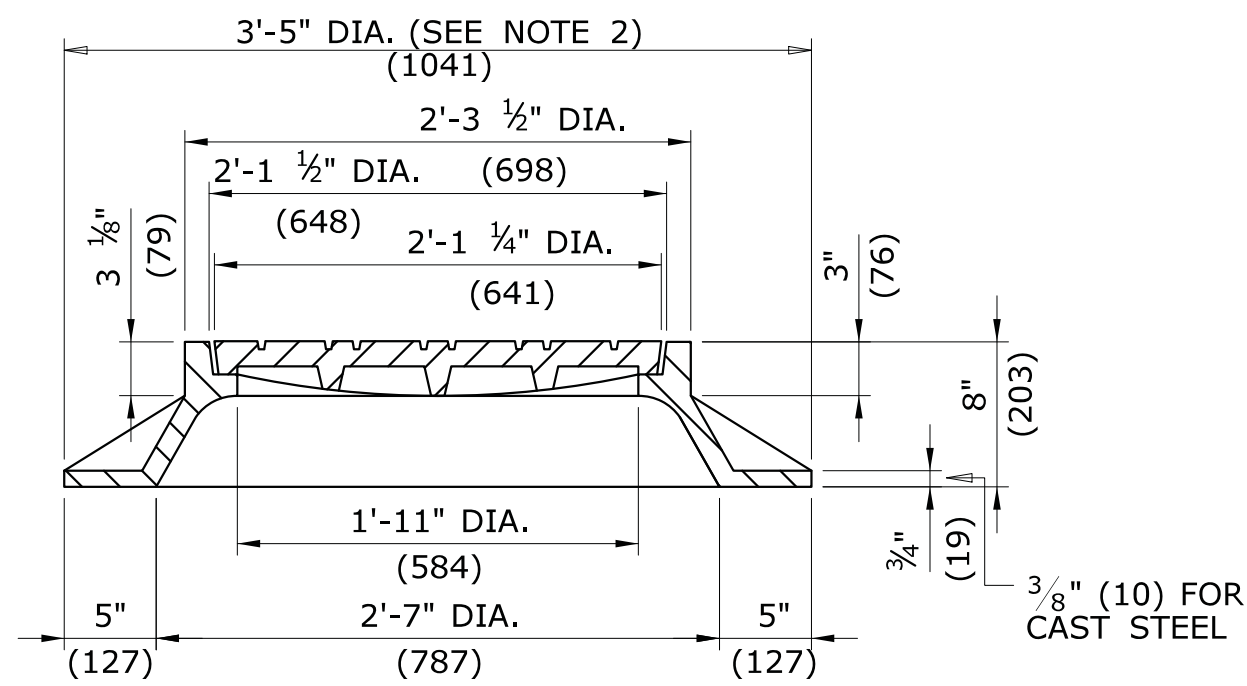

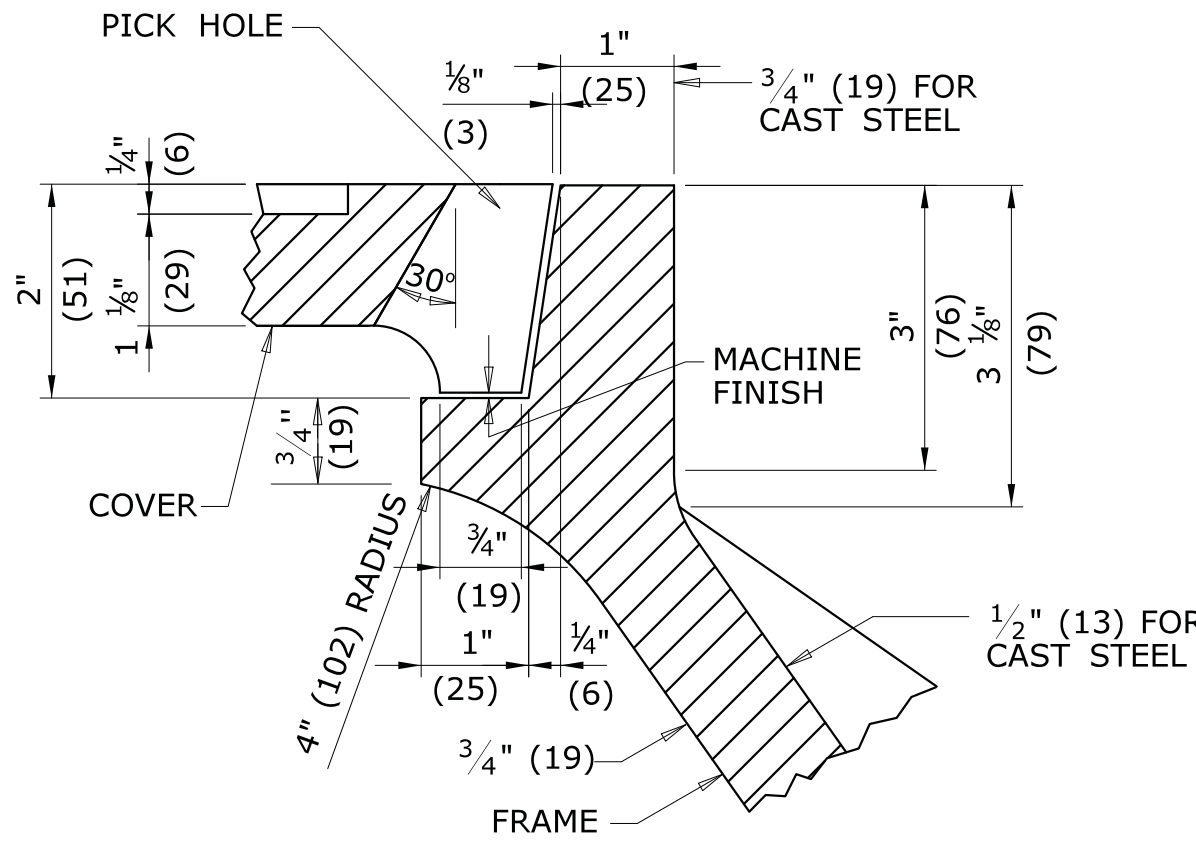

SECTION C




DETAIL OF SEAT


FRAME AND COVER DETAILS

ALL METRIC DIMENSIONS ARE IN MILLIMETERS (mm) UNLESS OTHERWISE NOTED


1	6/11	REVISE STEP WIDTH PER OSHA	THE INFORMATION, INCLUDING ESTIMATED QUANTITIES OF WORK, SHOWN ON THESE SHEETS IS BASED ON LIMITED INVESTIGATIONS BY THE STATE AND IS IN NO WAY WARRANTED TO INDICATE THE CONDITIONS OF ACTUAL QUANTITIES OF WORK WHICH WILL BE REQUIRED.	NOT TO SCALE	 STATE OF CONNECTICUT DEPARTMENT OF TRANSPORTATION 	SUBMITTED BY: _____ NAME/DATE/TIME: _____		CTDOT STANDARD SHEET	STANDARD SHEET TITLE: MANHOLE - FRAME & COVER	STANDARD SHEET NO.: HW-507_10
2	7/13	REVISE COVER FRAME WEIGHT				APPROVED BY: _____ NAME/DATE/TIME: _____				
-	-	-								
-	-	-								
-	-	-								
REV.	DATE	REVISION DESCRIPTION	Plotted Date: 6/13/2013		Filename: CTDOT.HIGHWAY.STD2013.dgn Model: 15-HW-507_10	OFFICE OF ENGINEERING				

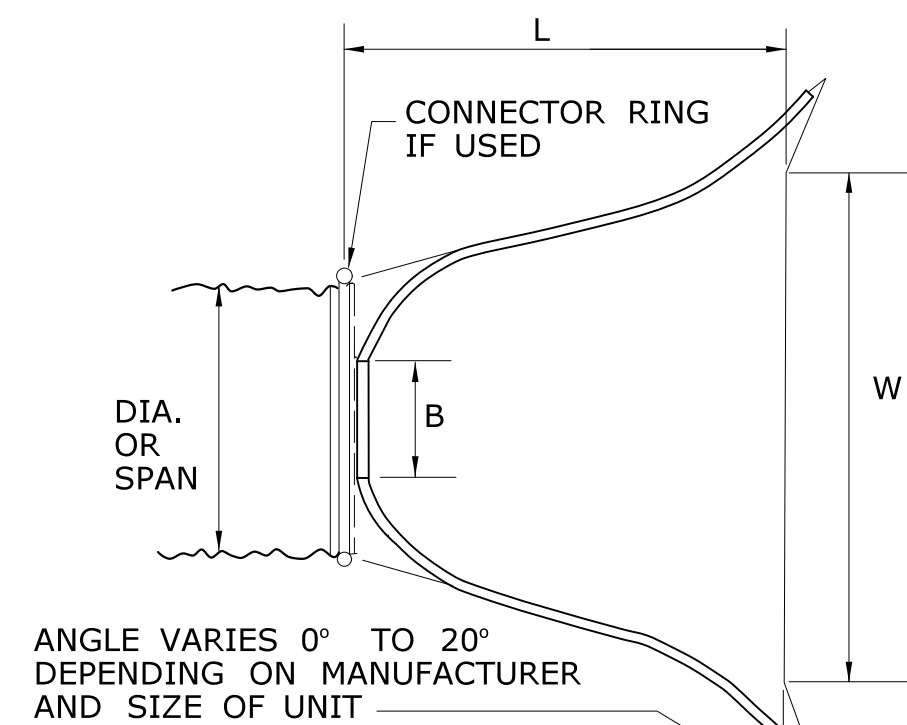

PLAN

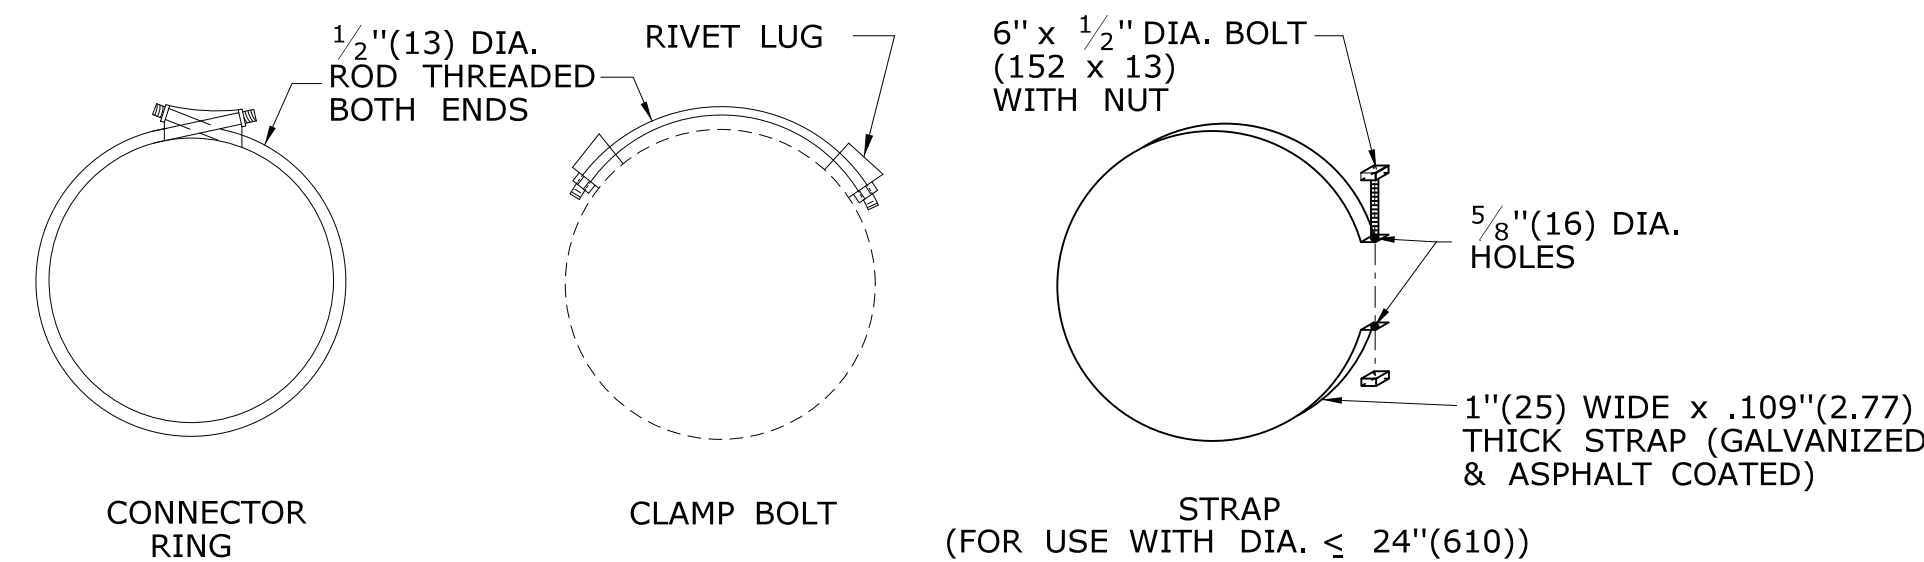


ATTACHMETNT SYSTEMS

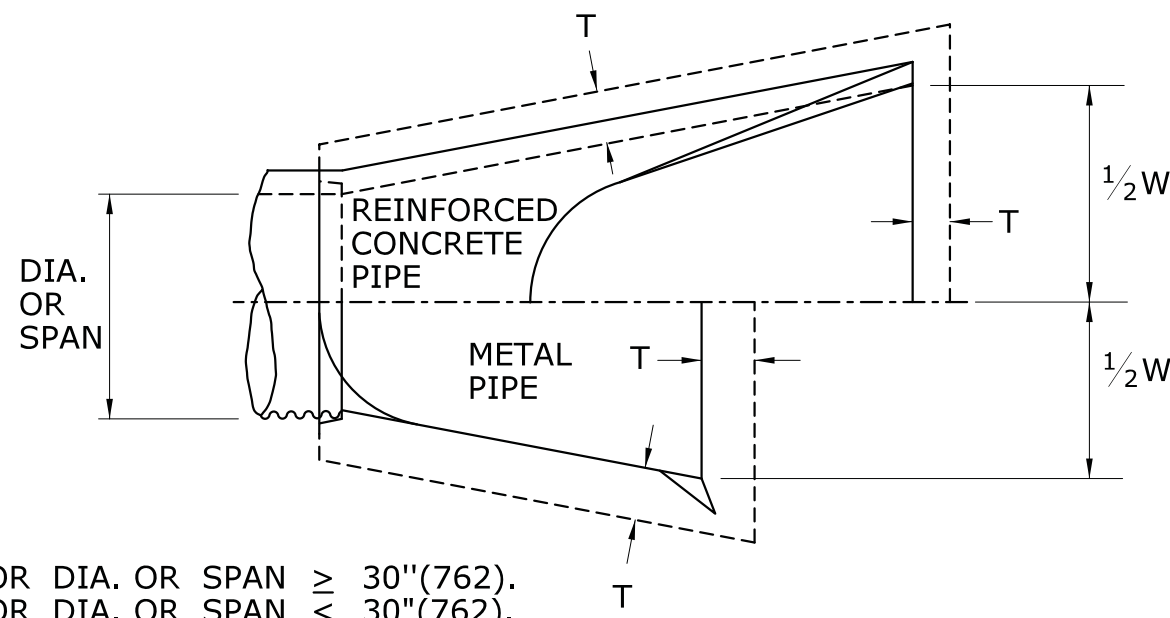


NOTE:
T = 18"(457) FOR DIA. OR SPAN \geq 30"(762).
T = 12"(305) FOR DIA. OR SPAN $<$ 30"(762).

HORIZONTAL PAY LIMITS FOR TRENCH EXCAVATION-PIPE ENDS

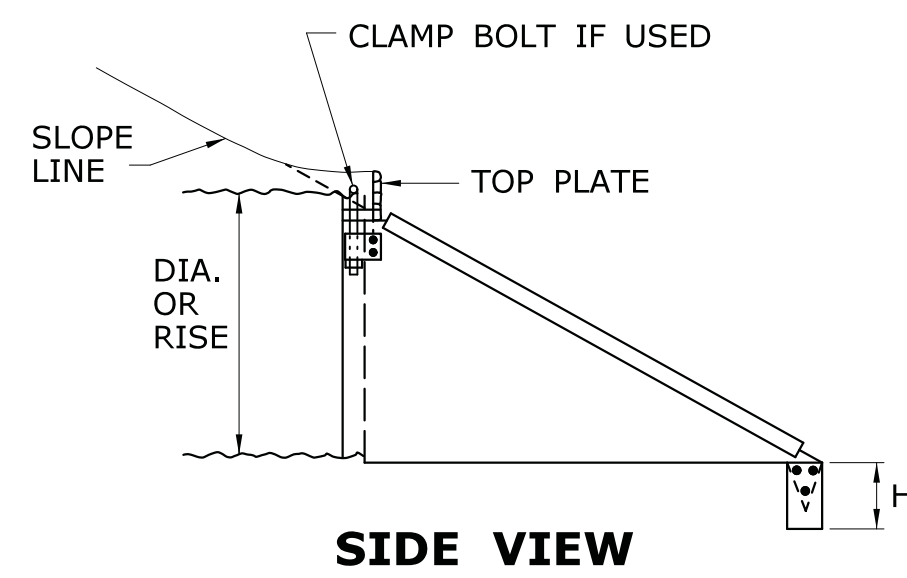


SIDE VIEW

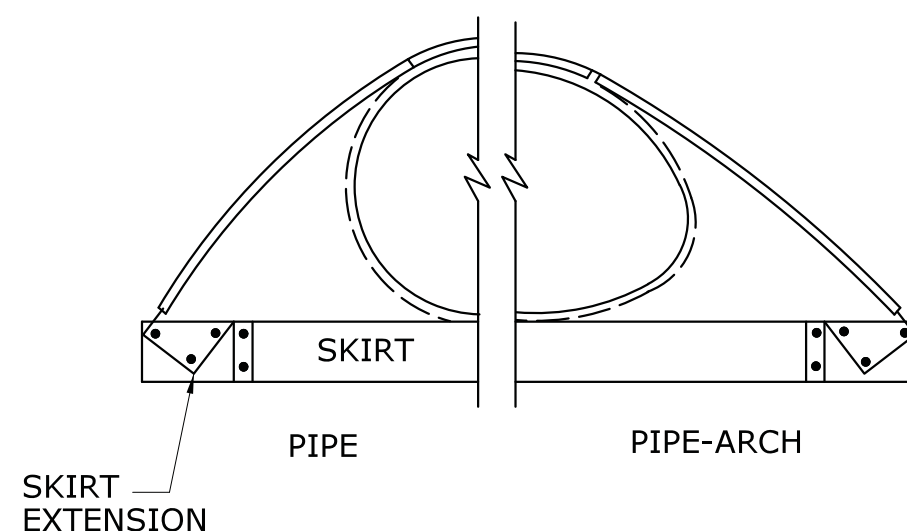


END VIEW

METAL PIPE END

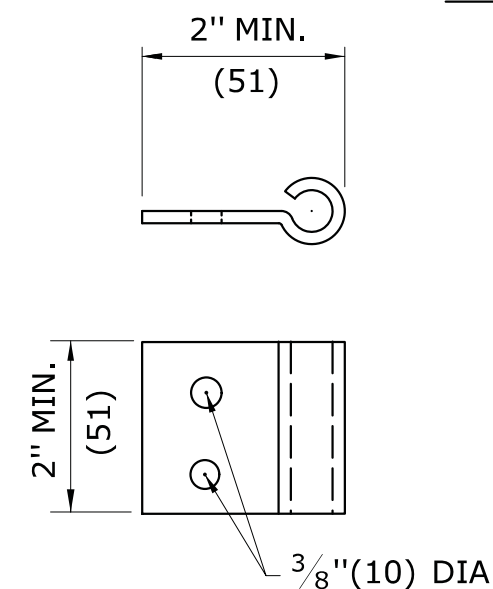

RIVET LUG

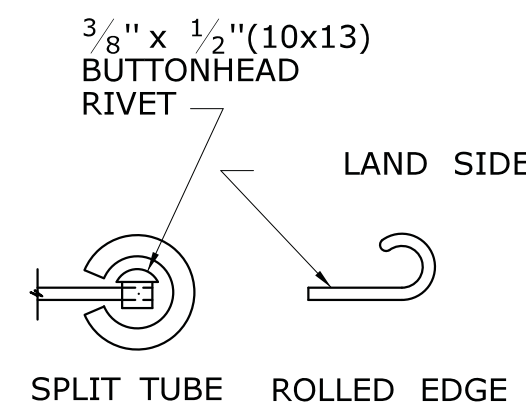



EDGE REINFORCEMENT

DIMENSIONS FOR REINFORCED CONCRETE PIPE END								FLARE REINFORCEMENT		
DIA.	A	B	C	D	E	F	R ₁	R ₂	MIN. AREA OF LONGITUDINAL STEEL SQ. IN. PER FT.	MIN. AREA OF TRANSVERSE STEEL SQ. IN. PER FT.
12"(305)	4"(102)	2'-0"(610)	4'-0 ³ / ₈ "(1241)	6'-0 ³ / ₈ "(1851)	2'-0"(610)	1'-7 ¹⁵ / ₁₆ "(506)	10 ¹ / ₄ "(260)	9"(229)	0.048	0.048
15"(381)	6"(152)	2'-3"(686)	3'-10"(1168)	6'-1"(1854)	2'-6"(762)	2'-0 ⁵ / ₁₆ "(618)	1'-0 ¹ / ₂ "(318)	11"(279)	0.054	0.054
18"(457)	9"(229)	2'-3"(686)	3'-10"(1168)	6'-1"(1854)	3'-0"(914)	2'-5"(737)	1'-3 ¹ / ₂ "(394)	1'-0"(305)	0.060	0.060
21"(533)	9"(229)	2'-11"(889)	3'-2"(965)	6'-1"(1854)	3'-6"(1067)	2'-7 ¹ / ₂ "(800)	1'-4"(406)	1'-1"(330)	0.066	0.066
24"(610)	9 ¹ / ₂ "(241)	3'-7 ¹ / ₂ "(1105)	2'-6"(762)	6'-1 ¹ / ₂ "(1867)	4'-0"(1219)	2'-9 ³ / ₁₆ "(843)	1'-4 ¹³ / ₁₆ "(427)	1'-2"(356)	0.072	0.072
30"(762)	1'-0"(305)	4'-6"(1371)	1'-7 ³ / ₄ "(502)	6'-1 ³ / ₄ "(1873)	5'-0"(1524)	3'-1"(940)	1'-6 ¹ / ₂ "(470)	1'-3"(381)	0.084	0.084
36"(914)	1'-3"(381)	5'-3"(1600)	2'-10 ³ / ₄ "(883)	8'-1 ³ / ₄ "(2483)	6'-0"(1829)	3'-11 ¹³ / ₁₆ "(1214)	2'-0 ⁵ / ₁₆ "(618)	1'-8"(508)	0.096	0.096
42"(1067)	1'-9"(534)	5'-3"(1600)	2'-11"(889)	8'-2"(2489)	6'-6"(1981)	4'-5 ⁷ / ₈ "(1368)	2'-3 ¹ / ₂ "(699)	1'-10"(559)	0.108	0.108
48"(1219)	2'-0"(610)	6'-0"(1829)	2'-2"(660)	8'-2"(2489)	7'-0"(2134)	4'-8 ¹ / ₂ "(1435)	2'-4 ¹ / ₂ "(724)	1'-10"(559)	0.120	0.120
54"(1372)	2'-3"(686)	5'-5"(1651)	2'-11"(889)	8'-4"(2540)	7'-6"(2286)	5'-5 ¹ / ₂ "(1664)	2'-9 ¹ / ₈ "(841)	2'-0"(610)	0.132	0.132
60"(1524)	2'-9"(838)	5'-0"(1524)	3'-3"(991)	8'-3"(2515)	8'-0"(2438)	6'-0 ¹ / ₂ "(1842)	3'-0 ¹¹ / ₁₆ "(932)	2'-0"(610)	0.144	0.144

PIPE DIA.	DIMENSIONS FOR METAL PIPE END				THICKNESS INS.(mm)
	B (MAX.)	H1" (+25)	L1+1 ¹ / ₂ " (+35)	W12" (+50)	
12"(305)	6"(152)	6"(152)	21"(533)	23"(610)	.064(1.63)
15"(381)	8"(203)	6"(152)	26"(660)	30"(762)	.064(1.63)
18"(457)	10"(254)	6"(152)	31"(787)	36"(914)	.064(1.63)
21"(533)	12"(305)	6"(152)	36"(914)	42"(1067)	.064(1.63)
24"(610)	13"(330)	6"(152)	41"(1041)	48"(1219)	.064(1.63)
30"(762)	16"(406)	8"(203)	51"(1295)	60"(1524)	.079(2.01)
36"(914)	19"(483)	9"(229)	60"(1524)	72"(1829)	.079(2.01)
42"(1067)	22"(559)	11"(279)	69"(1753)	84"(2134)	.109(2.77)
48"(1219)	27"(686)	12"(305)	78"(1981)	90"(2286)	.109(2.77)
54"(1372)	30"(762)	12"(305)	84"(2134)	102"(2591)	.109(2.77)
60"(1524)	33"(838)	12"(305)	87"(2210)	114"(2896)	.109(2.77)
66"(1676)	36"(914)	12"(305)	87"(2210)	120"(3048)	.109(2.77)
72"(1829)	39"(991)	12"(305)	87"(2210)	126"(3200)	.109(2.77)
78"(1981)	42"(1067)	12"(305)	87"(2210)	132"(3353)	.109(2.77)
84"(2134)	45"(1143)	12"(305)	87"(2210)	138"(3450)	.109(2.77)


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ALL METRIC DIMENSIONS ARE IN MILLIMETERS (mm) UNLESS OTHERWISE NOTED.




1	7/13	CHANGE ALL CULVERT LABELS TO SAY PIPE	THE INFORMATION, INCLUDING ESTIMATED QUANTITIES OF WORK, SHOWN ON THESE SHEETS IS BASED ON LIMITED INVESTIGATIONS BY THE STATE AND IS IN NO WAY WARRANTED TO INDICATE THE CONDITIONS OF ACTUAL QUANTITIES OF WORK WHICH WILL BE REQUIRED.	NOT TO SCALE	 STATE OF CONNECTICUT DEPARTMENT OF TRANSPORTATION 	SUBMITTED BY: _____ NAME/DATE/TIME: _____ APPROVED BY: _____ NAME/DATE/TIME: _____ _____	CTDOT STANDARD SHEET OFFICE OF ENGINEERING	STANDARD SHEET TITLE: PIPE ENDS	STANDARD SHEET NO.: HW-652_01
REV.	DATE	REVISION DESCRIPTION	Plotted Date: 3/28/2013		Filename: CTDOT_HIGHWAY STD2013.dgn Model: 19-HW-652_01				



1. ALL CONSTRUCTION DIMENSIONS ARE NOMINAL.

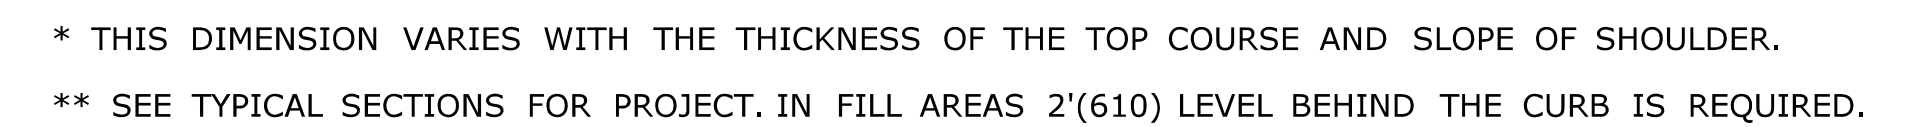

1/2"(13) MORTAR JOINT REQUIRED

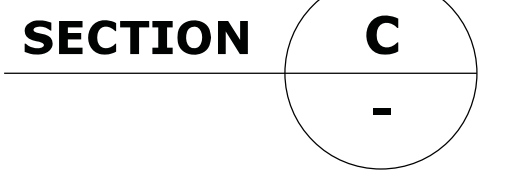
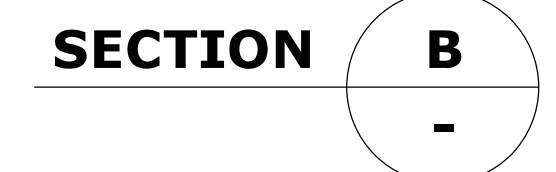
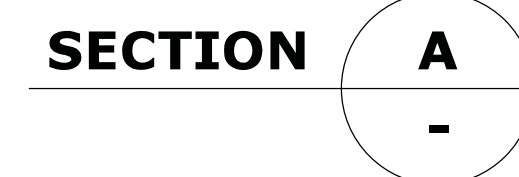


6" (150) CONCRETE CURBING




ALL METRIC DIMENSIONS ARE IN MILLIMETERS (mm) UNLESS OTHERWISE NOTED

<div style="text-align: center;"> CTDOT STANDARD SHEET </div>
<div style="text-align: center;"> OFFICE OF ENGINEERING </div>

HW-811_01

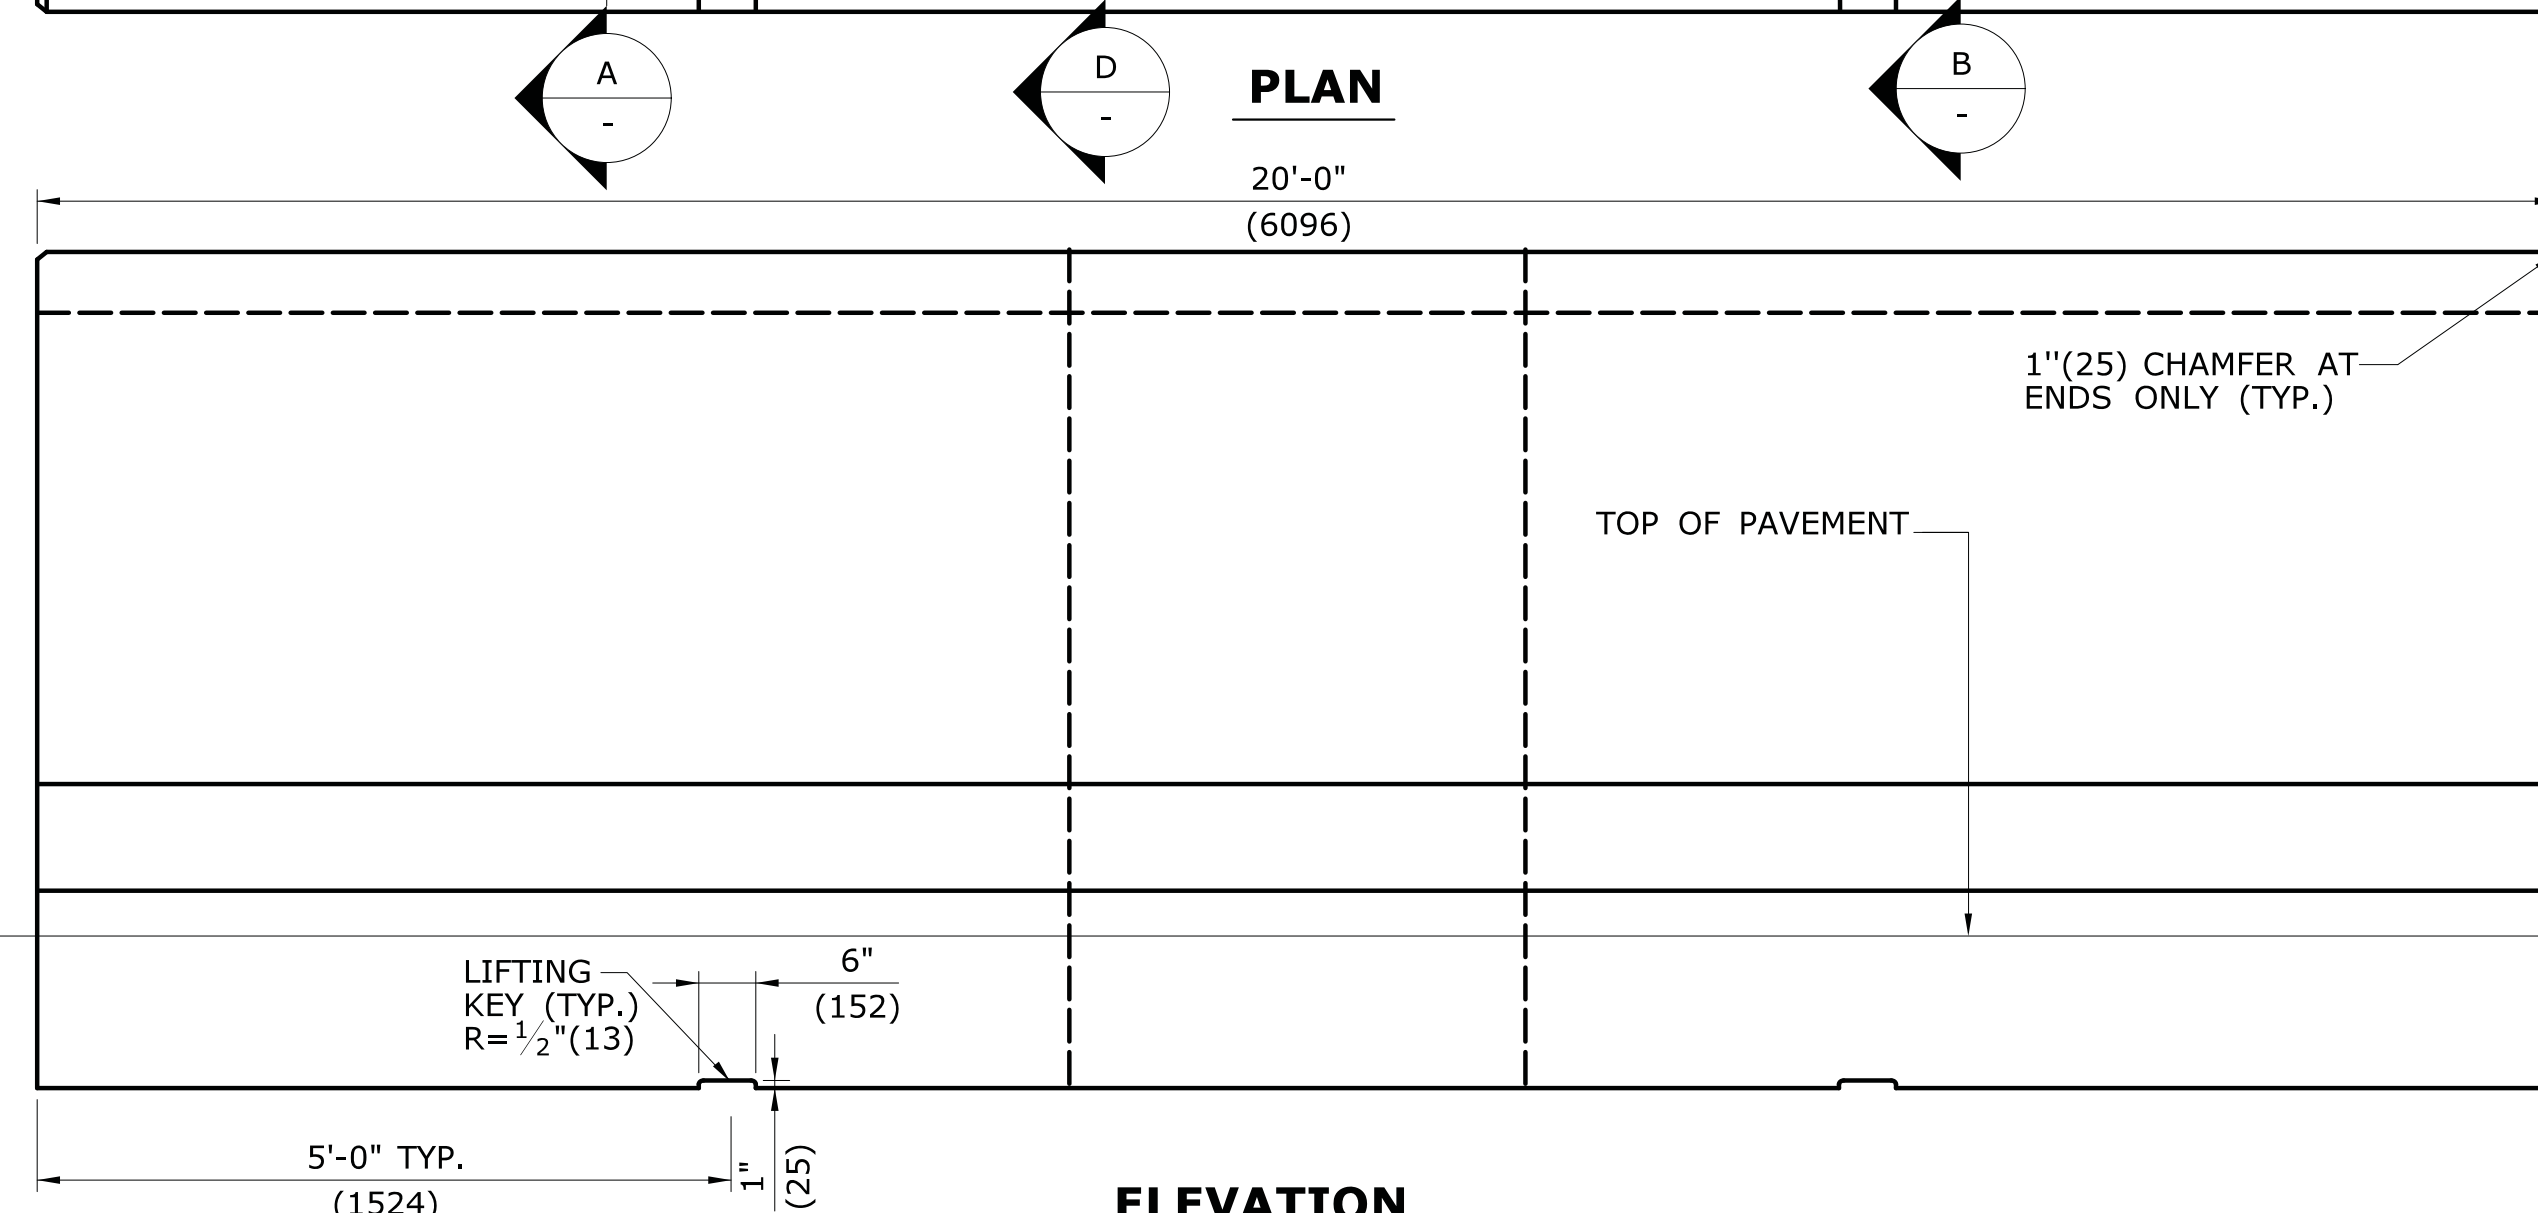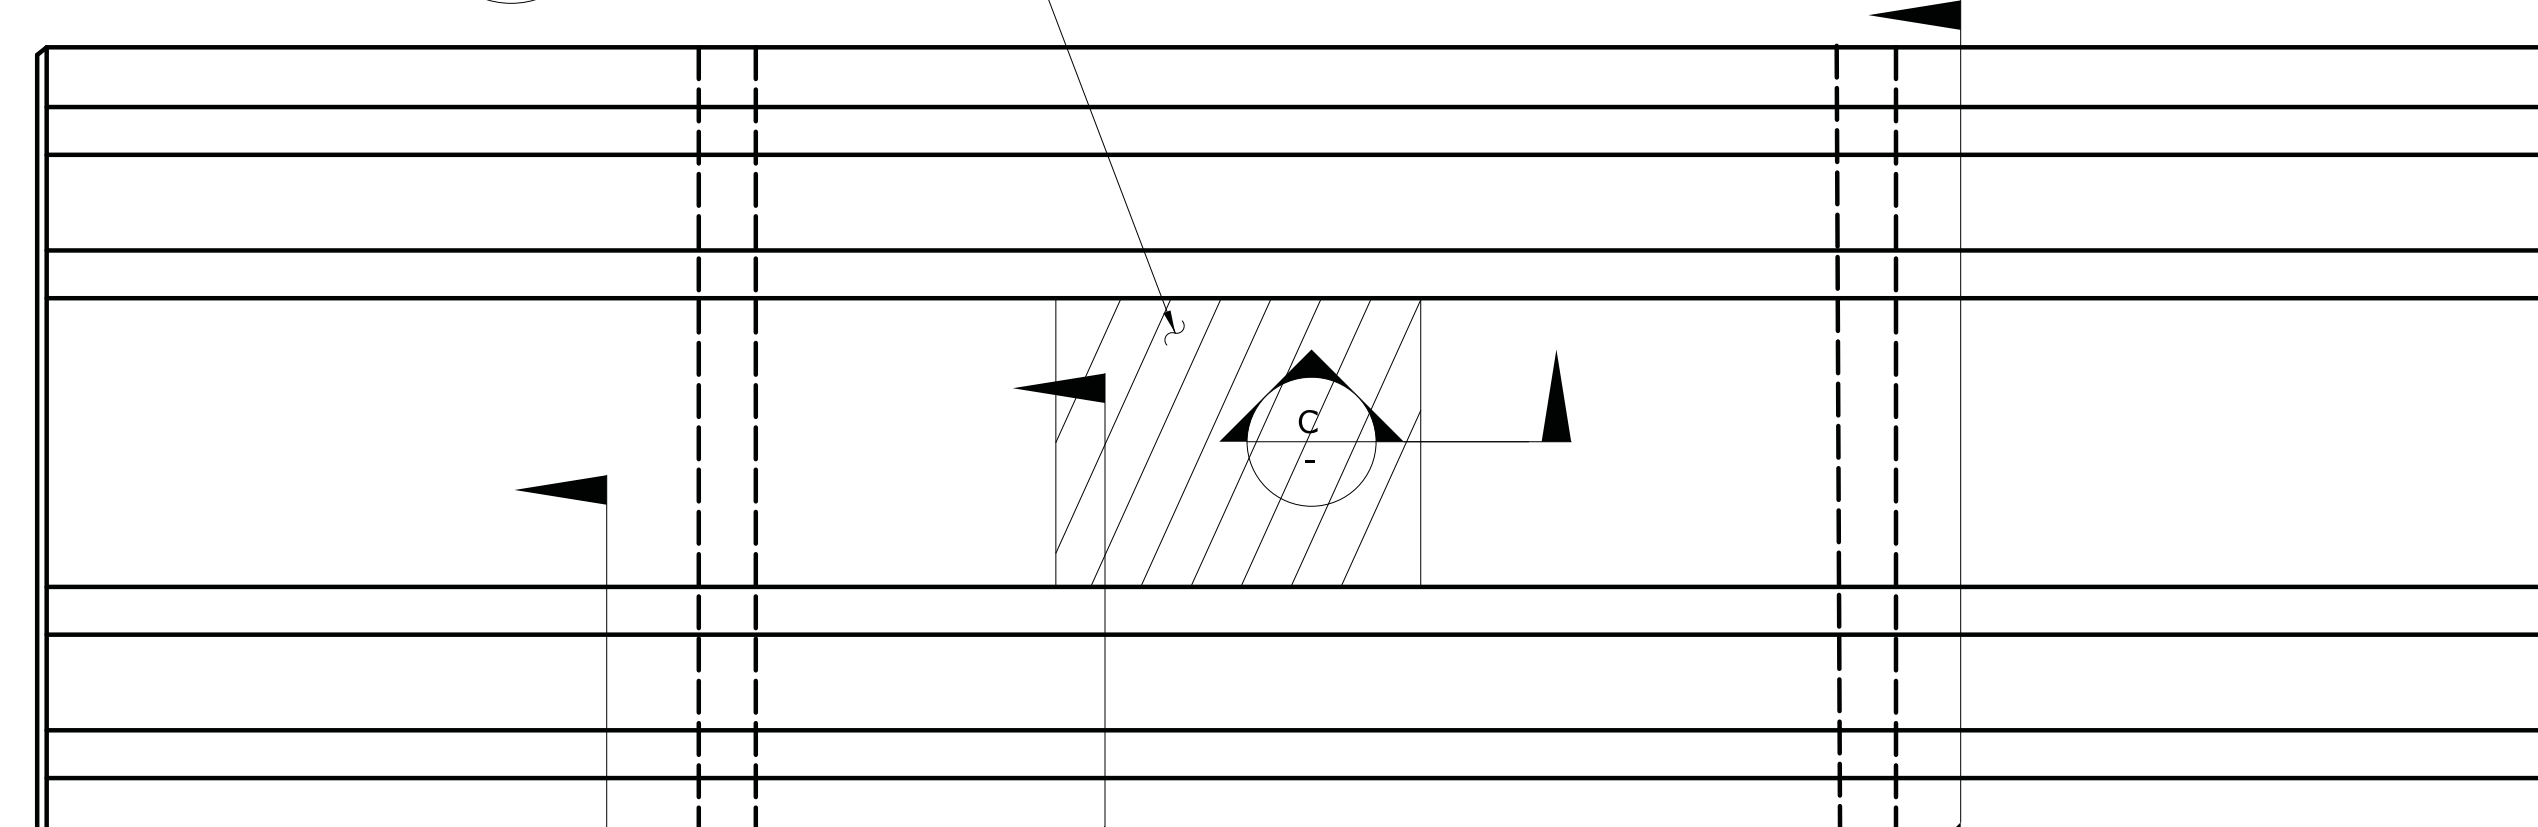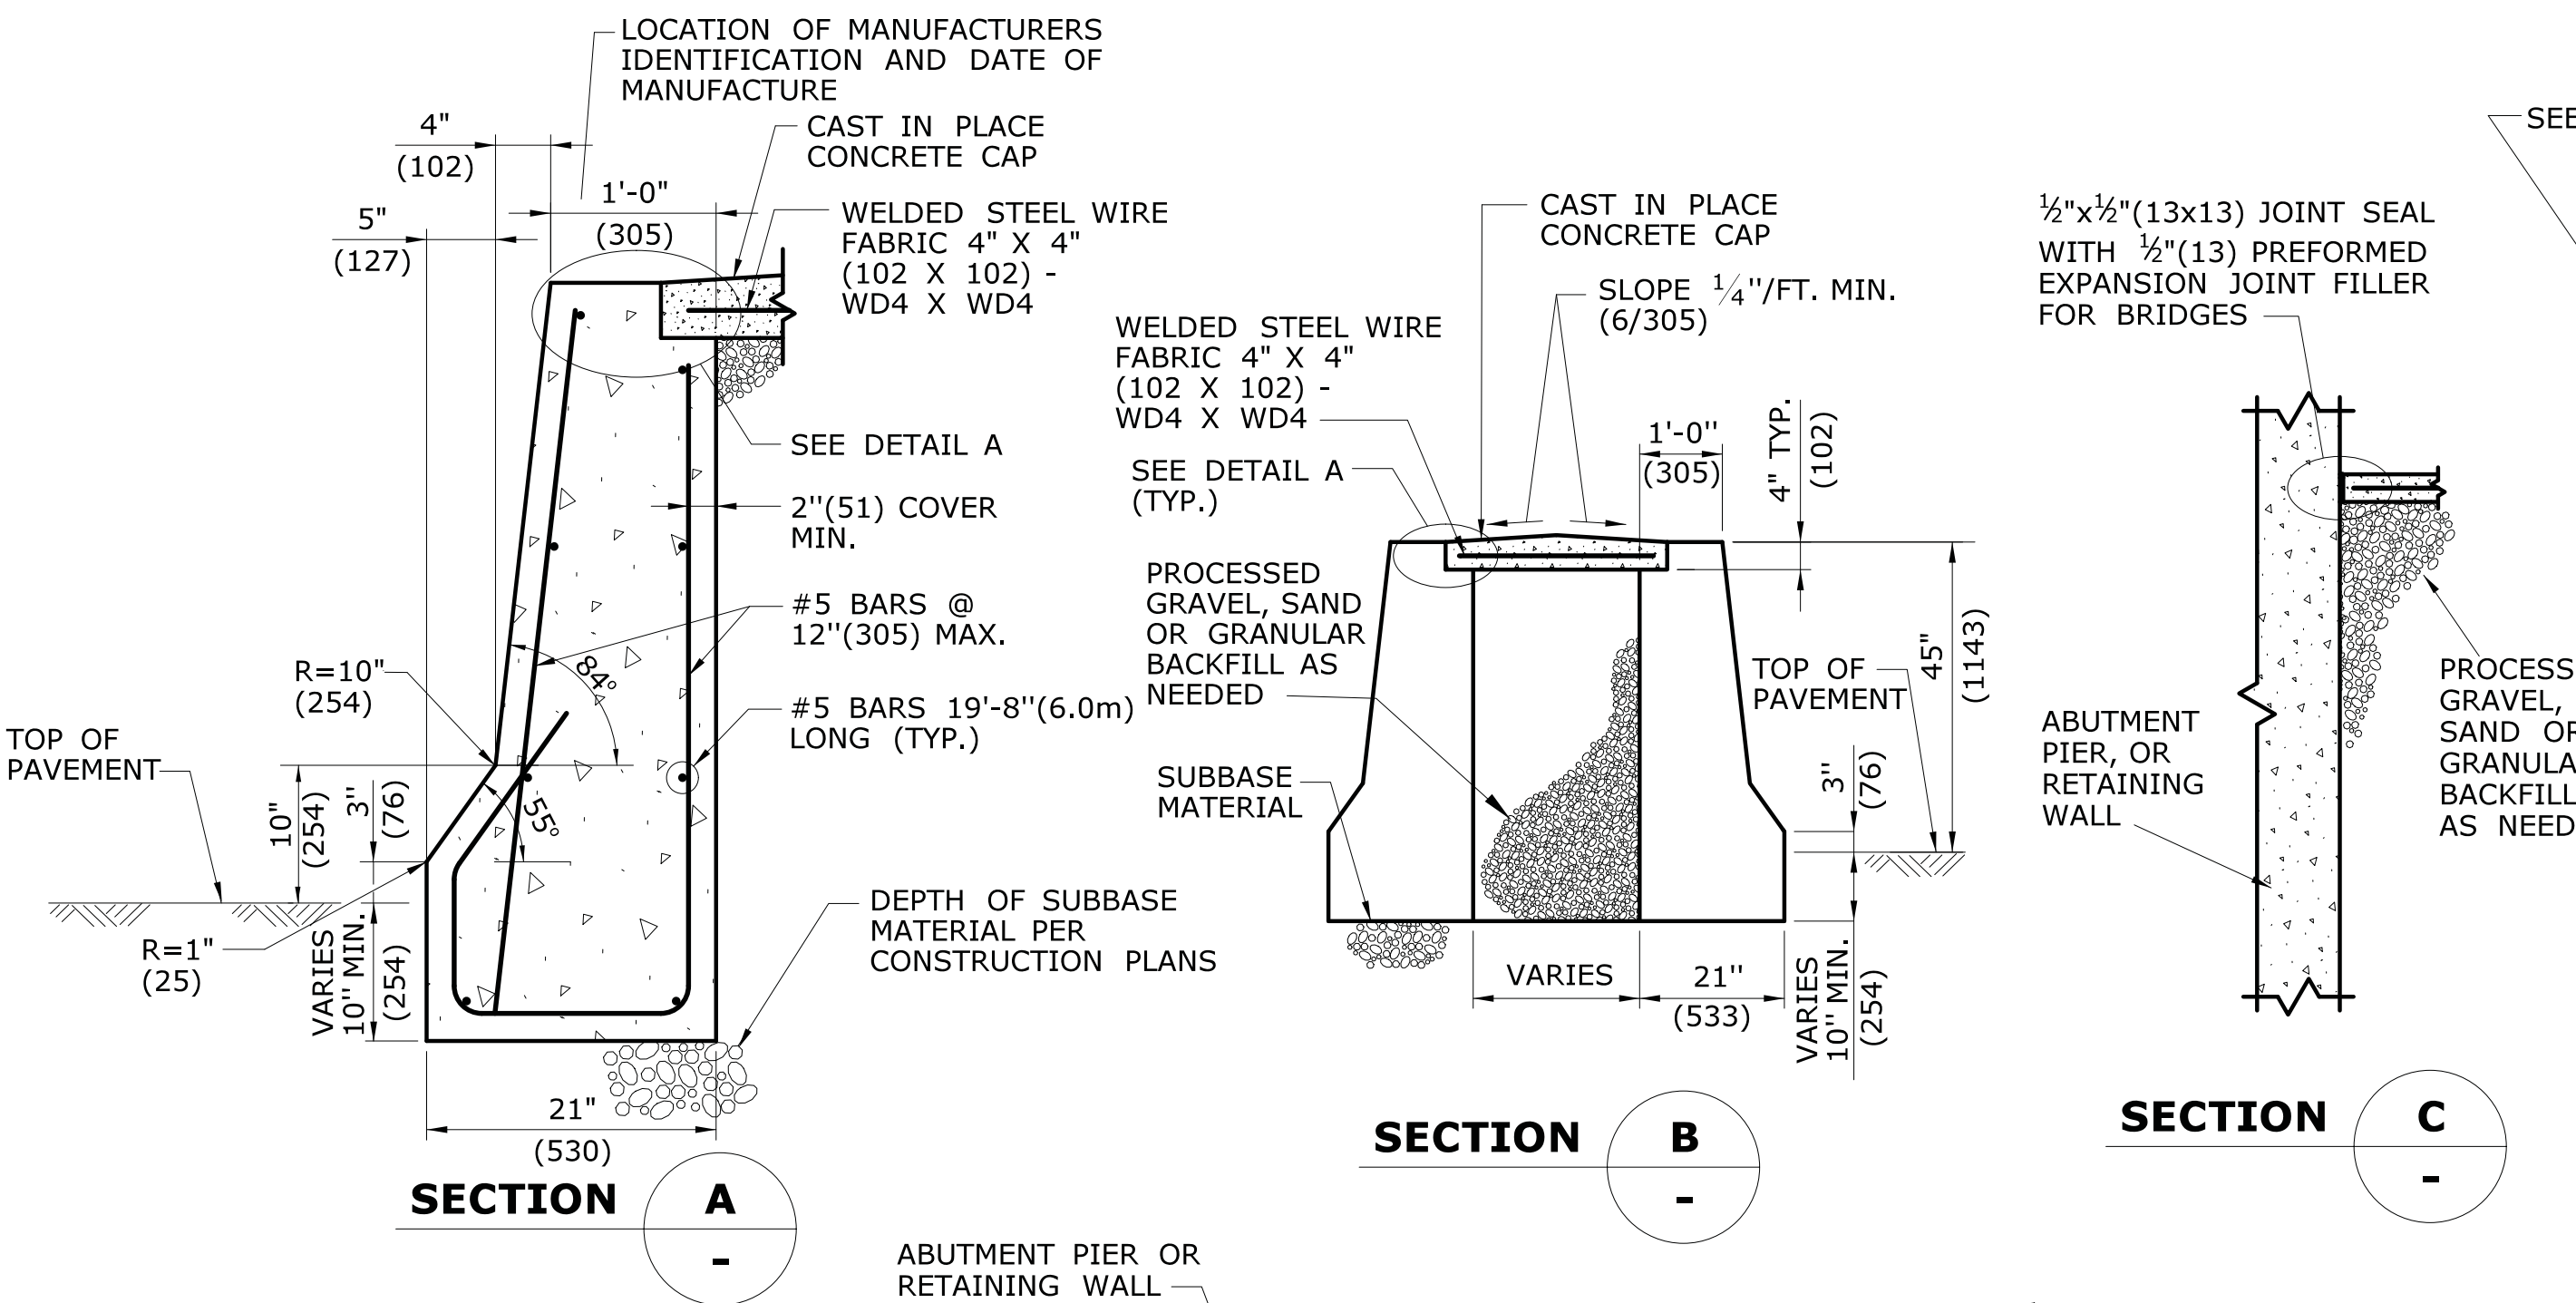


**21" x 45"(530x1145) PRECAST CONCRETE BARRIER CURB UNIT
AT PIER ABUTMENT OR RETAINING WALL**

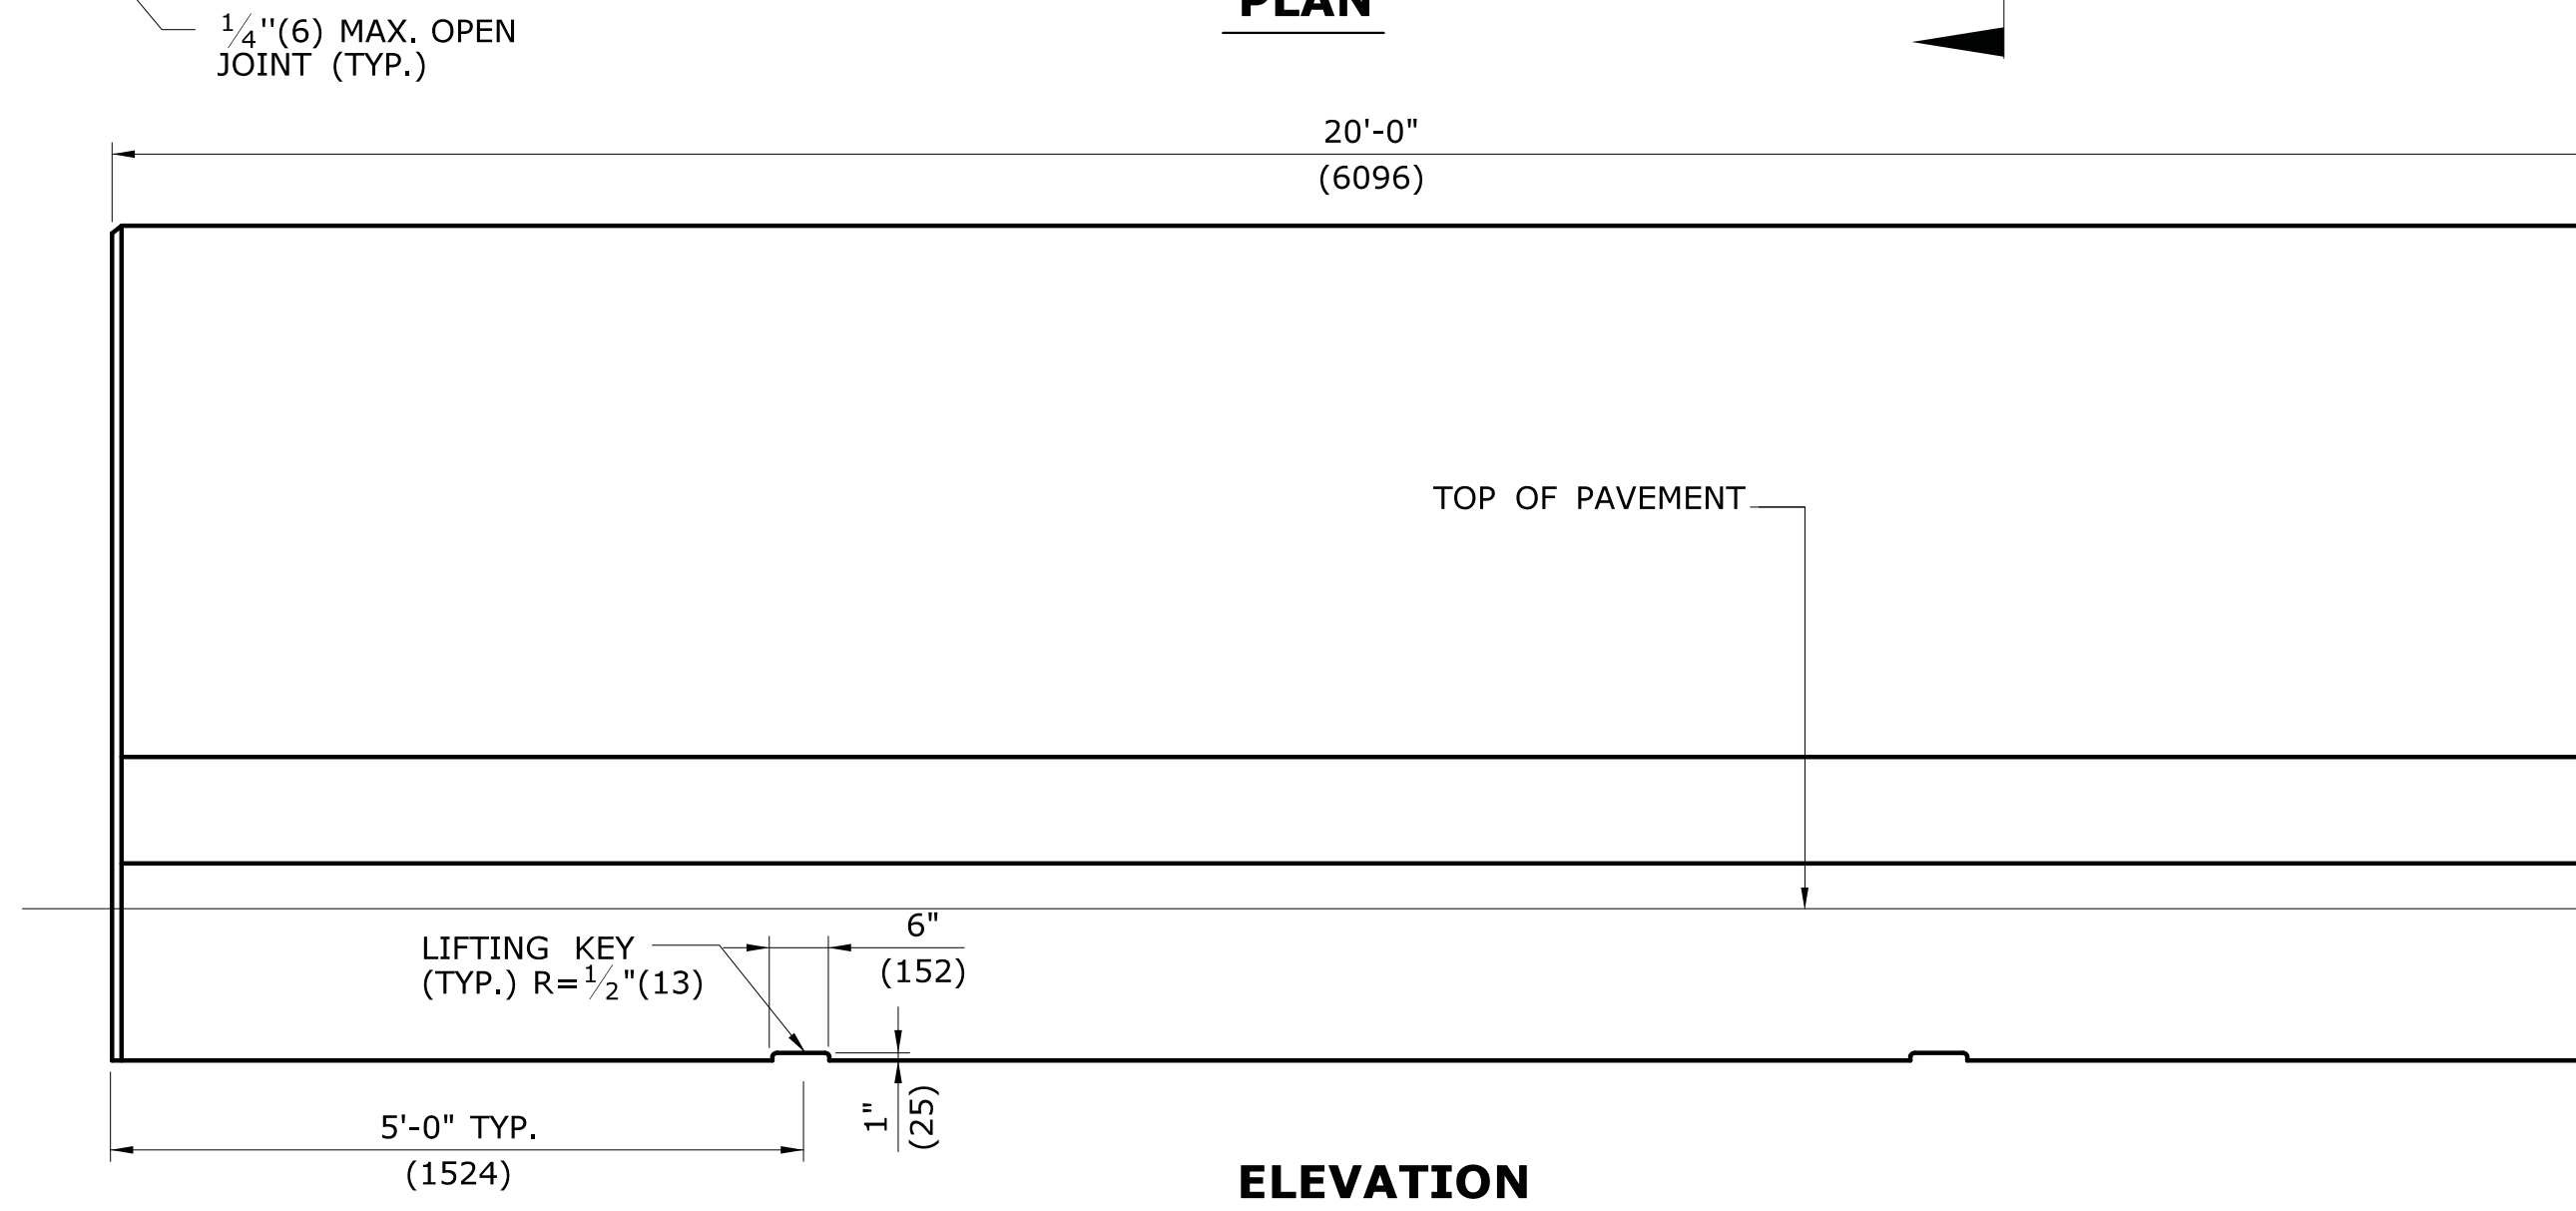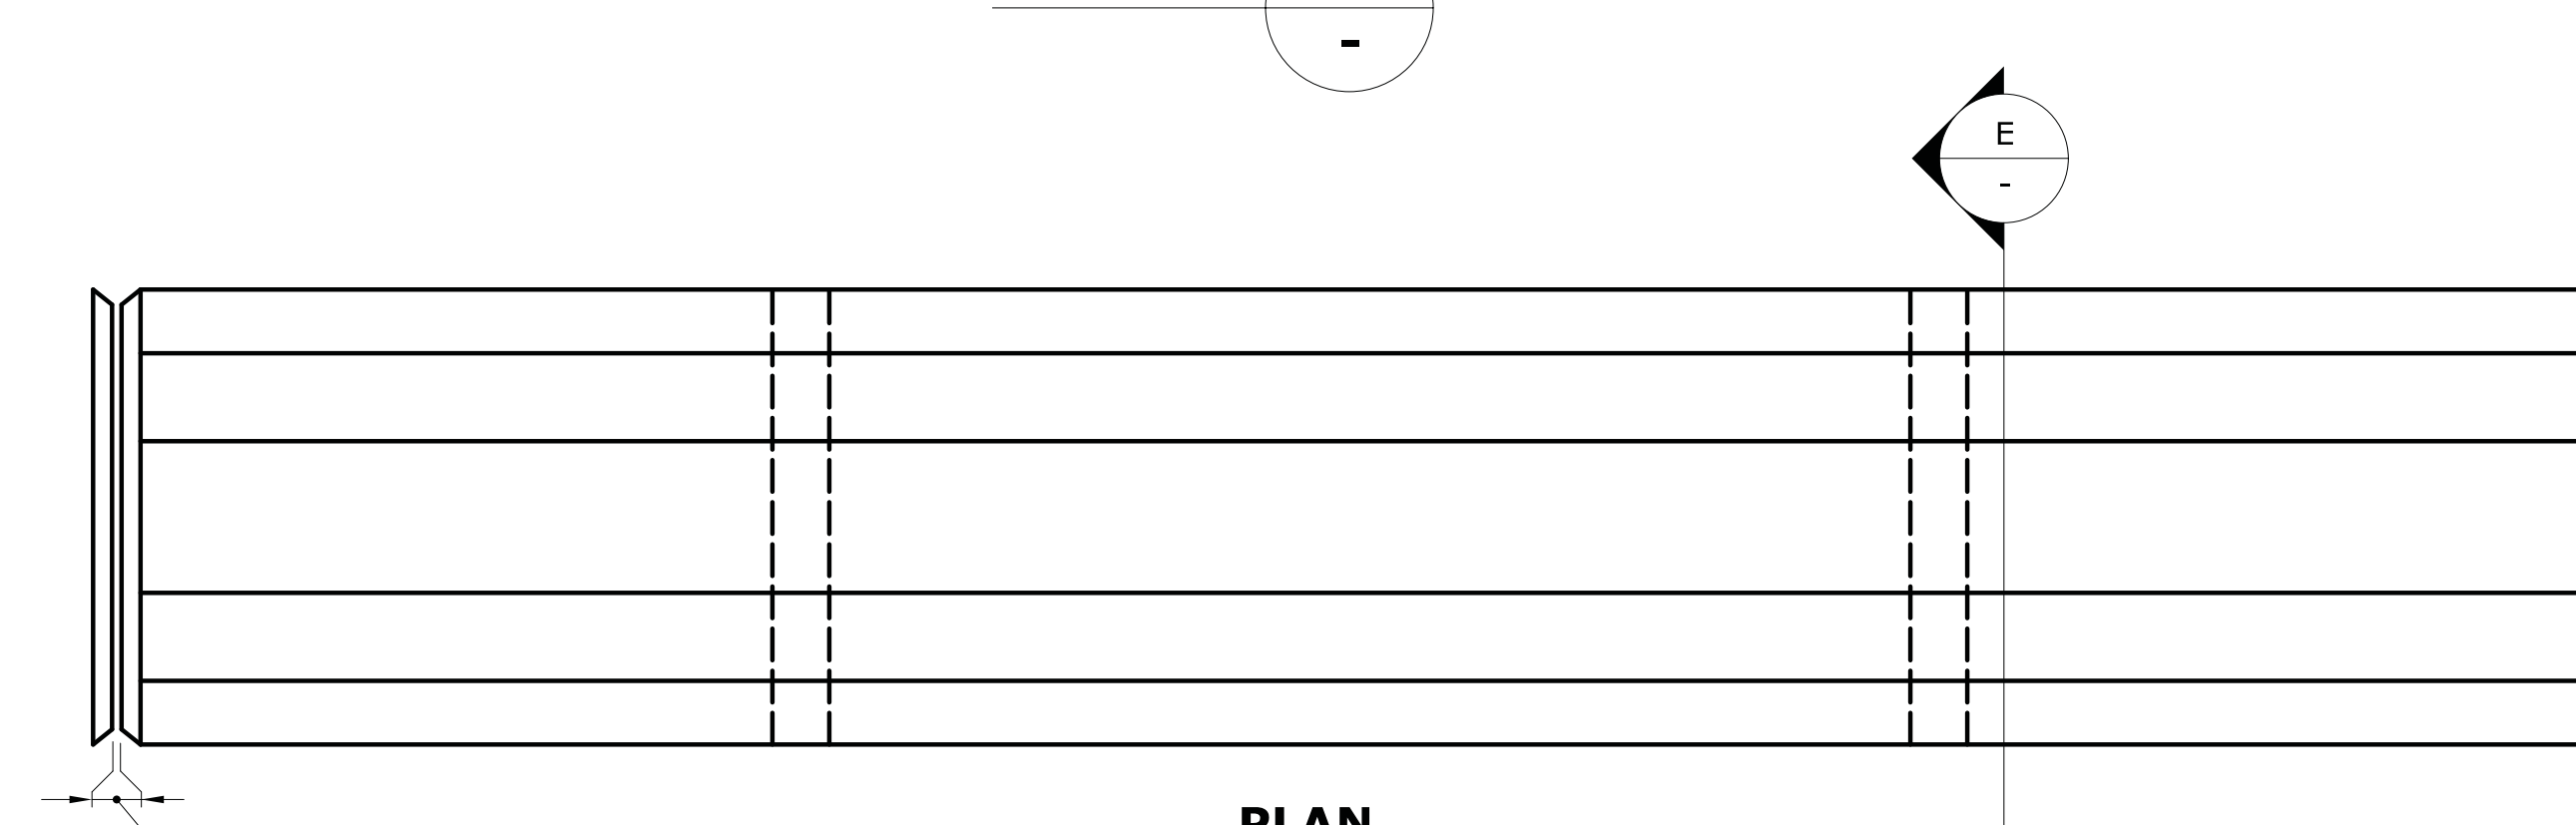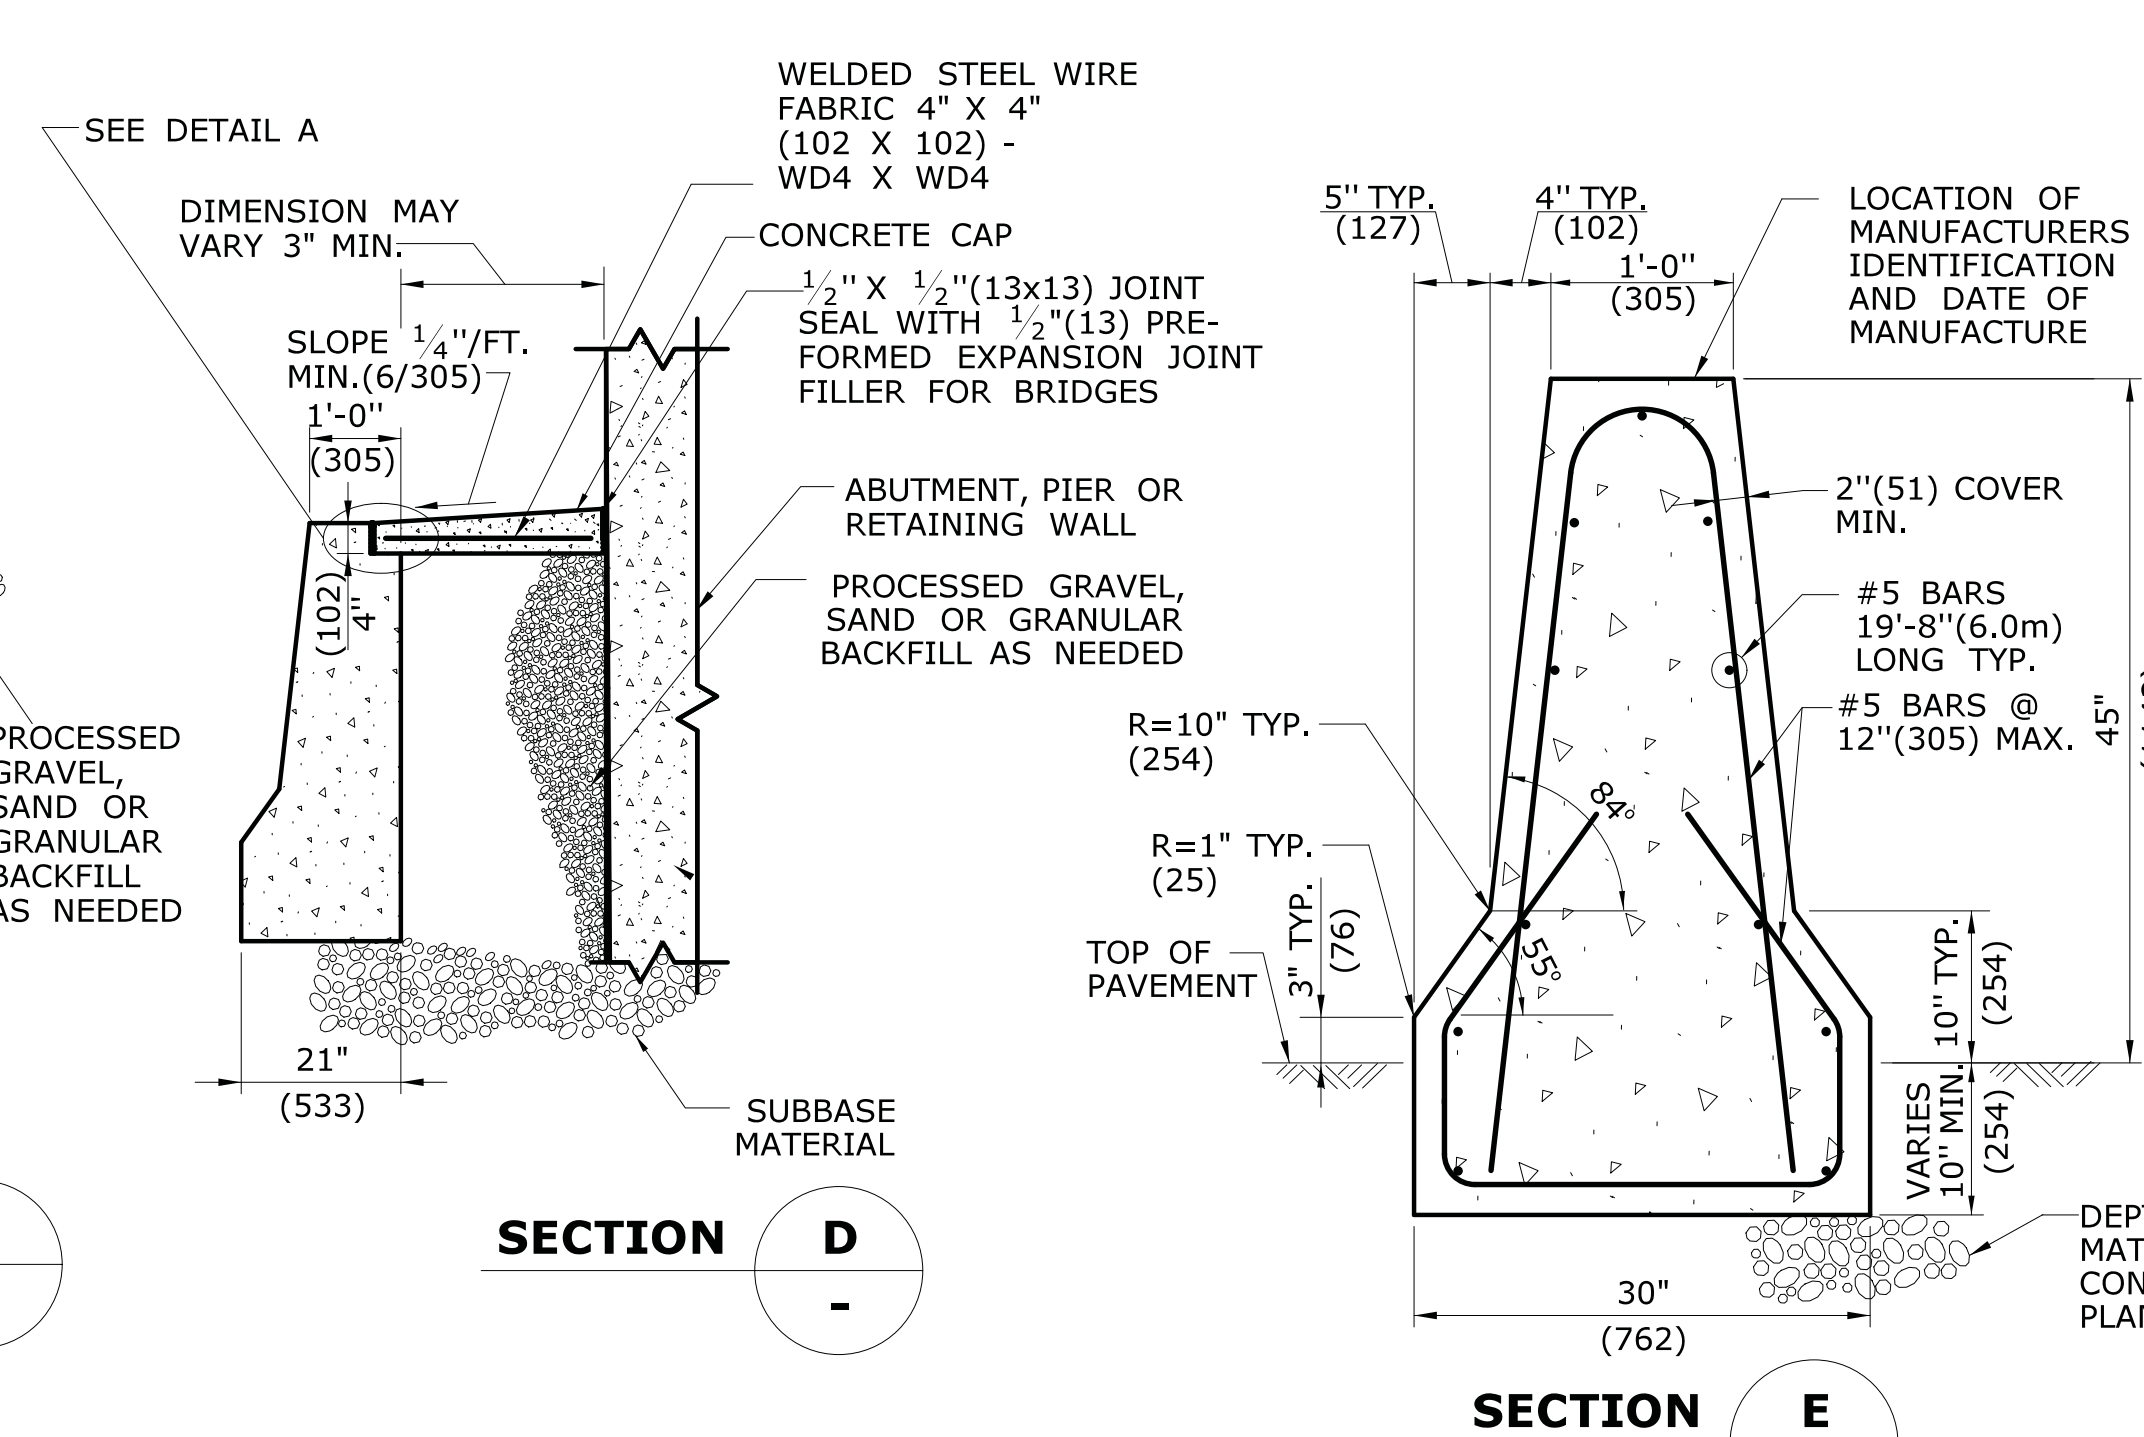


30" x 45"(755 x1145) PRECAST CONCRETE BARRIER CURB UNIT

GENERAL NOTES:


1. ALTERNATE DESIGNS FOR THE FOLLOWING ITEMS MAY BE SUBSTITUTED TO THE ENGINEER FOR APPROVAL :
A) UNIT END CONNECTIONS SIMILAR TO DESIGNS SHOWN.
B) LIFTING KEYS OR OTHER HANDLING DEVICES.

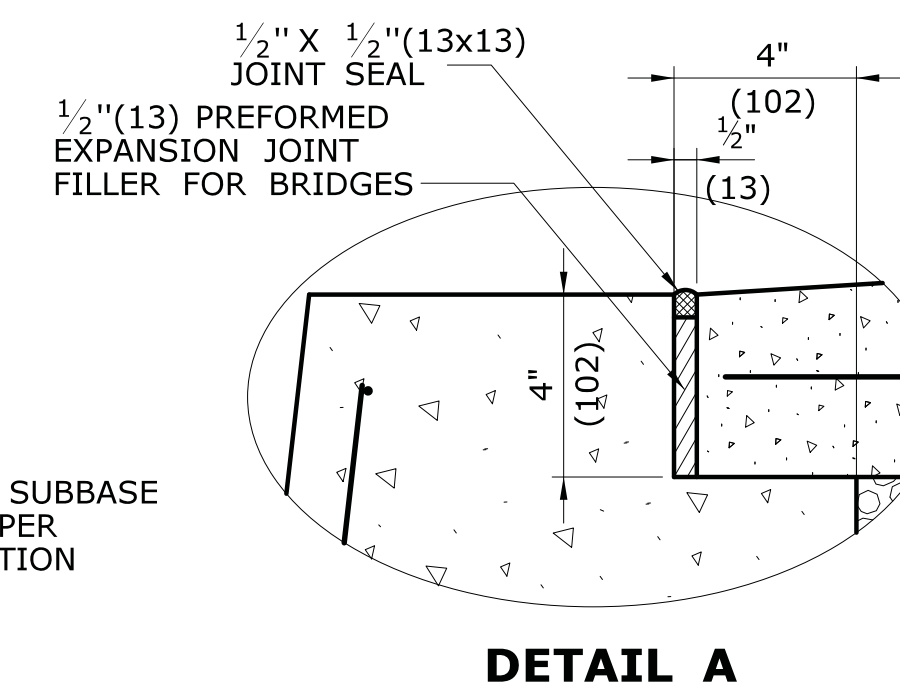


1	5/13/10	REVISE GENERAL NOTE 2 AND ADD NOTE 3	<p>THE INFORMATION, INCLUDING ESTIMATED QUANTITIES OF WORK, SHOWN ON THESE SHEETS IS BASED ON LIMITED INVESTIGATIONS BY THE STATE AND IS IN NO WAY WARRANTED TO INDICATE THE CONDITIONS OF ACTUAL QUANTITIES OF WORK WHICH WILL BE REQUIRED.</p>	<p>NOT TO SCALE</p>	<p>STATE OF CONNECTICUT DEPARTMENT OF TRANSPORTATION</p>	<p>SUBMITTED BY: NAME/DATE/TIME:</p>	<p>CTDOT STANDARD SHEET</p>	<p>STANDARD SHEET TITLE: 45" (1145) F- SHAPE PRECAST CONCRETE BARRIER CURB</p>	<p>STANDARD SHEET NO.: HW-821_02a</p>
2	1/12	REVISE GENERAL NOTES							
3	1/12	ENLARGE PLANS & ELEVATIONS, ADD SHEET 2b FOR GUIDERAIL							
4	7/13	ERRATA - SPELLING							
REV.	DATE	REVISION DESCRIPTION	Plotted Date: 3/21/2013	Filename: June2013.dgn	Model: HW-821_02a	APPROVED BY: NAME/DATE/TIME:	OFFICE OF ENGINEERING		

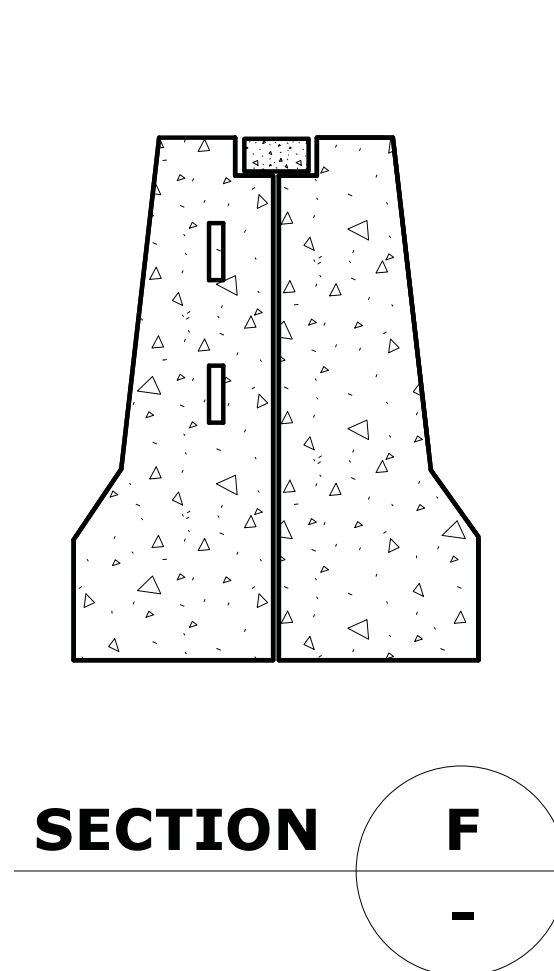


SECTION F

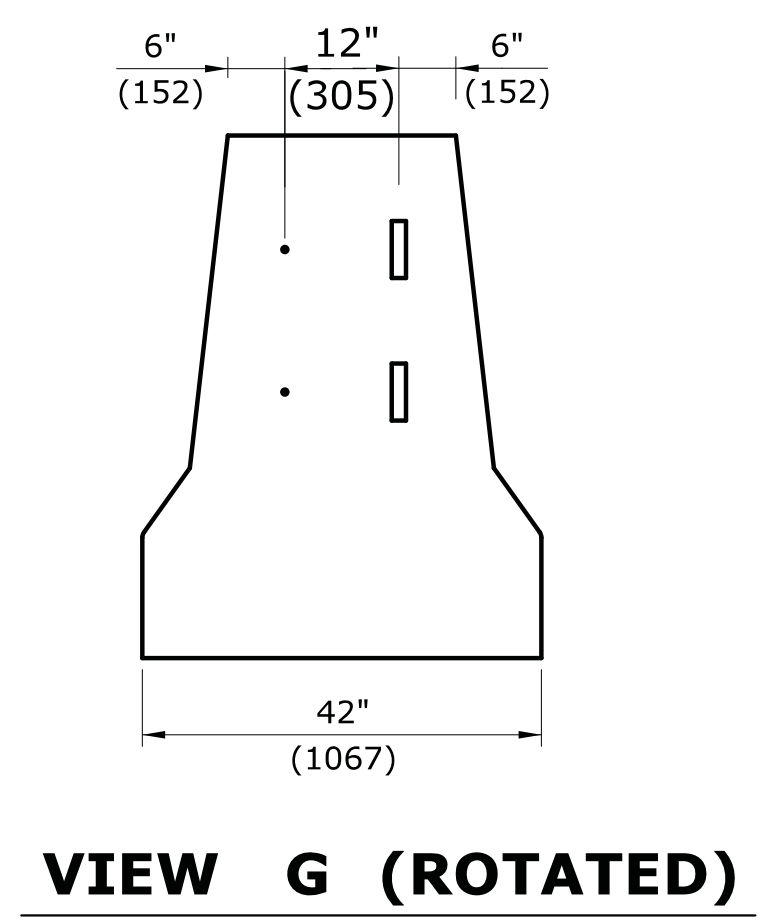


VIEW G (ROTATED)

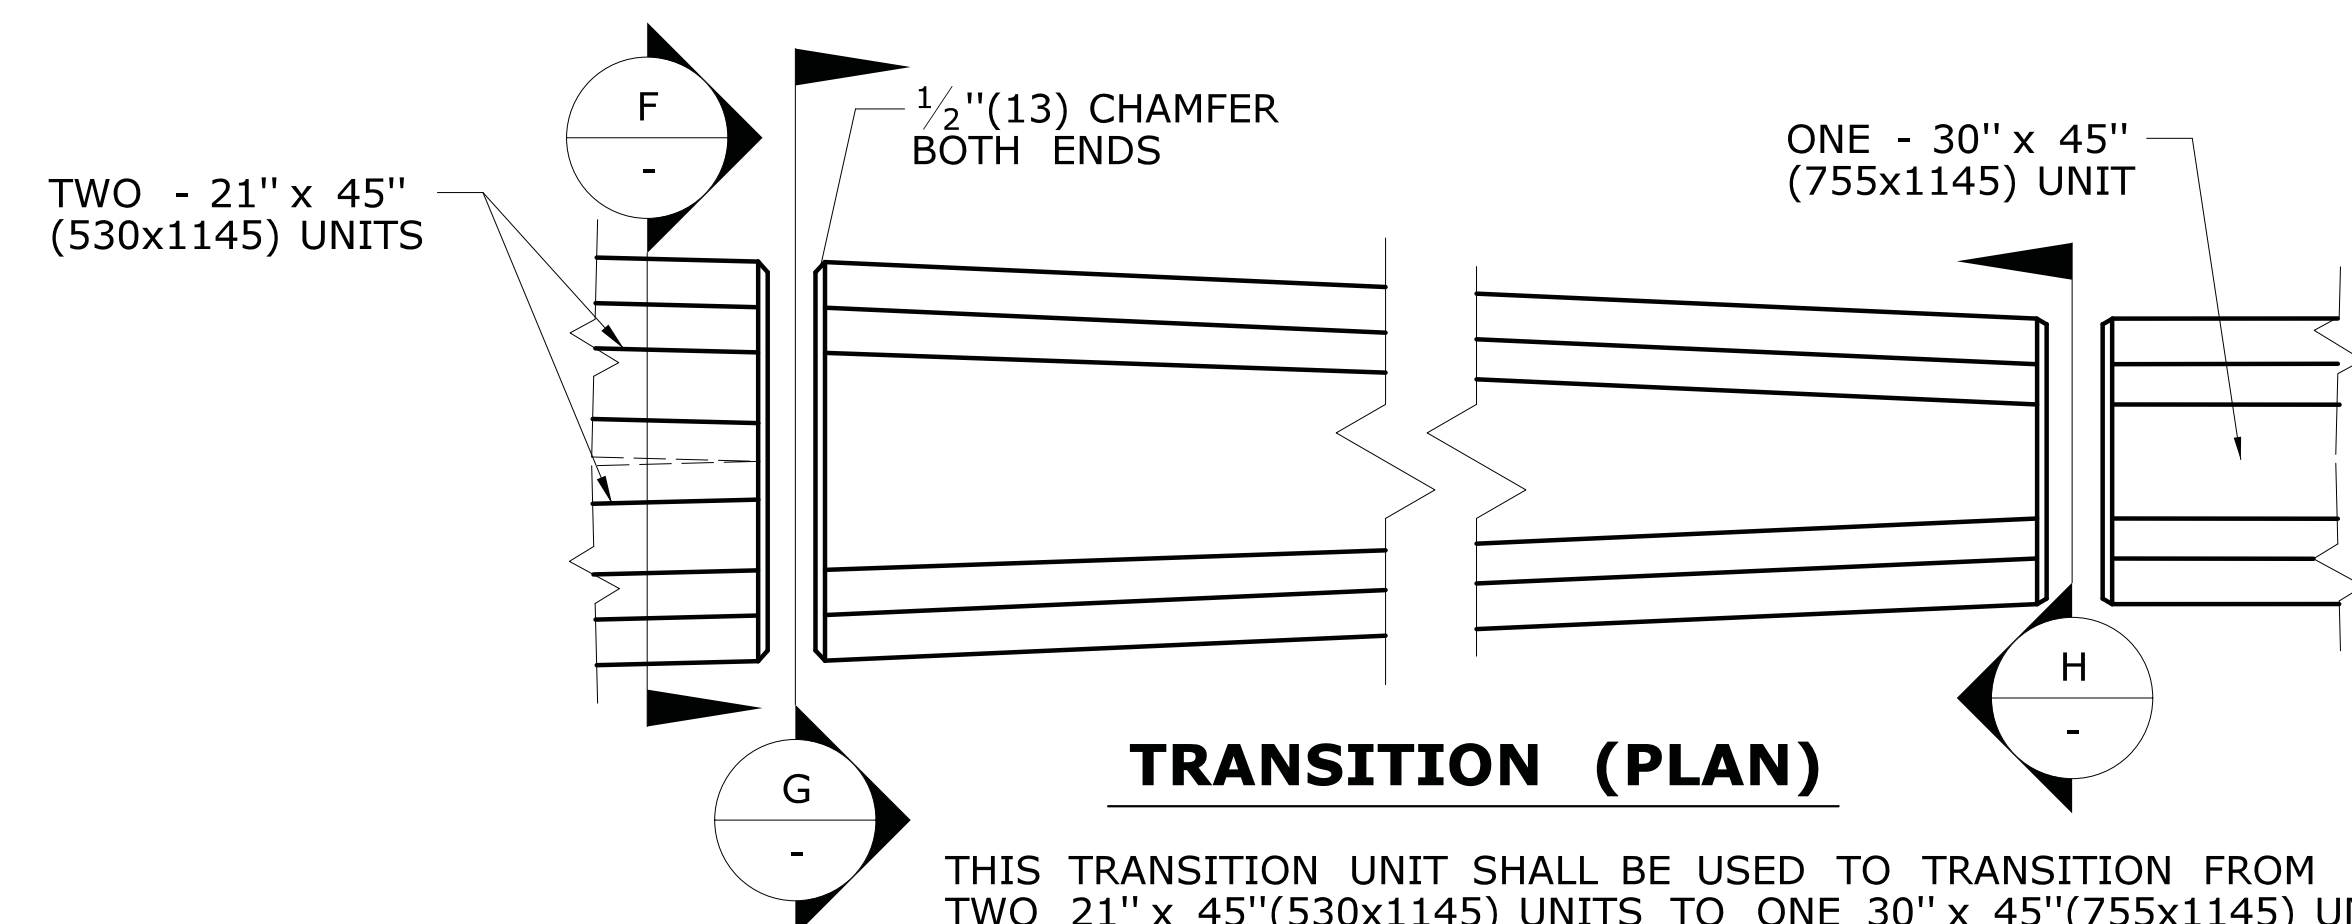


TRANSITION (PLAN)

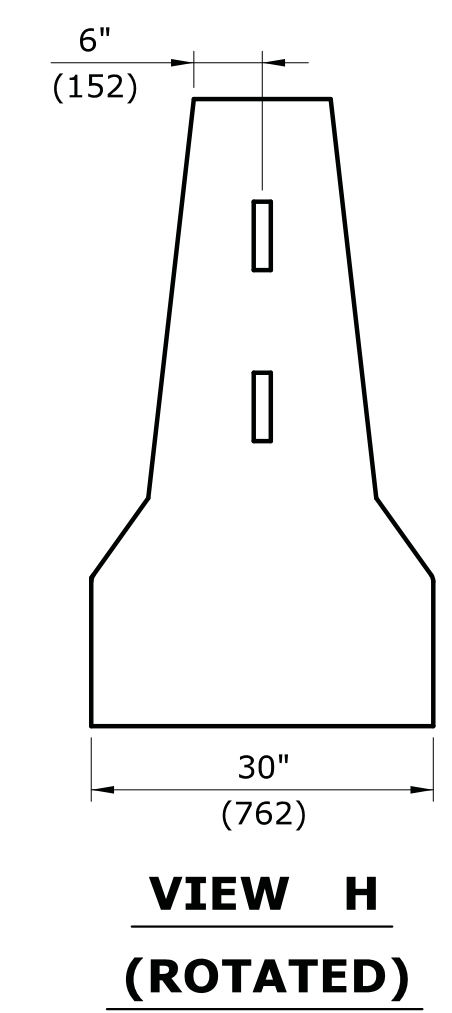


VIEW H (ROTATED)

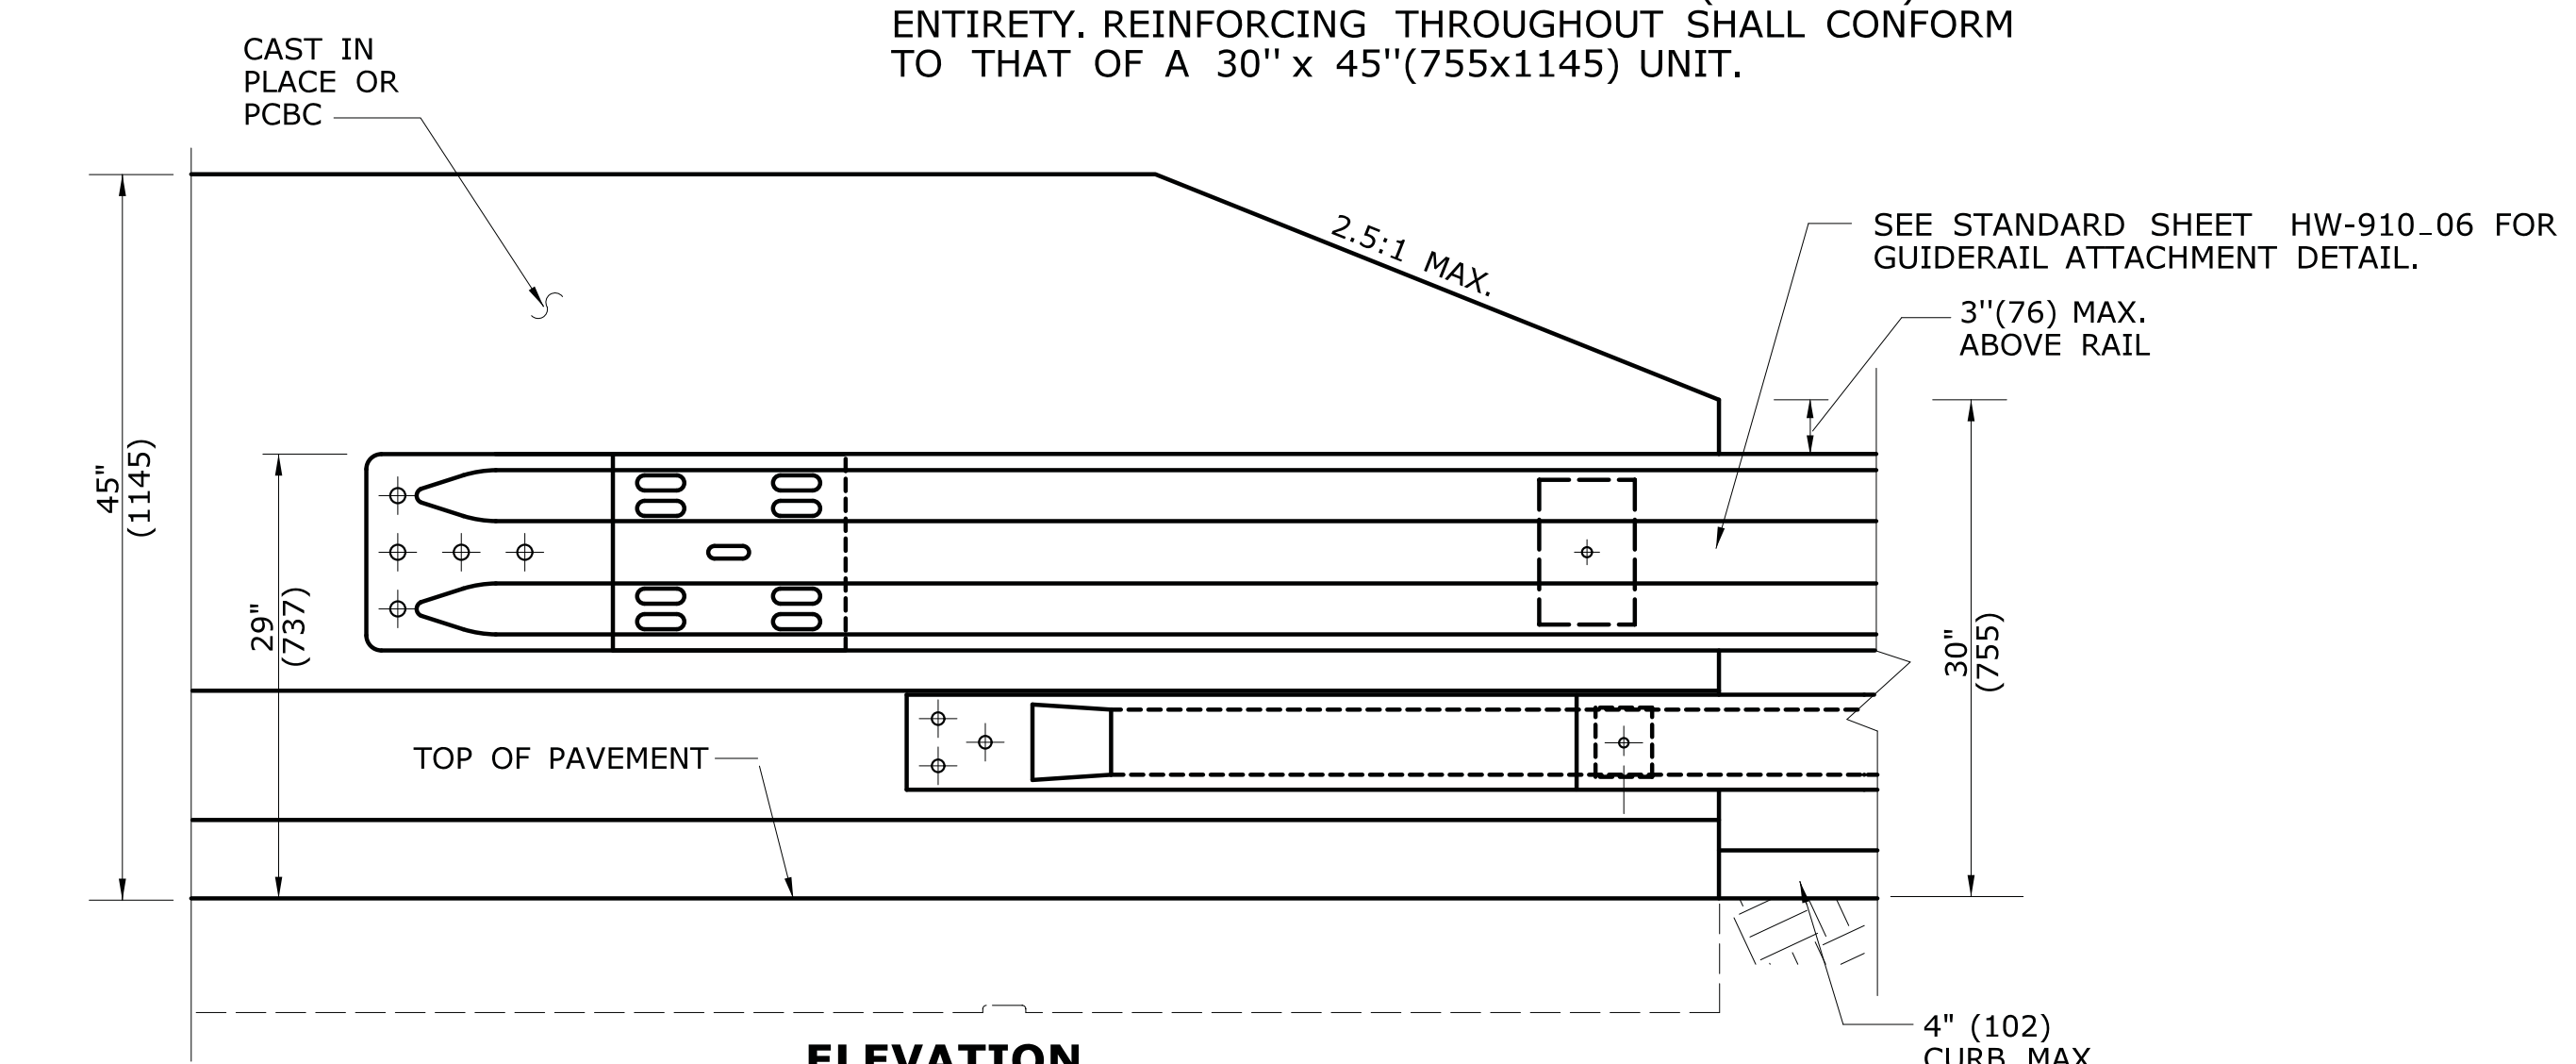


ELEVATION
CONCRETE BARRIER CURB UNIT
END TRANSITION TO GUIDERAIL

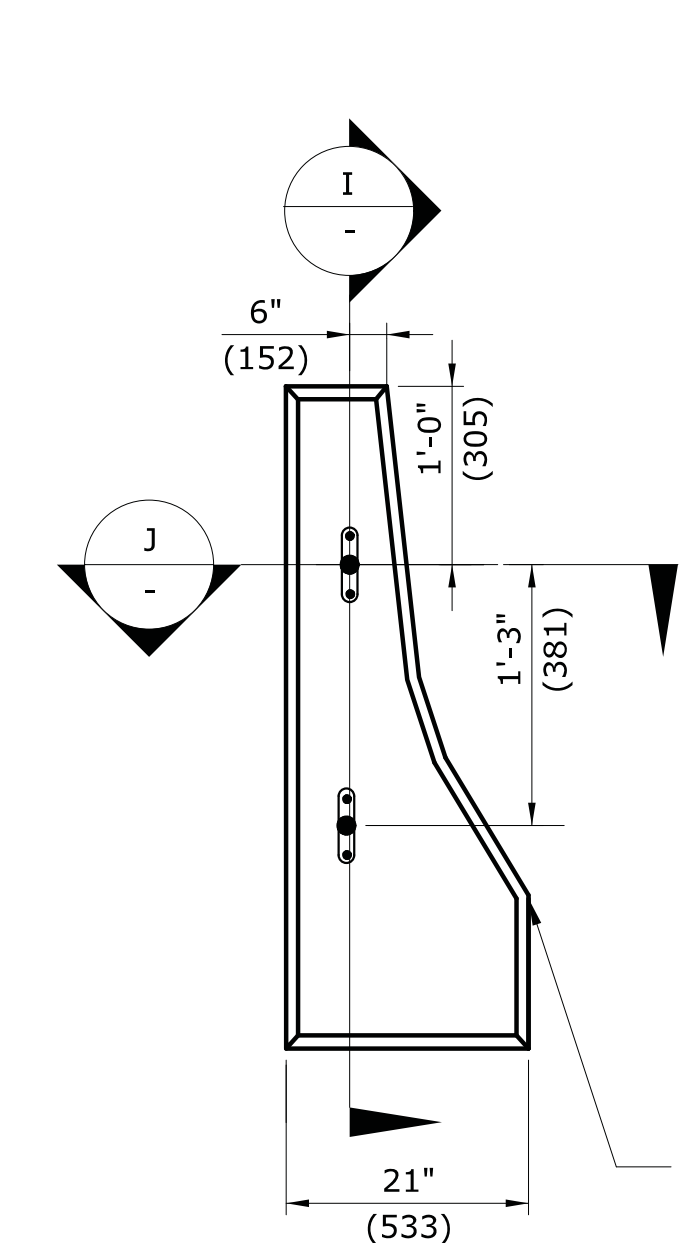

21" x 45"(530x1145) UNIT

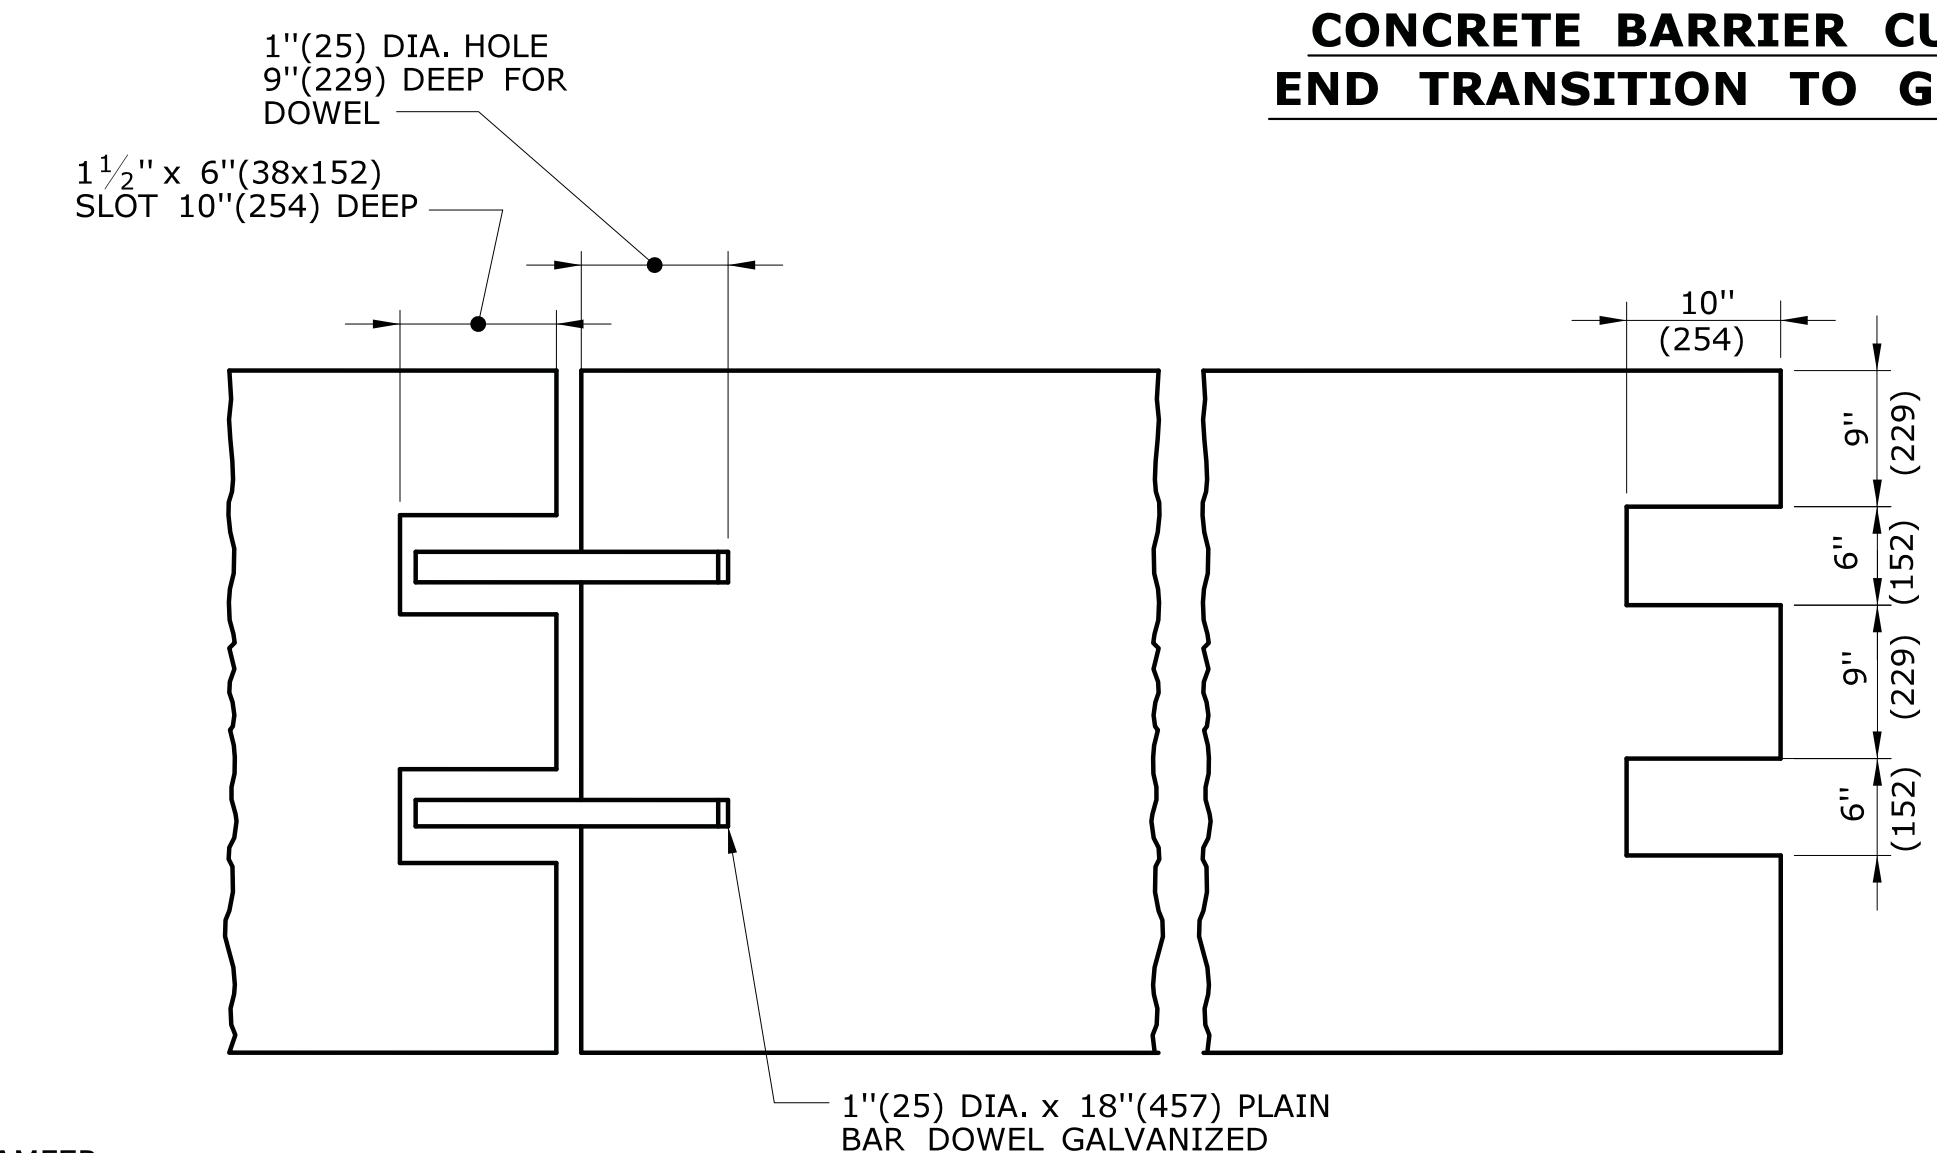


SECTION J

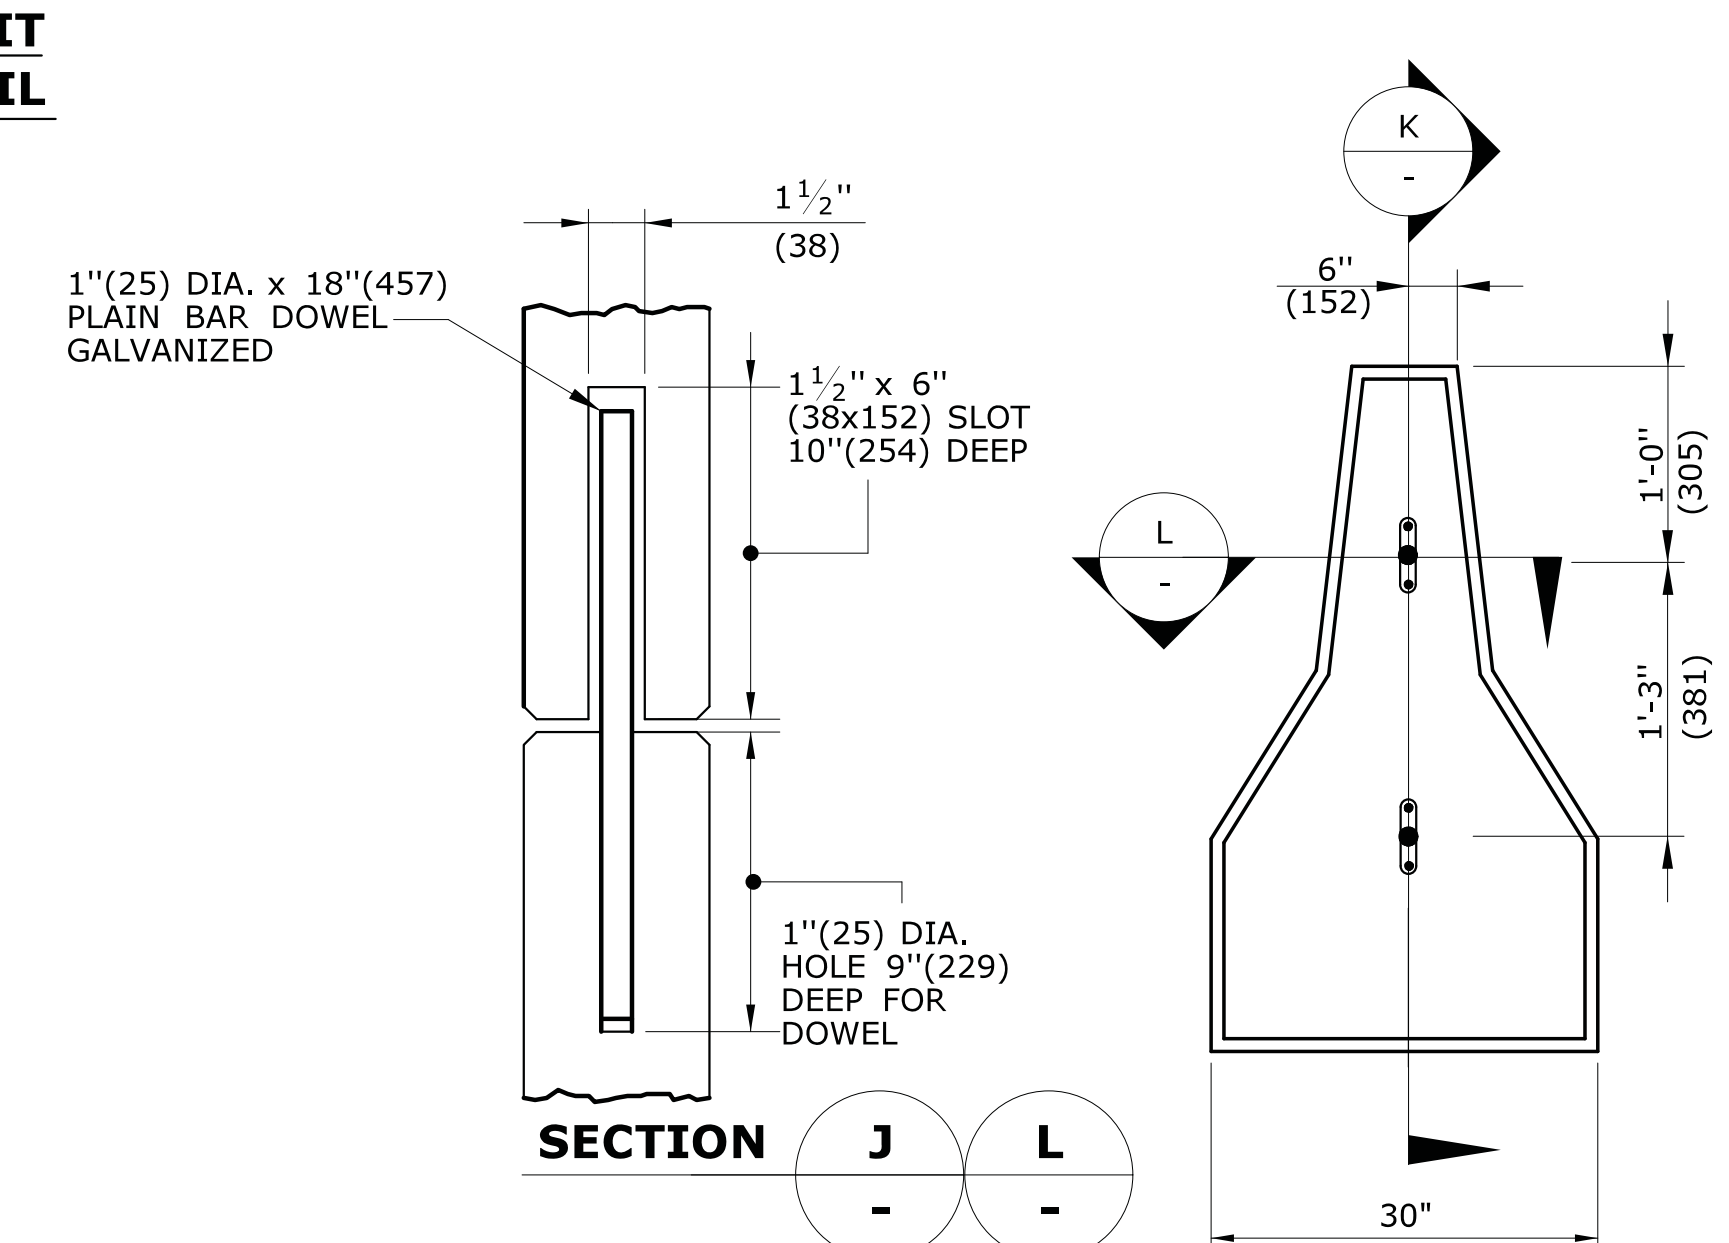

SECTION K


30" x 45"(755x1145) UNIT


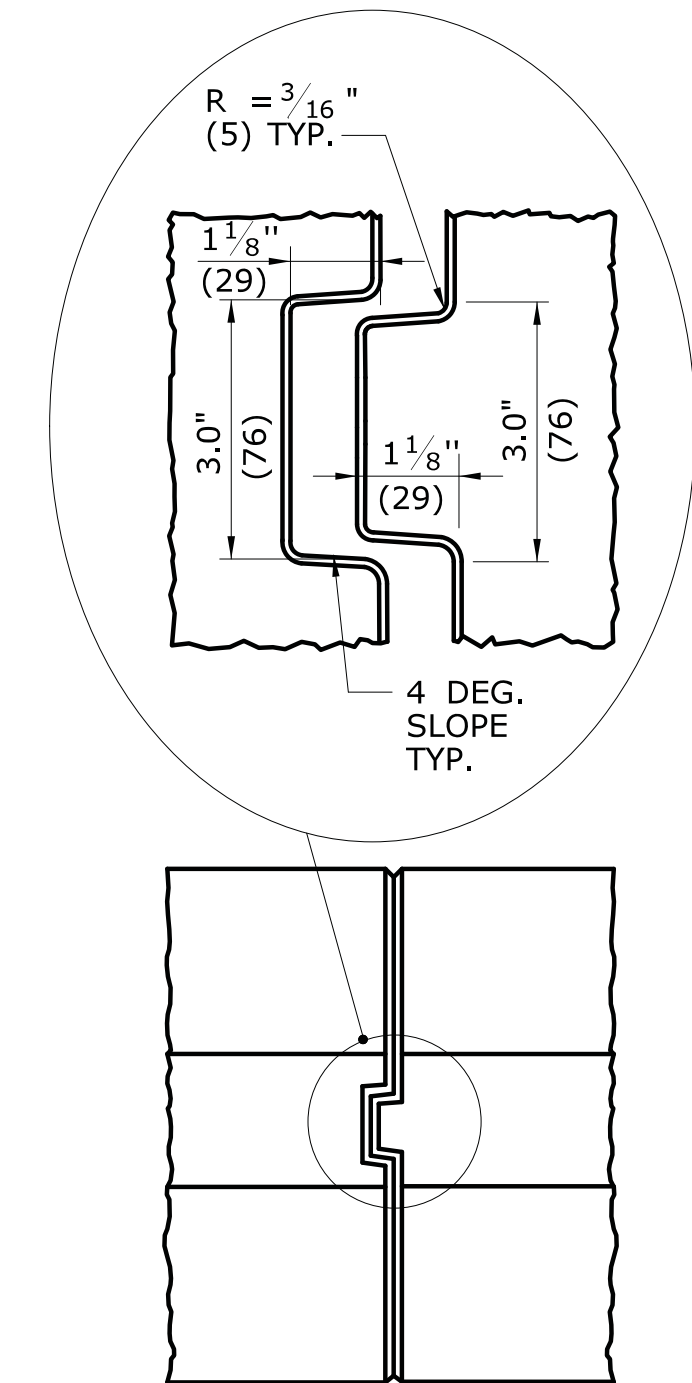


PLAN VIEW 30" x 45"
(755x1145) UNIT ALTERNATE
CONNECTION AT ENDS


GENERAL NOTES:

1. GUIDERAIL ATTACHMENT WHEN REQUIRED SHALL BE CONSTRUCTED AS SHOWN ON THE PLANS OR AS DIRECTED BY THE ENGINEER.
2. WHEN ATTACHING GUIDERAIL, THE END OF THE PCBC SHALL NOT EXTEND VERTICALLY MORE THAN 3" (76) ABOVE THE RAIL HEIGHT FOR ALL LEADING END TREATMENTS. A 2.5:1 MAX. SLOPE OF THE BARRIER MAY BE USED TO ACCOMPLISH THIS.

1	5/13/10	REVISE GENERAL NOTE 2 AND ADD NOTE 3	THE INFORMATION, INCLUDING ESTIMATED QUANTITIES OF WORK, SHOWN ON THESE SHEETS IS BASED ON LIMITED INVESTIGATIONS BY THE STATE AND IS IN NO WAY WARRANTED TO INDICATE THE CONDITIONS OF ACTUAL QUANTITIES OF WORK WHICH WILL BE REQUIRED.	NOT TO SCALE	 STATE OF CONNECTICUT DEPARTMENT OF TRANSPORTATION	SUBMITTED BY: _____ NAME/DATE/TIME: _____ APPROVED BY: _____ NAME/DATE/TIME: _____	CTDOT STANDARD SHEET OFFICE OF ENGINEERING	STANDARD SHEET TITLE: 45" (1145) F- SHAPE PRECAST CONCRETE BARRIER CURB	STANDARD SHEET NO.: HW-821_02b
2	1/12	ADD DETAIL FOR GUIDERAIL ATTACHMENT							
3	7/13	ERRATA - REMOVE SECTION							
-	-	-							
-	-	-							
REV.	DATE	REVISION DESCRIPTION	Plotted Date: 6/14/2013	Filename: CTDOT_HIGHWAY_STD2013.dgn	Model: 28 - HW-821_02b	ALL METRIC DIMENSIONS ARE IN MILLIMETERS (MM) UNLESS OTHERWISE NOTED			

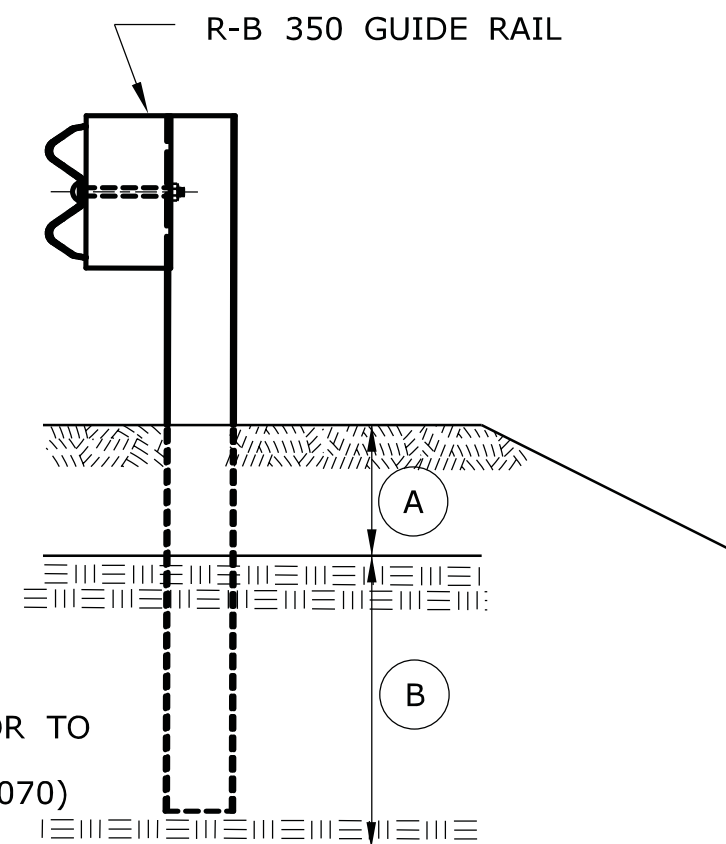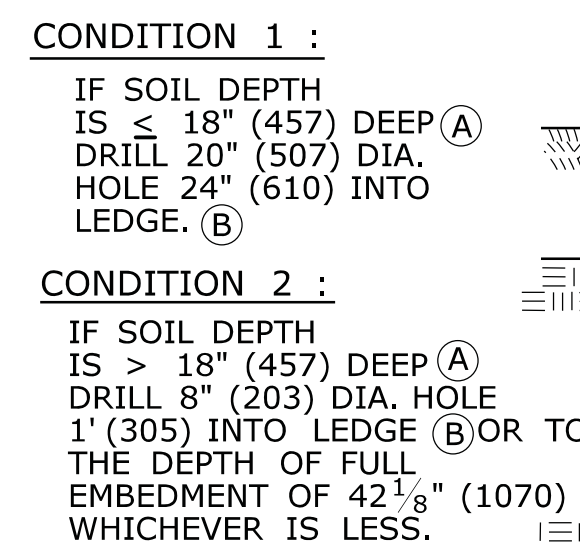


ELEVATION
(SEE NOTE 8)

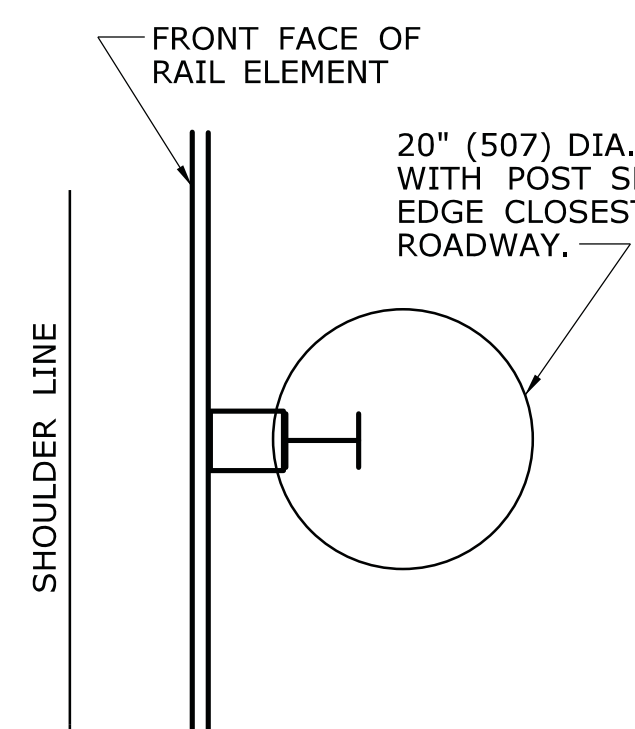

PLAN
CONDITION 1





(SEE NOTE 8)

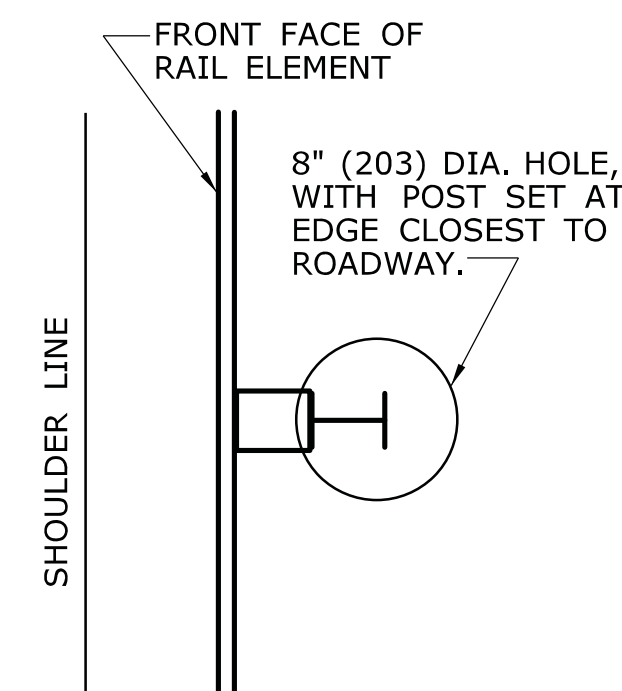

PLAN
CONDITION 2


(SEE NOTE 8)





DRILLING IN ROCK FOR GUIDERAIL POSTS

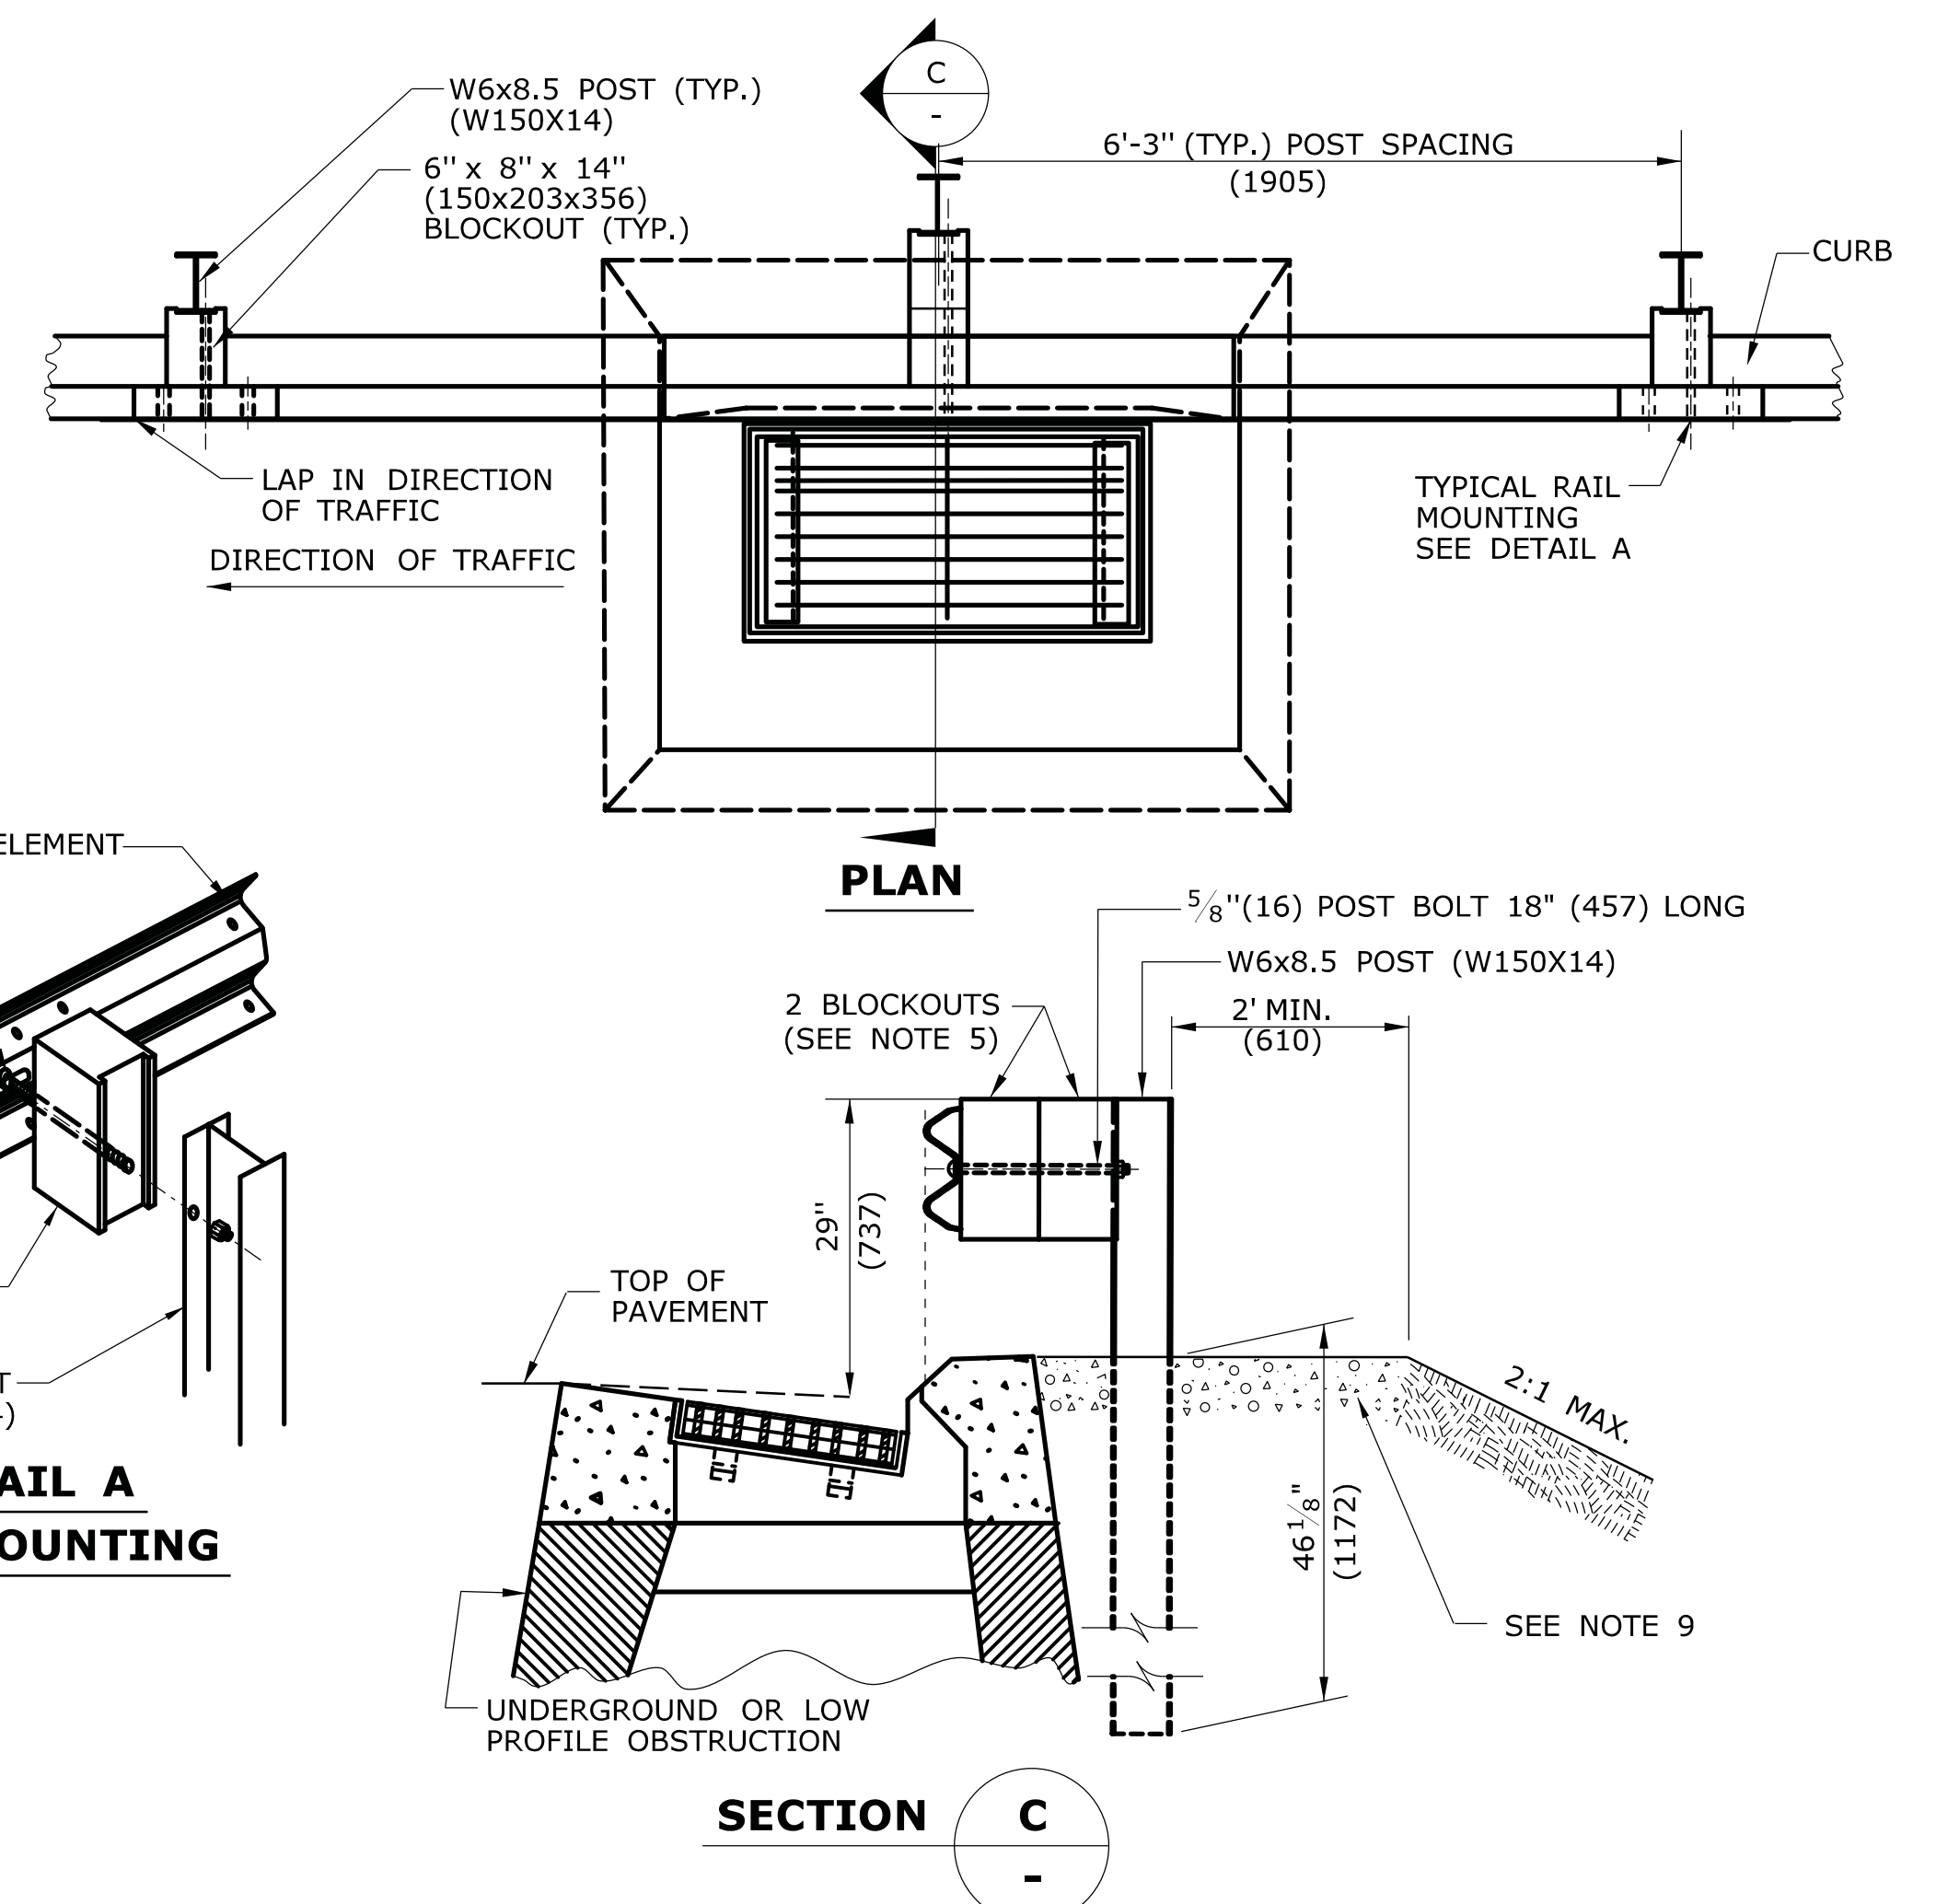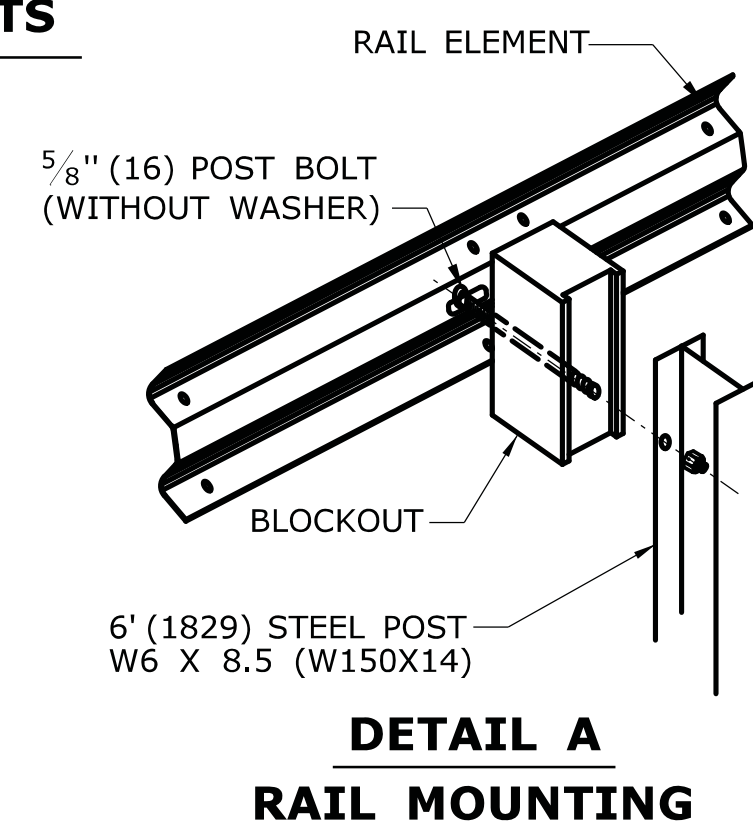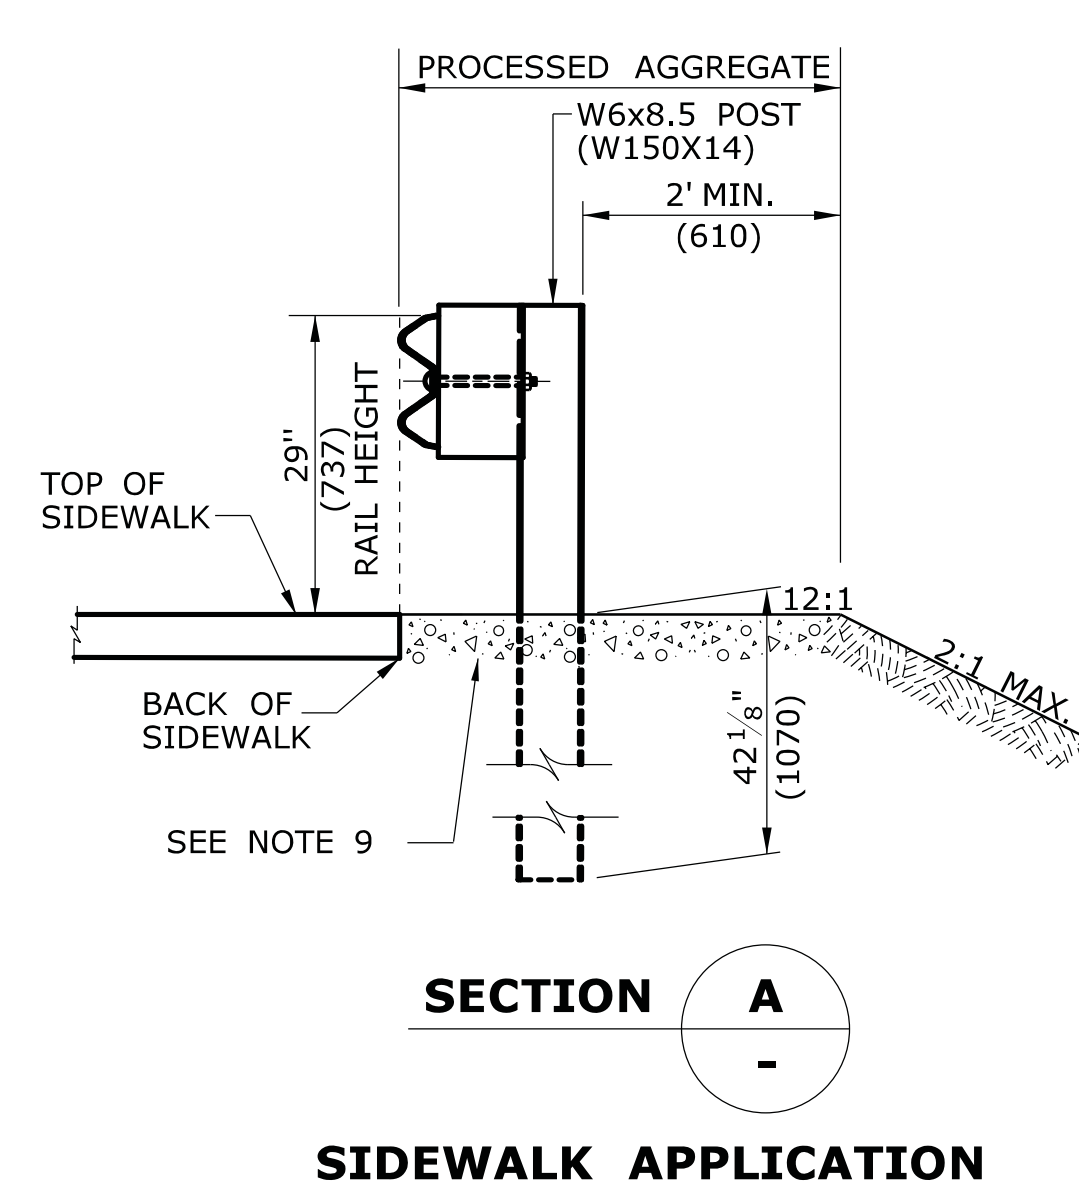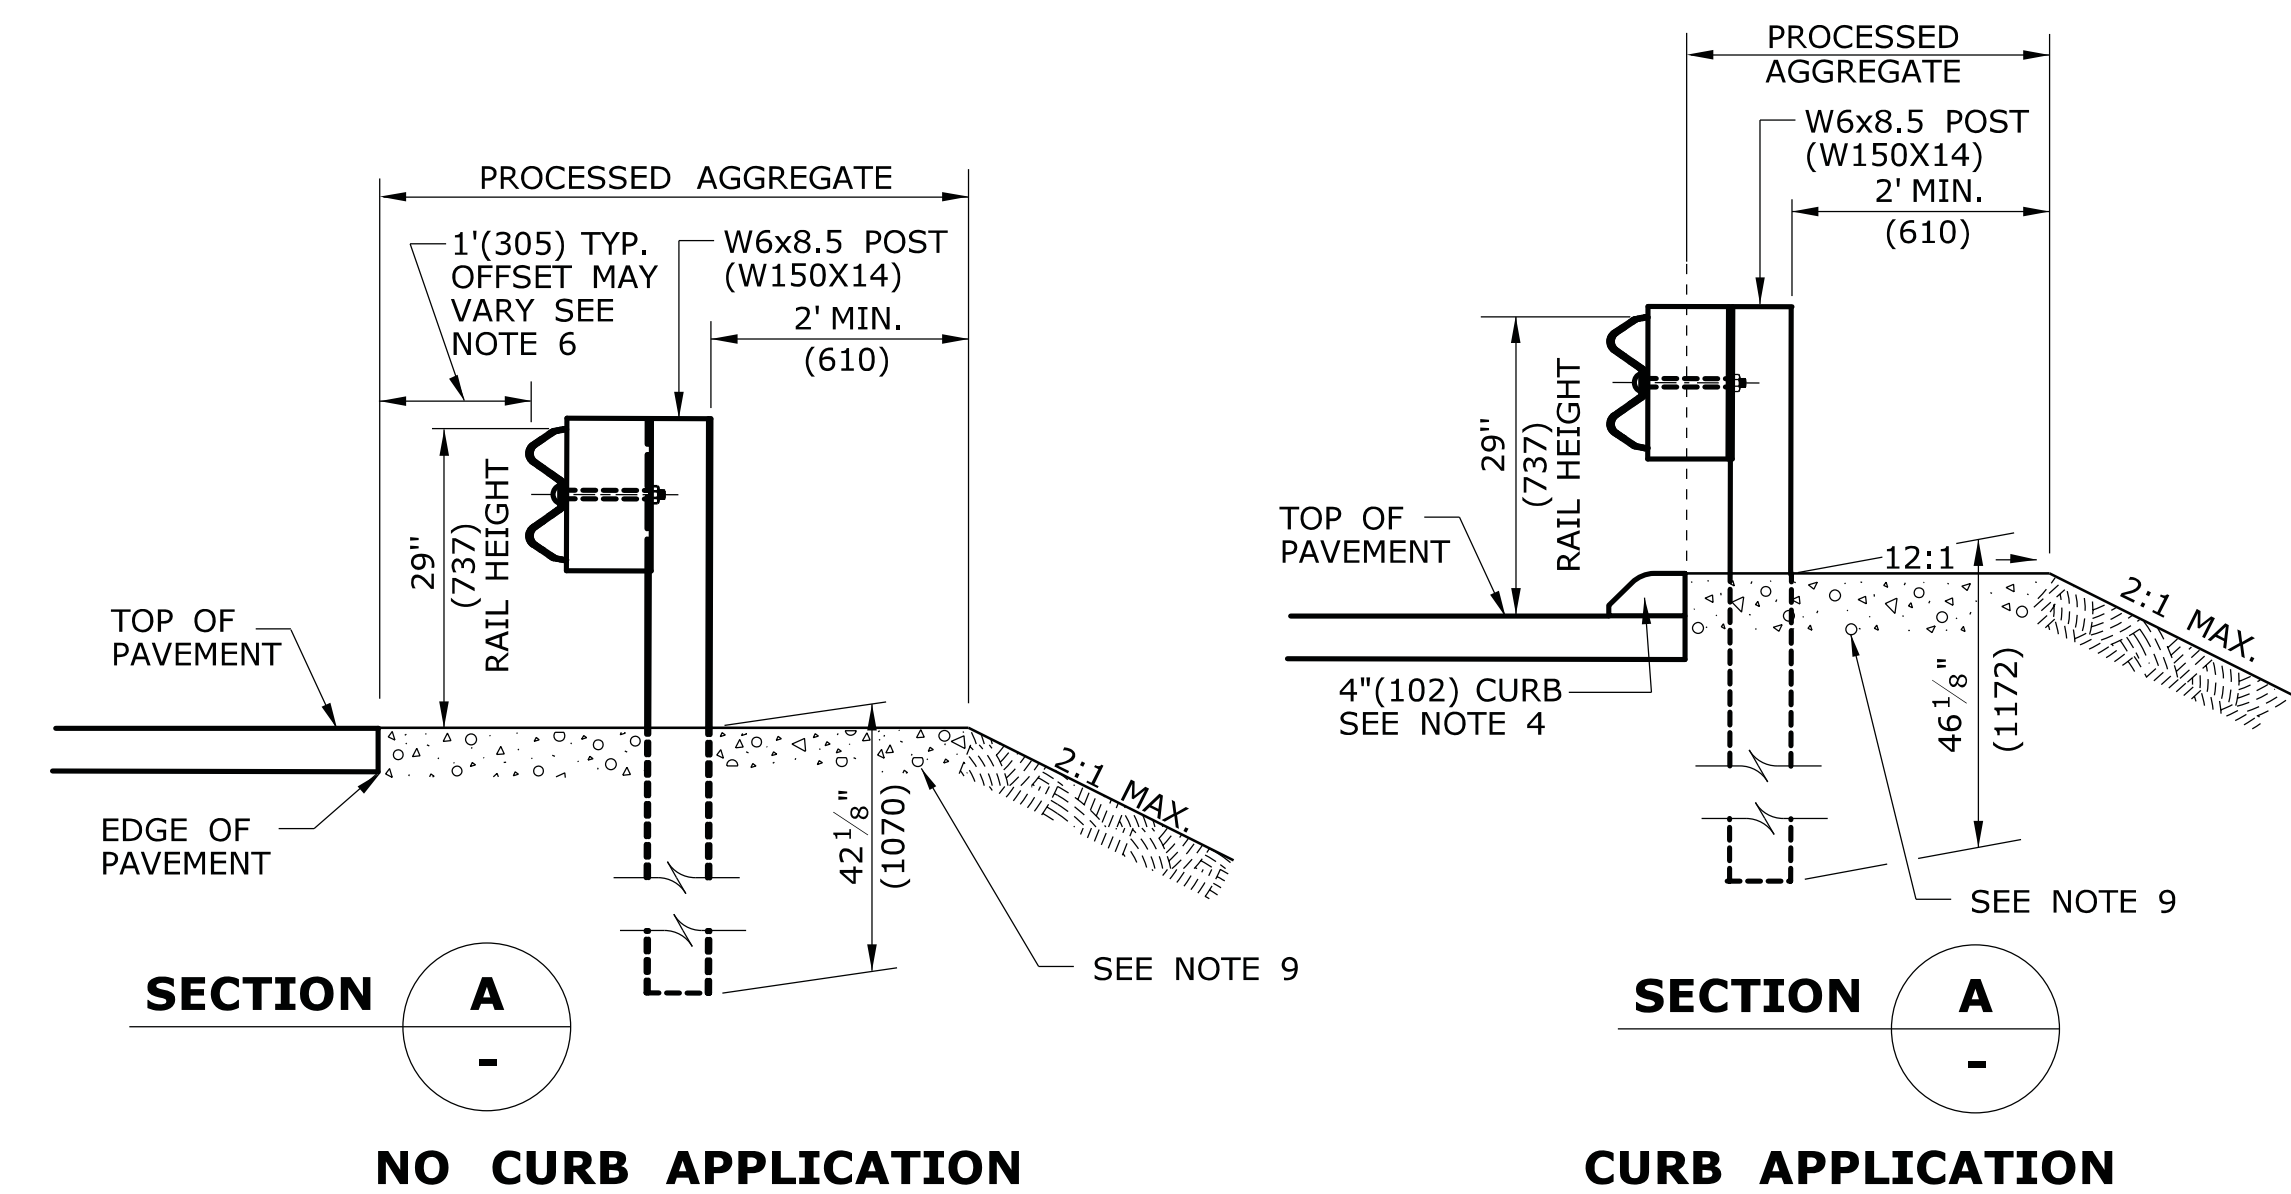


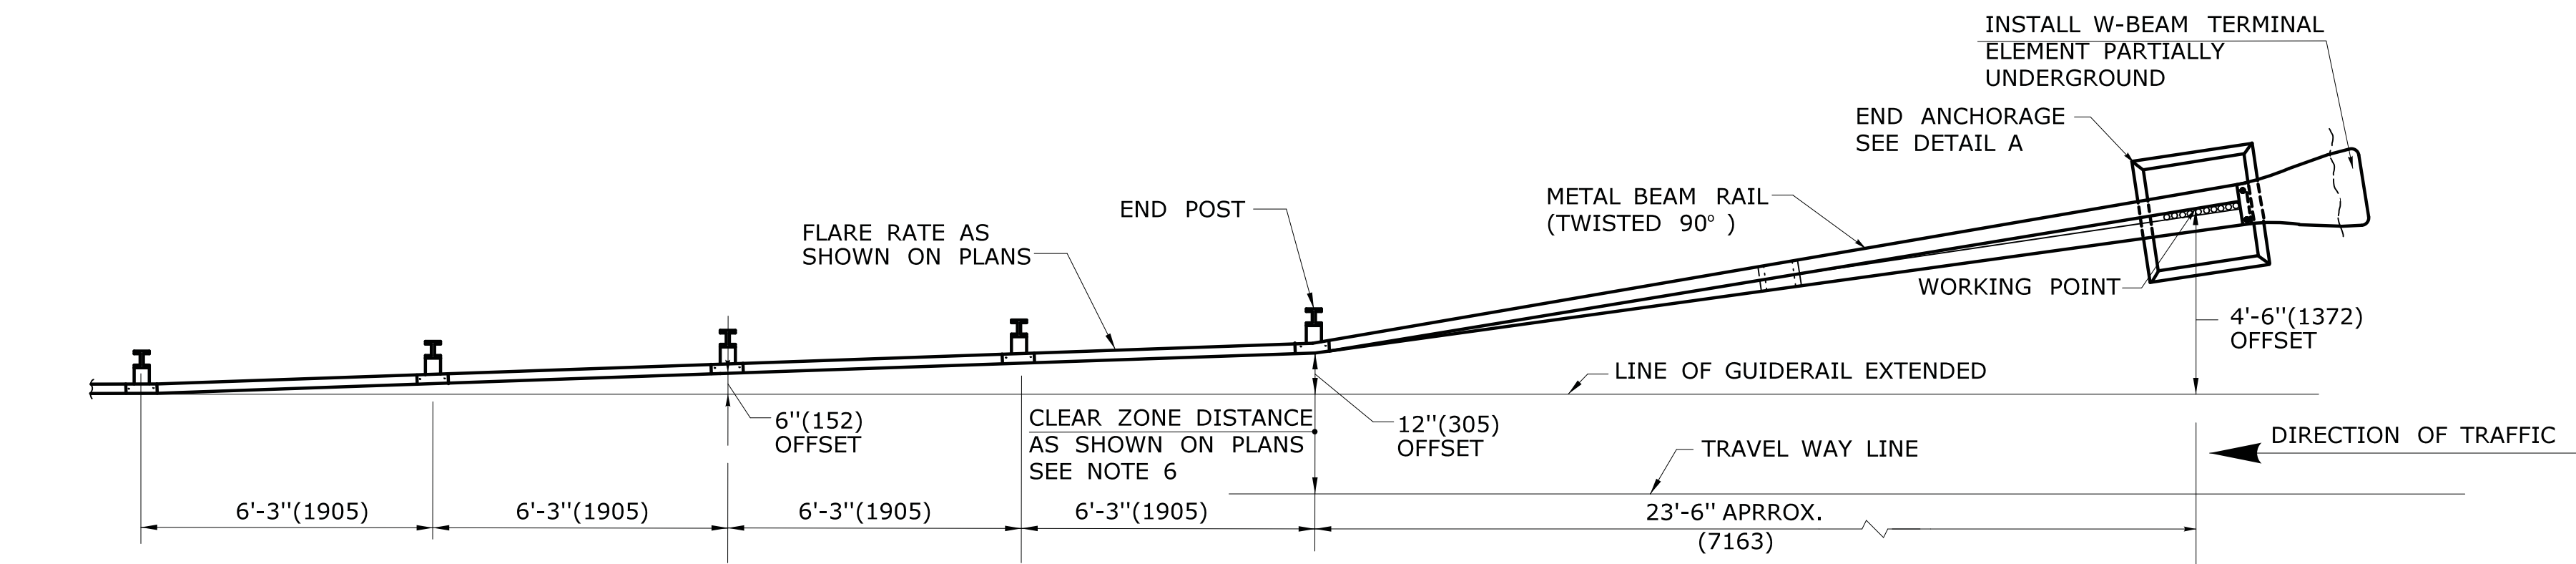
MULTIPLE BLOCKOUT APPLICATION (MAY BE USED TO AVOID UNDERGROUND OR LOW PROFILE OBSTRUCTION)

ALL METRIC DIMENSIONS ARE IN MILLIMETERS (mm) UNLESS OTHERWISE NOTED.


1		6/11	REVISED NOTE 9 FOR USE OF PROCESSED AGGREGATE AND REMOVED NOTE 6 FOR WEATHERING STEEL	-	THE INFORMATION, INCLUDING ESTIMATED QUANTITIES OF WORK, SHOWN ON THESE SHEETS IS BASED ON LIMITED INVESTIGATIONS BY THE STATE AND IS IN NO WAY WARRANTED TO INDICATE THE CONDITIONS OF ACTUAL QUANTITIES OF WORK WHICH WILL BE REQUIRED.	NOT TO SCALE	 <div>STATE OF CONNECTICUT DEPARTMENT OF TRANSPORTATION</div>	Submitted By: _____ Name/Date/Time: _____ Approved By: _____ Name/Date/Time: _____	CTDOT STANDARD SHEET OFFICE OF ENGINEERING	STANDARD SHEET TITLE: METAL BEAM RAIL (TYPE R-B 350) GUIDERAIL	STANDARD SHEET NO.: HW-910_02
-	-	-	-								
-	-	-	-								
-	-	-	-								
-	-	-	-								
-	-	-	-								
REV	DATE	REVISION DESCRIPTION			Plotted Date: 5/10/2011		Filename: CTDOT_HIGHWAY STD_1JUN2011.dan Model: 37- HW-910_02				

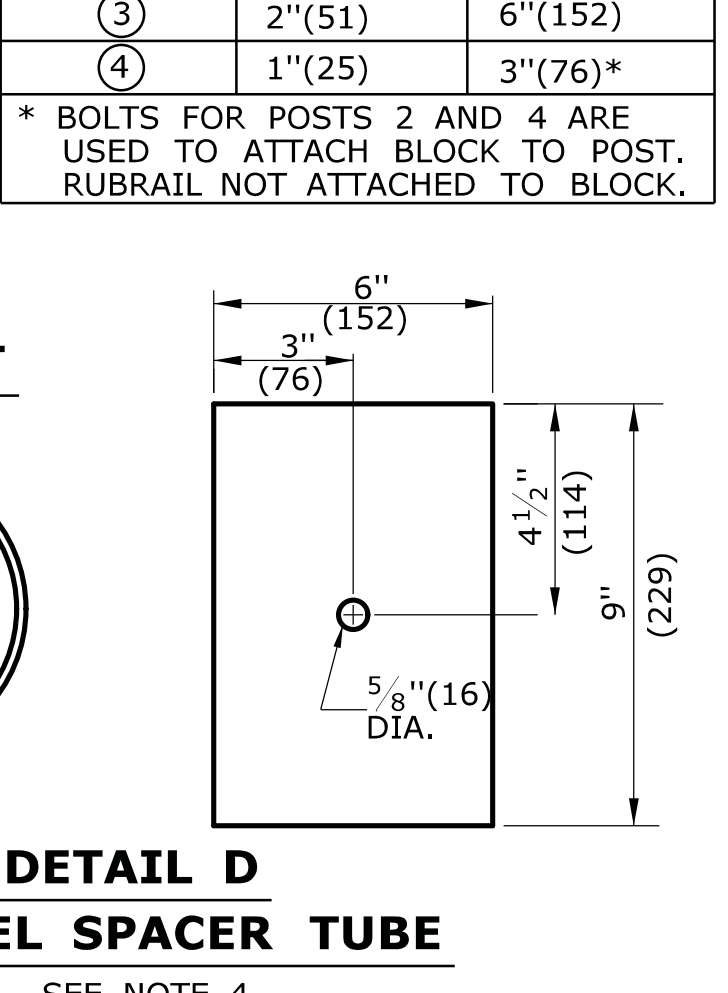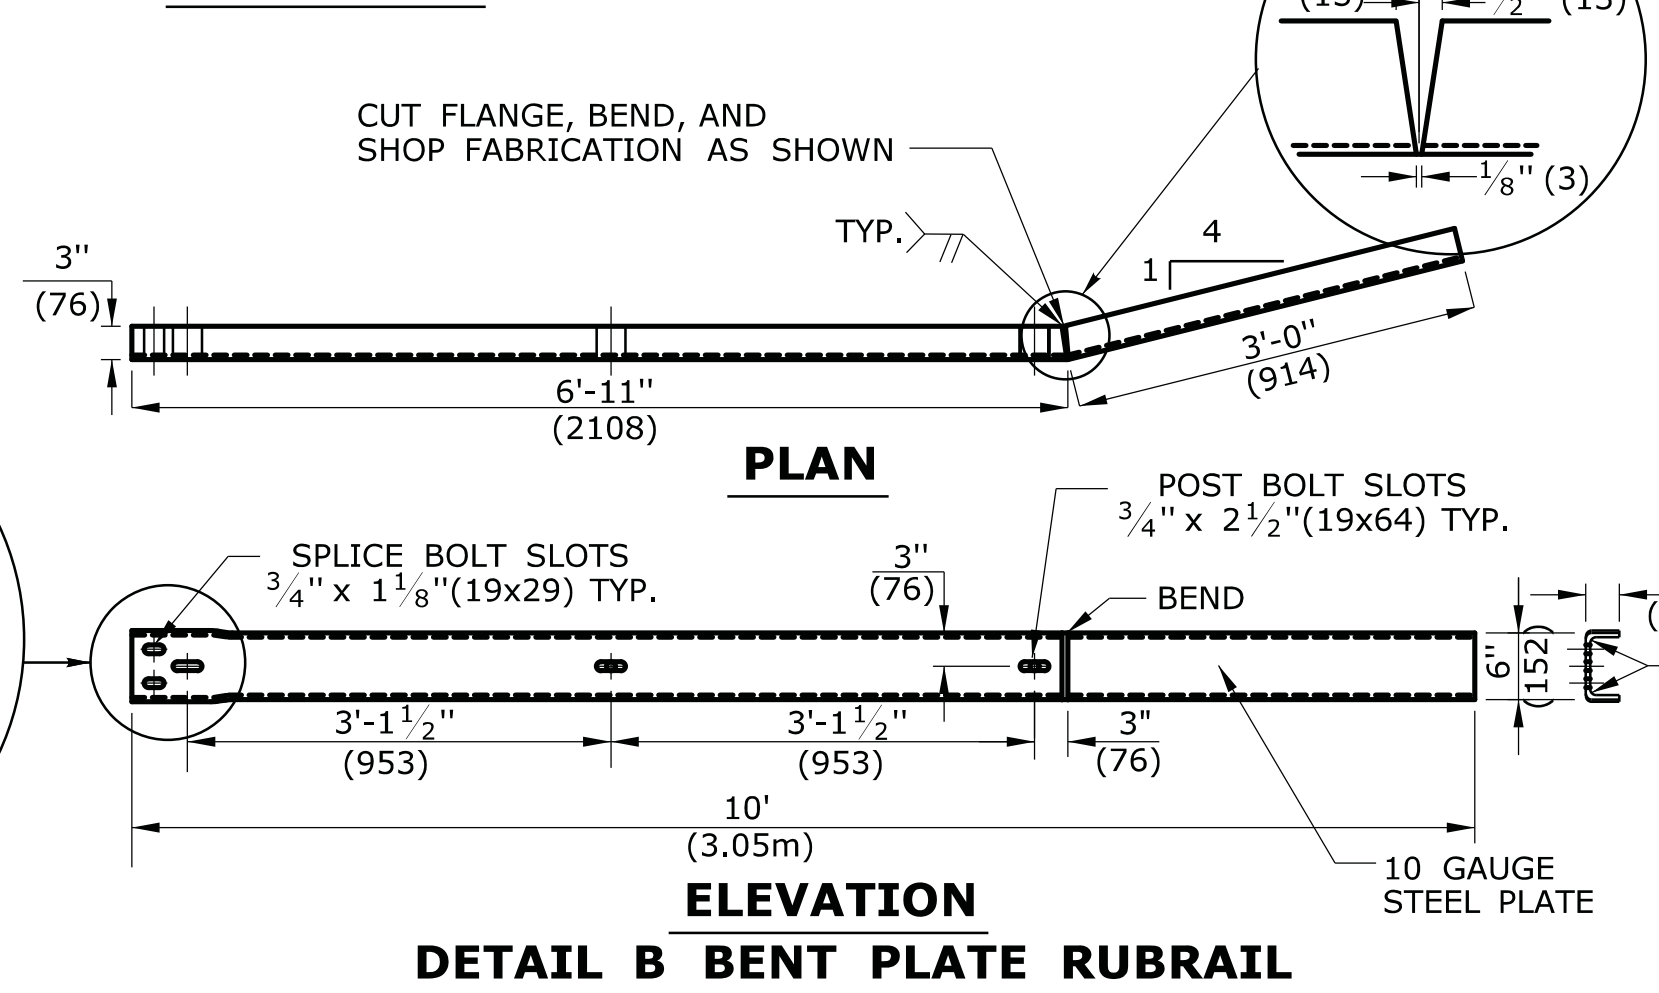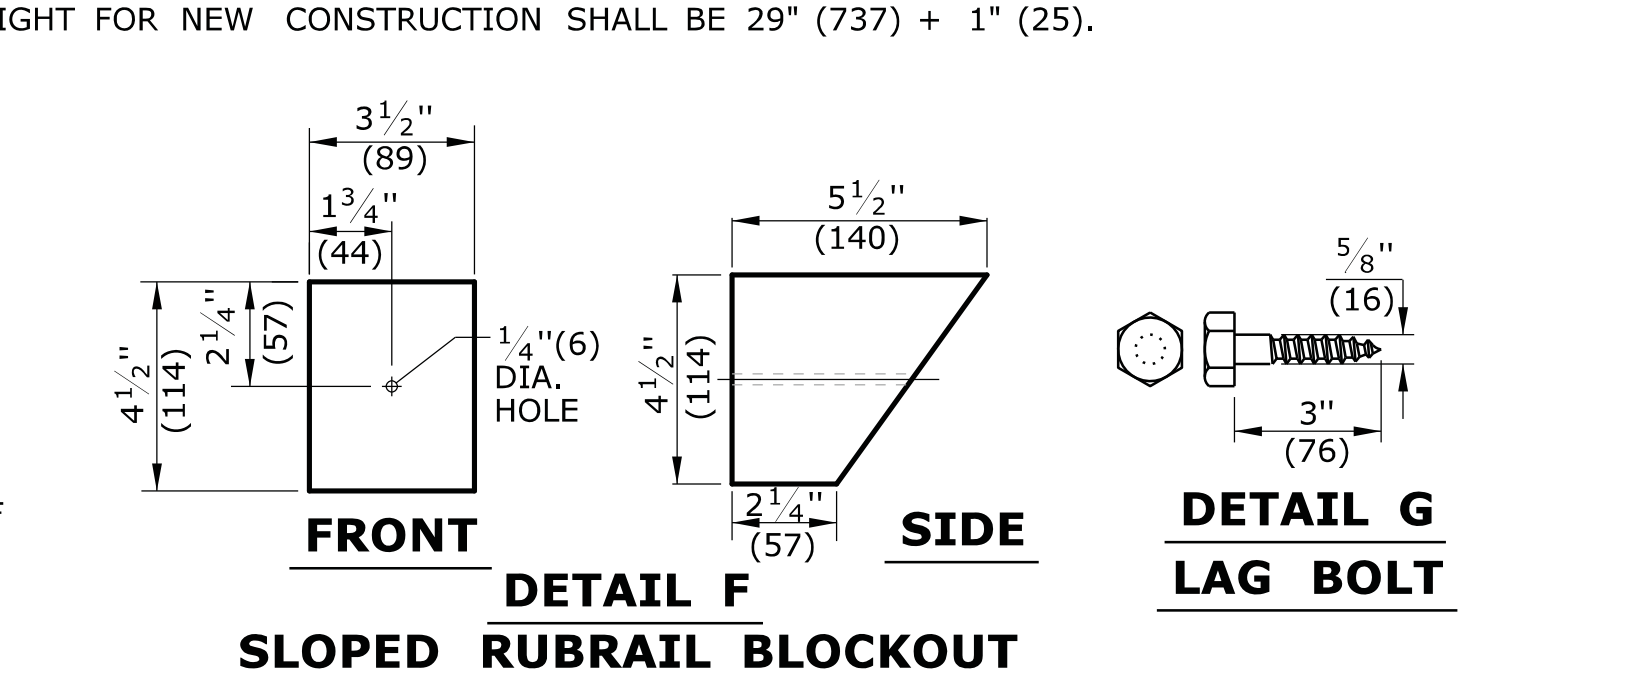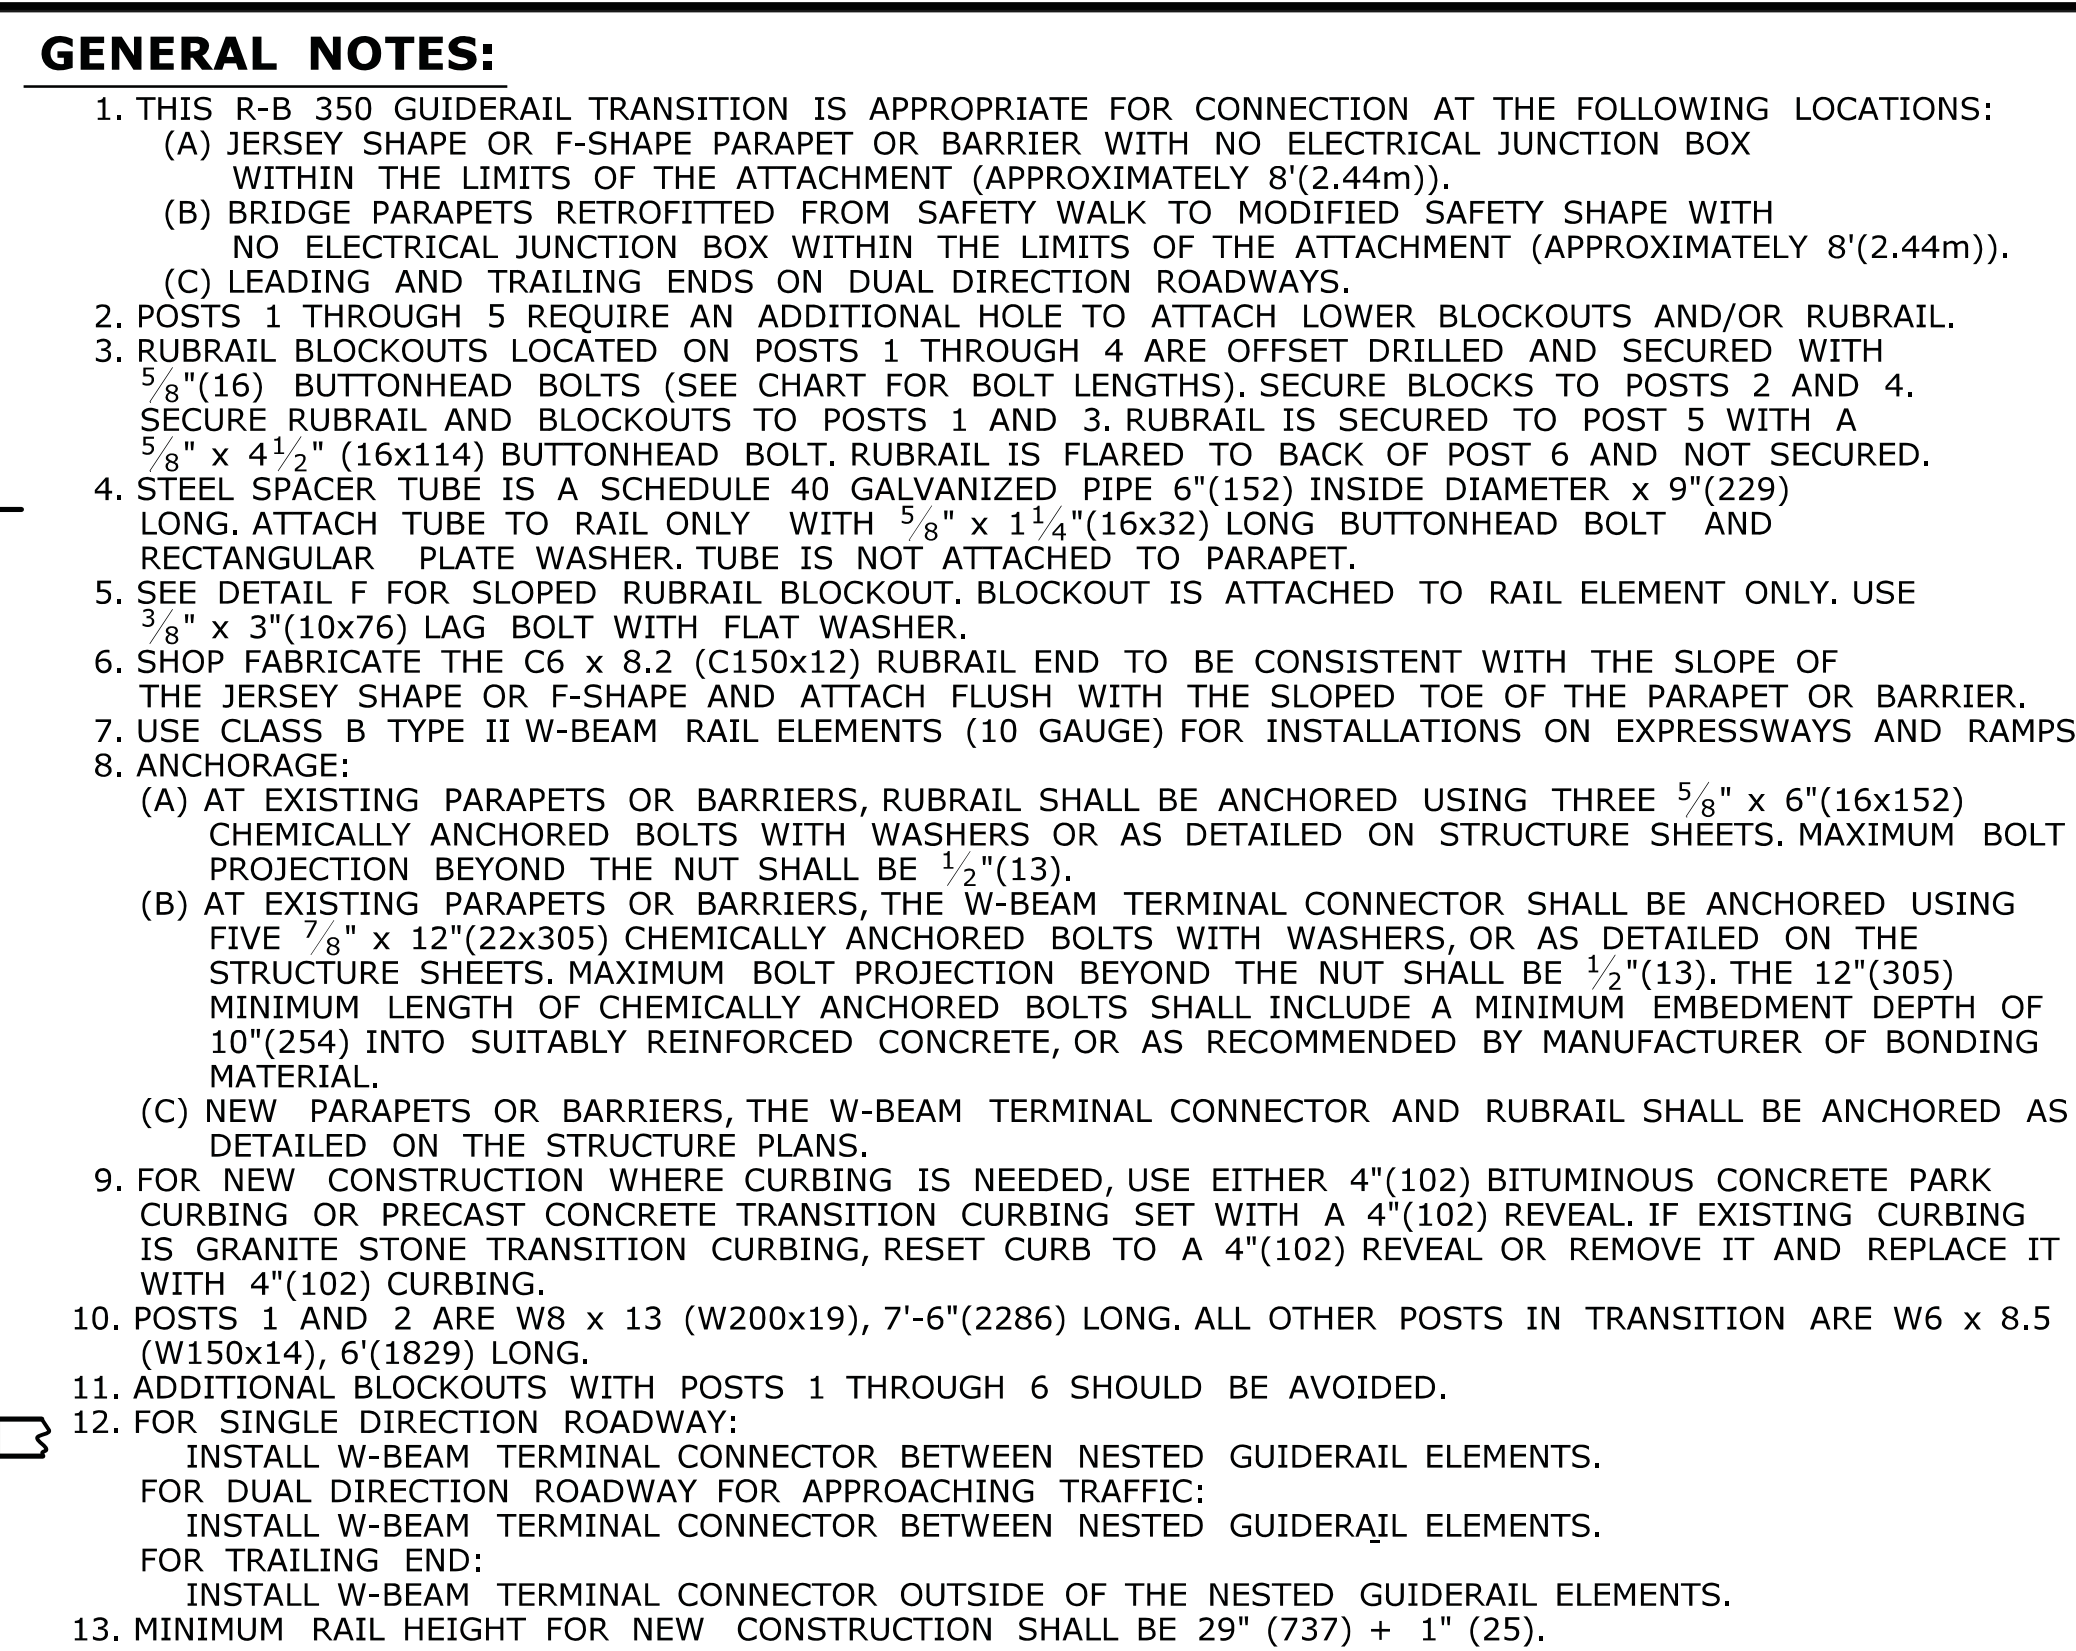

16/11		REVISED NOTE 8 FOR USE OF CHEMICAL ANCHORS AND PAY ITEM CHANGED TO SAFETY SHAPE.	-	THE INFORMATION, INCLUDING ESTIMATED QUANTITIES OF WORK, SHOWN ON THESE SHEETS IS BASED ON LIMITED INVESTIGATIONS BY THE STATE AND IS IN NO WAY WARRANTED TO INDICATE THE CONDITIONS OF ACTUAL QUANTITIES OF WORK WHICH WILL BE REQUIRED.	NOT TO SCALE	<div><div>STATE OF CONNECTICUT DEPARTMENT OF TRANSPORTATION</div></div>	Submitted By: _____ Name/Date/Time: _____ Approved By: _____ Name/Date/Time: _____	CTDOT STANDARD SHEET OFFICE OF ENGINEERING	STANDARD SHEET TITLE: R-B 350 BRIDGE ATTACHMENT TO SAFETY SHAPE PARAPET	STANDARD SHEET NO.: HW-910_06
-	-	-	-							
-	-	-	-							
-	-	-	-							
-	-	-	-							
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REV.	DATE	REVISION DESCRIPTION	Plotted Date: 5/10/2011		Filename: CTDOT.HIGHWAY.STD.JUNE2011.dgn Model: 41 - HW-910.06					



PLAN

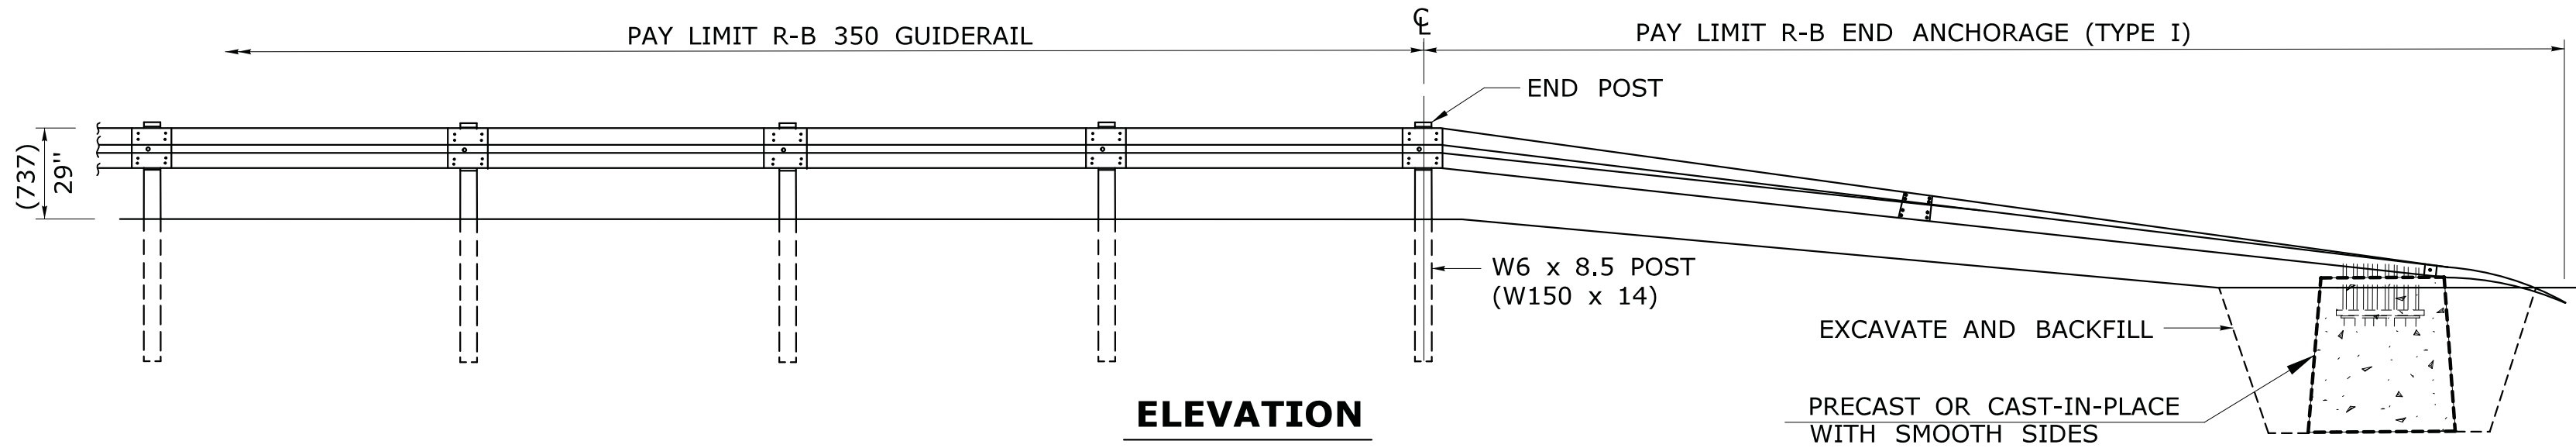

ELEVATION


**R-B END ANCHORAGE TYPE I
(ROADSIDE APPLICATION)**

GENERAL NOTES:

1. R-B END ANCHORAGE TYPE I INSTALLED ON FREEWAYS AND RAMPS SHALL USE CLASS B (10 GAUGE) TERMINAL AND W-BEAM RAIL ELEMENTS. ALL OTHER R-B END ANCHORAGE TYPE I SHALL USE CLASS A (12 GAUGE) TERMINAL AND W-BEAM RAIL ELEMENTS.
2. R-B END ANGHORAGE TYPE II SHALL USE CLASS A (12 GAUGE) TERMINAL AND W-BEAM RAIL ELEMENTS.
3. OTHER RADII WHICH CAN BE DEMONSTRATED TO PROVIDE THE INSTALLATIONS SHOWN FOR END ANCHORAGE TYPE II MAY BE APPROVED.
4. J-HOOK BOLTS MAY BE SUBSTITUTED FOR BOTTOM PLATE ANCHORAGE IN CONCRETE END ANCHORS USING THE SAME SIZE, STRENGTH, AND LENGTH AS NOTED ON THE PLANS.
5. MINIMUM RAIL HEIGHT FOR NEW CONSTRUCTION SHALL BE 29" (737) + 1' (25).
6. R-B TYPE I END ANCHOR: INSTALL LEADING END USING DESIGN CLEAR ZONE DISTANCE MEASURED FROM TRAVEL WAY LINE TO END POST AS SHOWN ON PLANS, THEN PLACE CONCRETE ANCHOR 4'-6"(1372) FROM THE LINE OF GUIDERAIL EXTENSION. INSTALL TRAILING END ON DUAL DIRECTION ROADWAYS IN THE SAME MANNER EXCEPT MEASURE CLEAR ZONE FROM THE DOUBLE YELLOW LINE. INSTALL TRAILING END ON SINGLE DIRECTION ROADWAYS MEASURED FROM THE GUIDERAIL LINE EXTENDED AND OFFSET 4'-6" (1372).

R-B TYPE II END ANCHOR: INSTALL ONLY ON ROADWAYS WITH DESIGN SPEEDS < 45mph (72kph). FOR DUAL DIRECTION ROADWAYS, INSTALL IN THE SAME MANNER AS TYPE I END ANCHOR FOR BOTH LEADING AND TRAILING END USING DESIGN CLEAR ZONE DISTANCE EXCEPT PLACE CONCRETE ANCHOR 2'-4" (711) MEASURED FROM THE LINE OF GUIDERAIL EXTENDED. INSTALL TRAILING END ON SINGLE DIRECTION ROADWAYS MEASURED FROM THE GUIDERAIL LINE EXTENDED AND OFFSET 2'-4" (711).

7. SEE HW-911.04 FOR TYPICAL END ANCHOR GRADING PLAN.

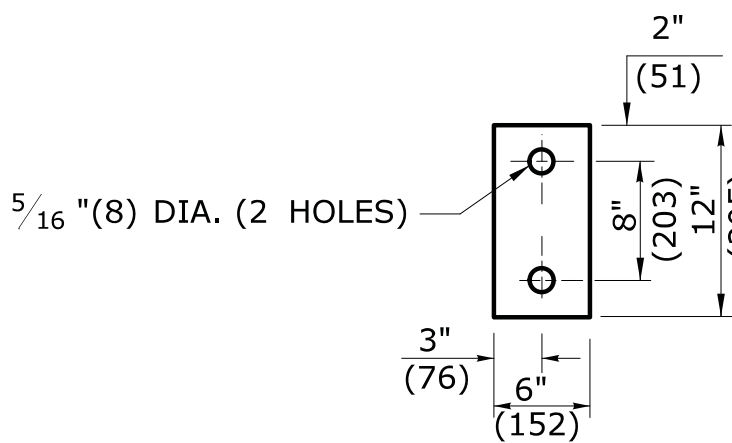


DETAIL B


TYPE 2 OBJECT MARKER

SIGN # 51-5030

OBJECT MARKER FACE SHALL BE YELLOW TYPE III RETROREFLECTORIZED. THE BOTTOM OF TYPE 2 OBJECT MARKER SHALL BE 4'(1219) ABOVE GROUND LEVEL MOUNTED ON METAL DELINEATOR POST. IT SHALL BE USED TO IDENTIFY CULVERT ENDS AND TYPE II END ANCHORS, OR AS DIRECTED BY THE ENGINEER.

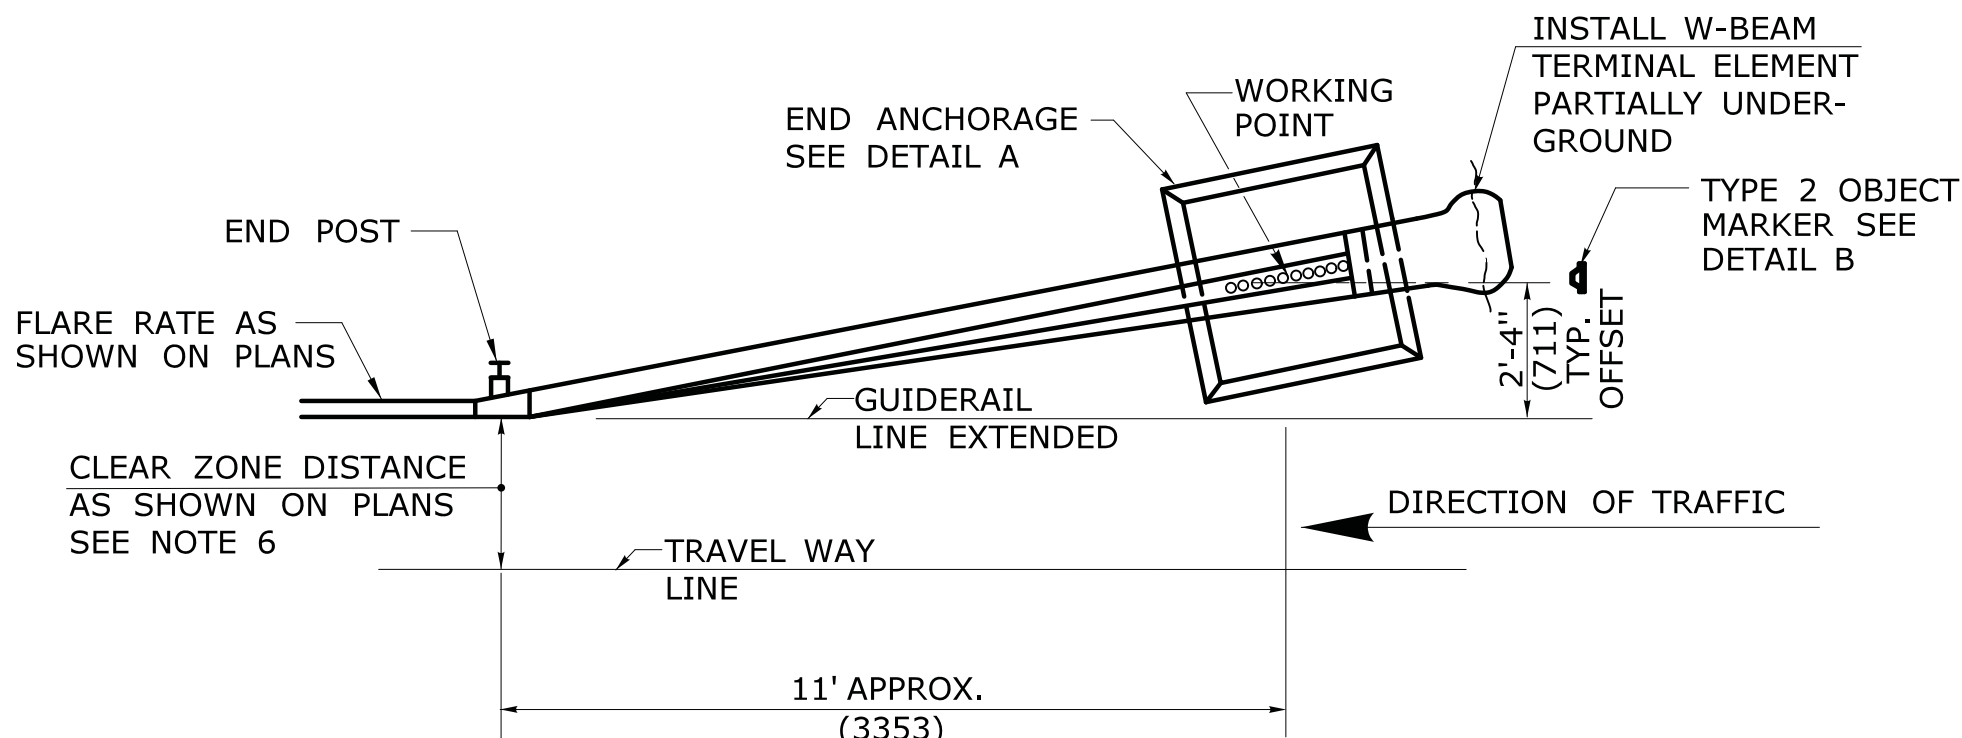


PLAN

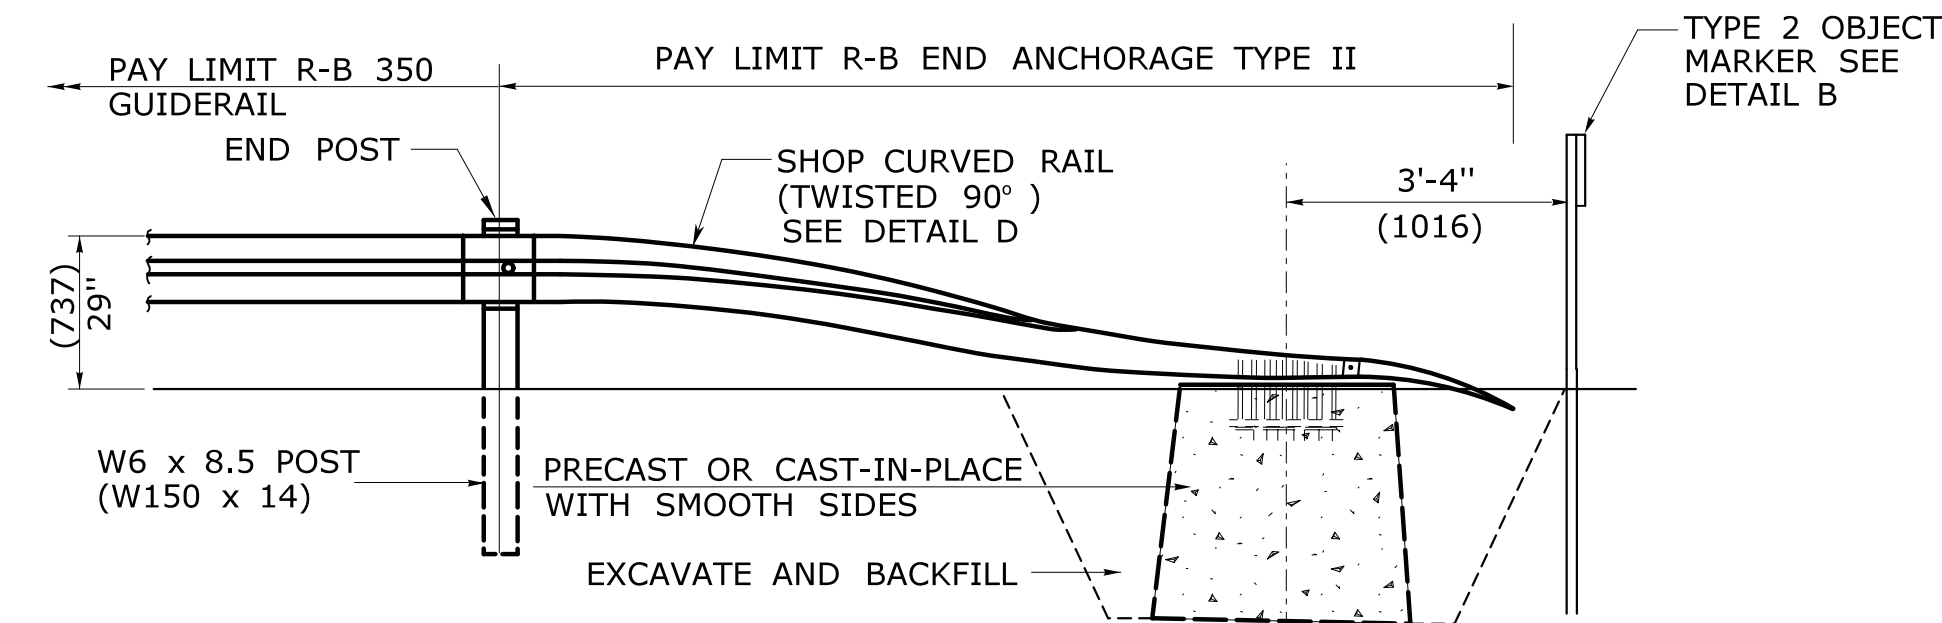


ELEVATION

**R-B END ANCHORAGE TYPE II
SEE NOTE 2**

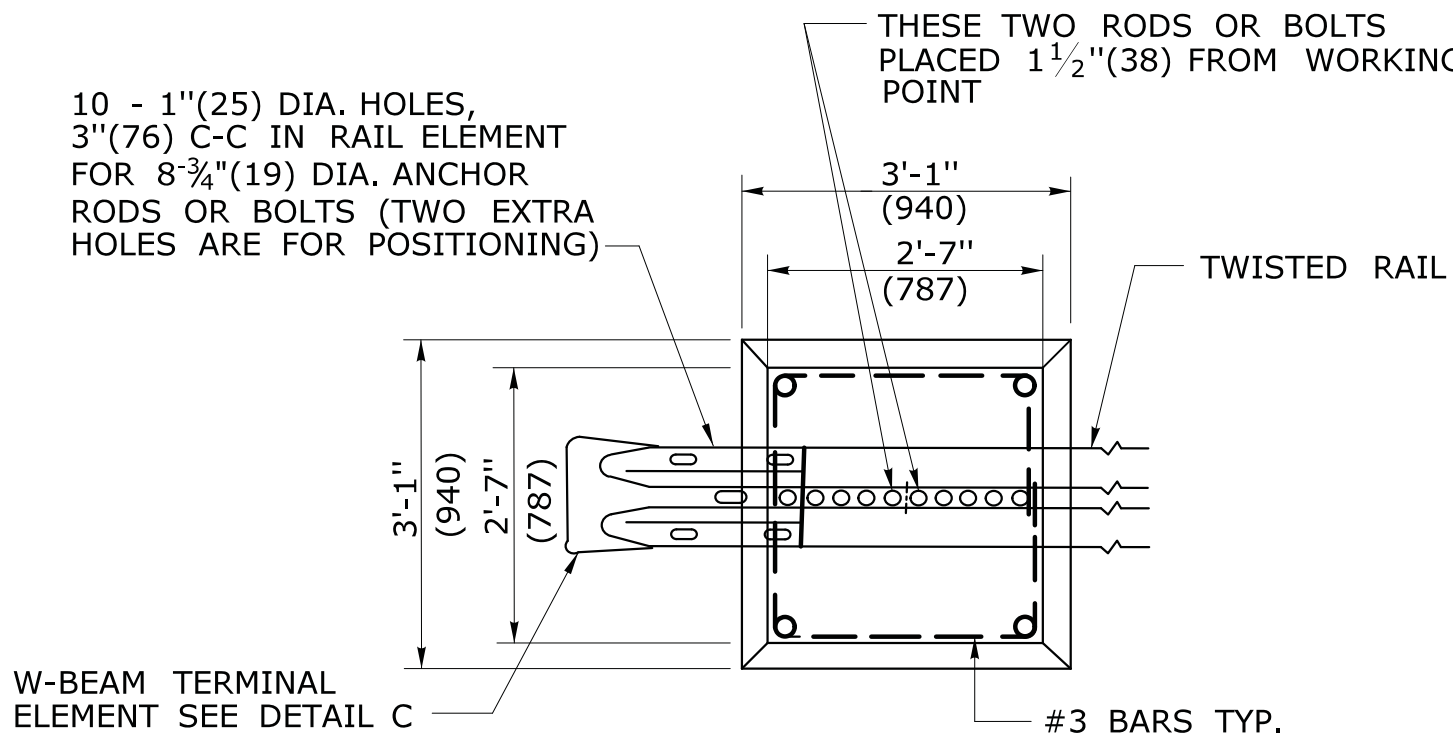

PLAN

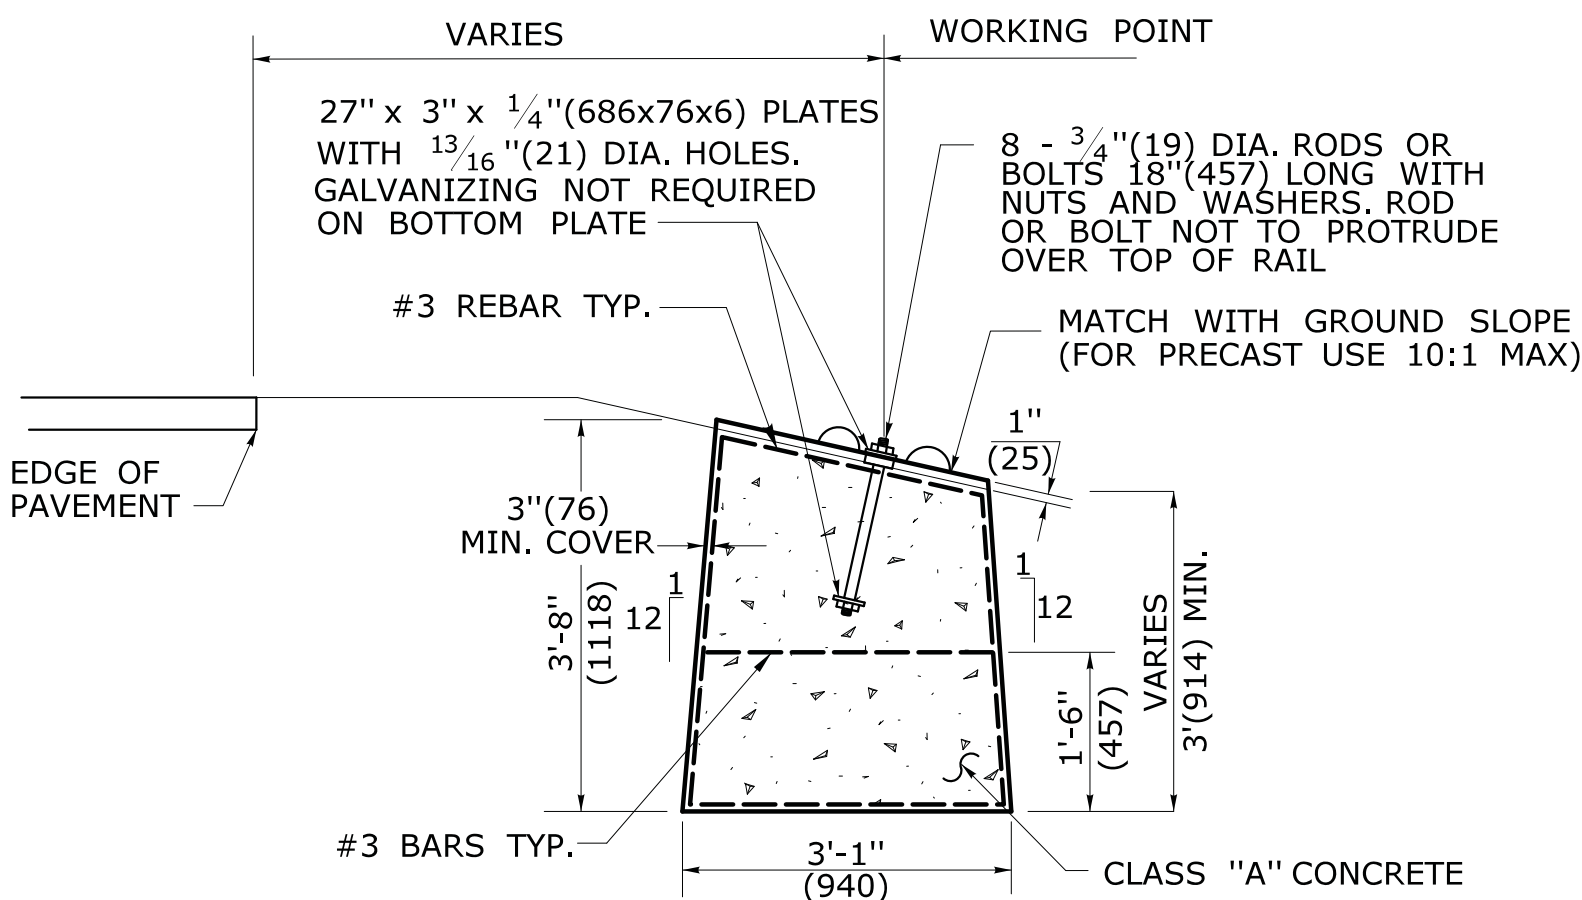


ELEVATION

DETAIL A


ROADSIDE CONCRETE END ANCHOR

SEE NOTE 4

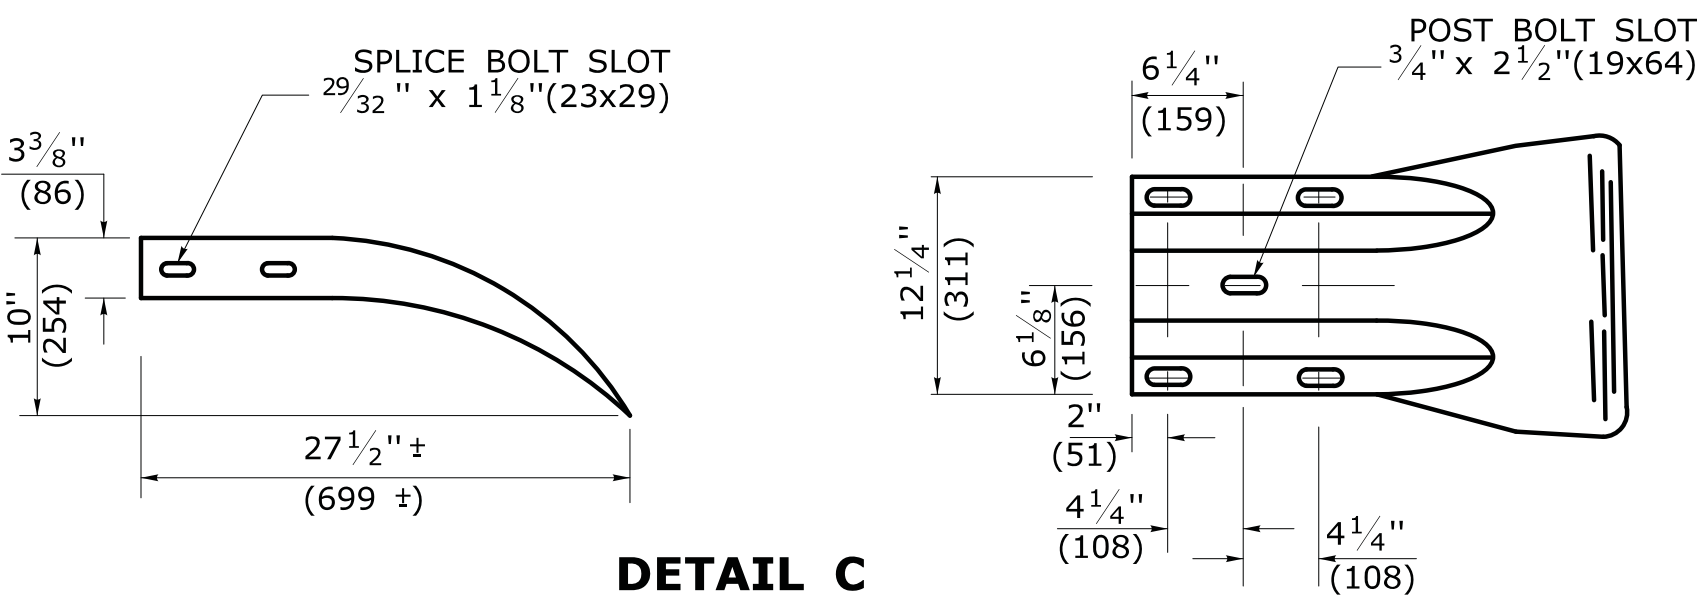

DETAIL C

W-BEAM TERMINAL ELEMENT

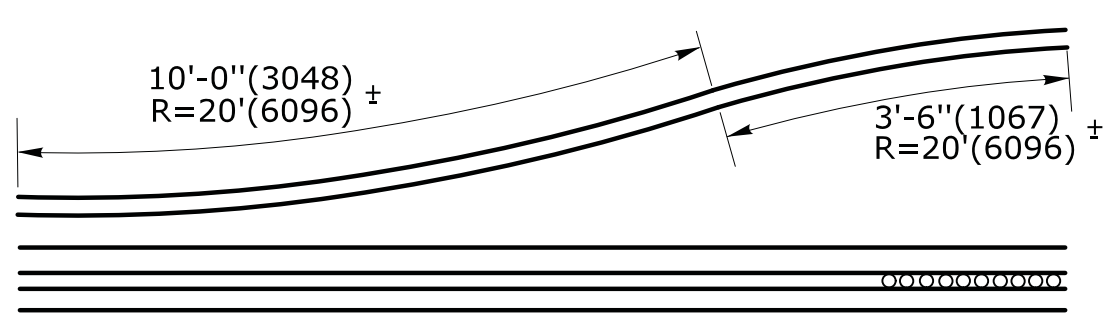




DETAIL D


SHOP CURVED RAIL


SEE NOTE 3

ALL METRIC DIMENSIONS ARE IN MILLIMETERS (mm) UNLESS OTHERWISE NOTED.


1 6/11 REVISED TYPE I AND II ANCHOR FOR CLEAR ZONE PLACEMENT		THE INFORMATION, INCLUDING ESTIMATED QUANTITIES OF WORK, SHOWN ON THESE SHEETS IS BASED ON LIMITED INVESTIGATIONS BY THE STATE AND IS IN NO WAY WARRANTED TO INDICATE THE CONDITIONS OF ACTUAL QUANTITIES OF WORK WHICH WILL BE REQUIRED.	NOT TO SCALE	 STATE OF CONNECTICUT DEPARTMENT OF TRANSPORTATION		SUBMITTED BY: NAME/DATE/TIME:		CTDOT STANDARD SHEET	R-B END ANCHORAGE TYPE I AND II	STANDARD SHEET NO.: HW-911_01
2 7/13 ADD POST OFFSET DISTANCE						APPROVED BY: NAME/DATE/TIME:				
-						-				
-						-				
-						-				
REV.	DATE	REVISION DESCRIPTION	Plotted Date: 6/13/2013	Filename: CTDOT_HIGHWAY_STD2013.dgn	Model: 70 - HW-911_01			OFFICE OF ENGINEERING		

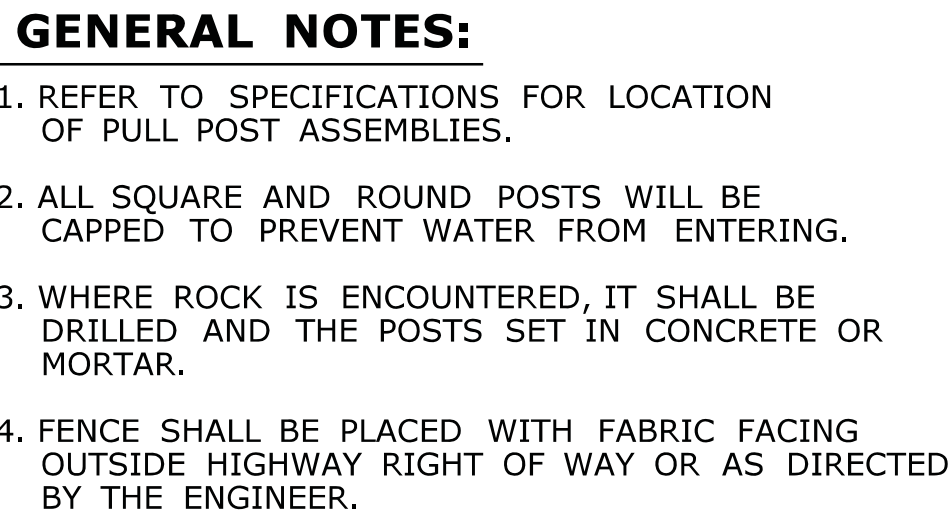


1	6/01/10	REMOVE "H" POST & SQUARE TUBULAR POST DETAILS AND NOTES	<p>THE INFORMATION, INCLUDING ESTIMATED QUANTITIES OF WORK, SHOWN ON THESE SHEETS IS BASED ON LIMITED INVESTIGATIONS BY THE STATE AND IS IN NO WAY WARRANTED TO INDICATE THE CONDITIONS OF ACTUAL QUANTITIES OF WORK WHICH WILL BE REQUIRED.</p>	NOT TO SCALE	 <p>STATE OF CONNECTICUT DEPARTMENT OF TRANSPORTATION</p>	<p>SUBMITTED BY: _____ NAME/DATE/TIME: _____</p> <p>APPROVED BY: _____ NAME/DATE/TIME: _____</p>	<p>CTDOT STANDARD SHEET</p> <p>CHAIN LINK FENCE</p> <p>OFFICE OF ENGINEERING</p>	STANDARD SHEET TITLE:	STANDARD SHEET NO.:
REV.	DATE	REVISION DESCRIPTION	Plotted Date: 6/23/2011		Filename: CTDOT.HIGHWAY.STD_JUNE2011.dgn Model: 65 - HW-913_01				

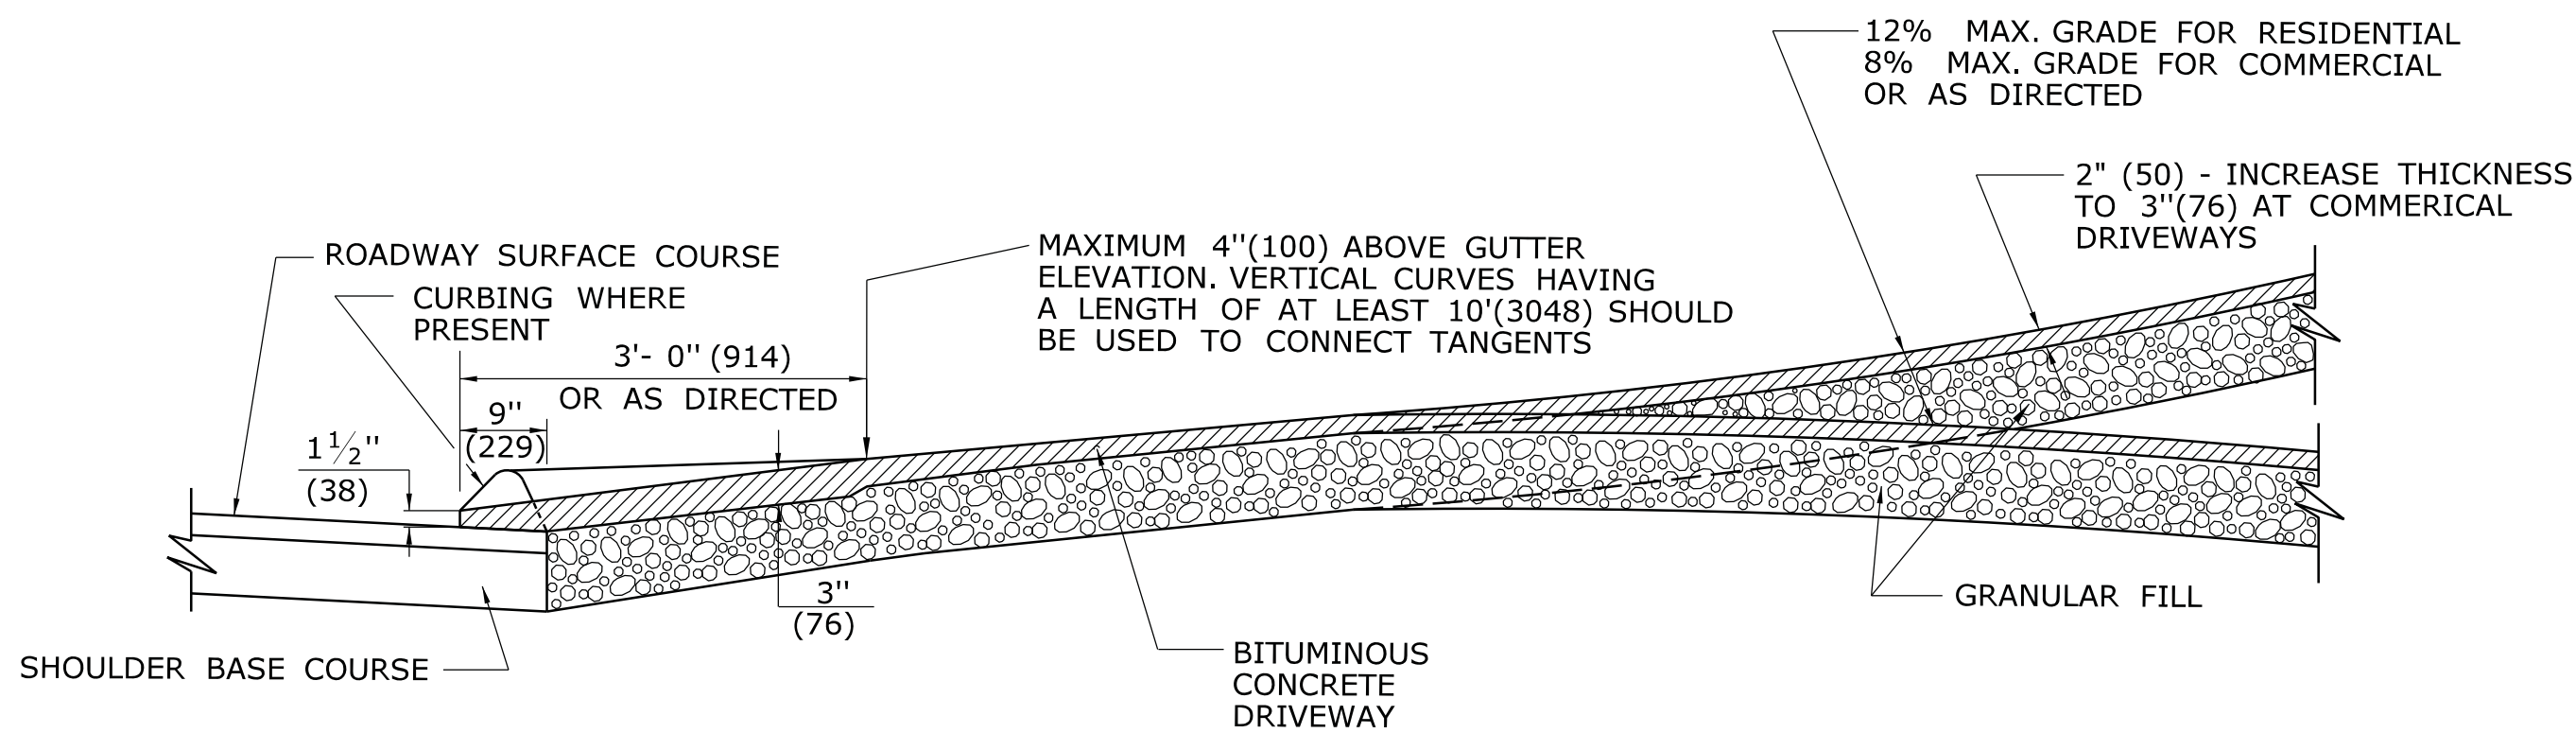


SECTION A

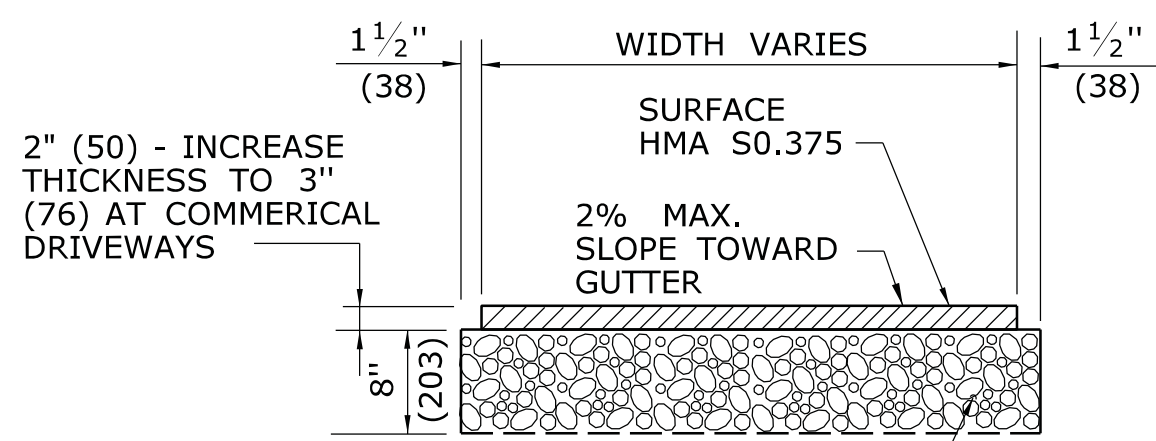


**TYPICAL SECTION
BITUMINOUS CONCRETE
SIDEWALK AND DRIVE**

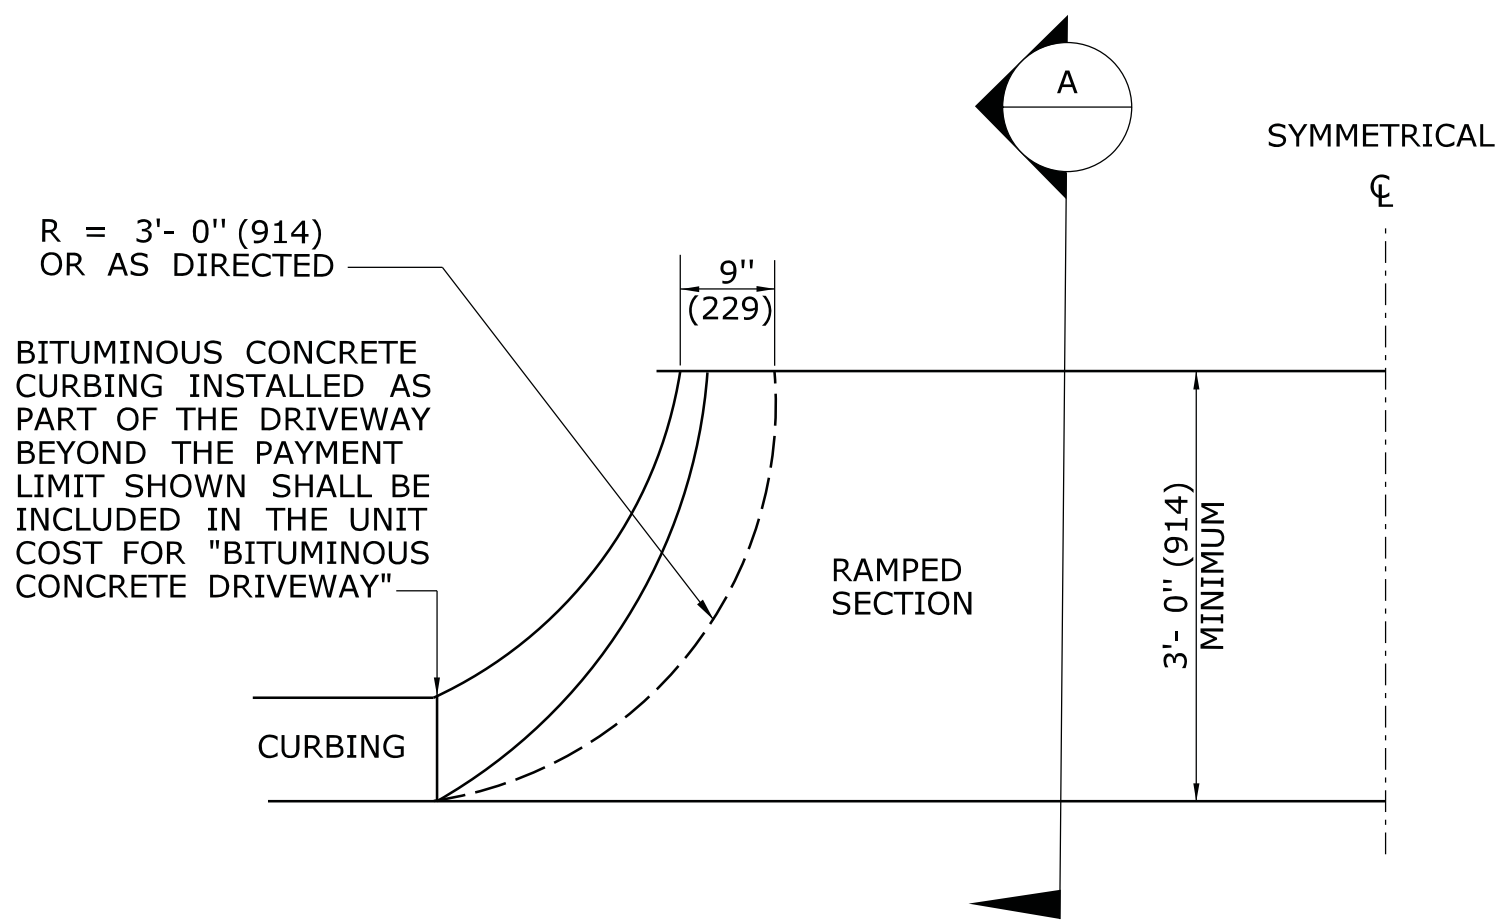


**HALF BITUMINOUS CONCRETE
DRIVEWAY PLAN**

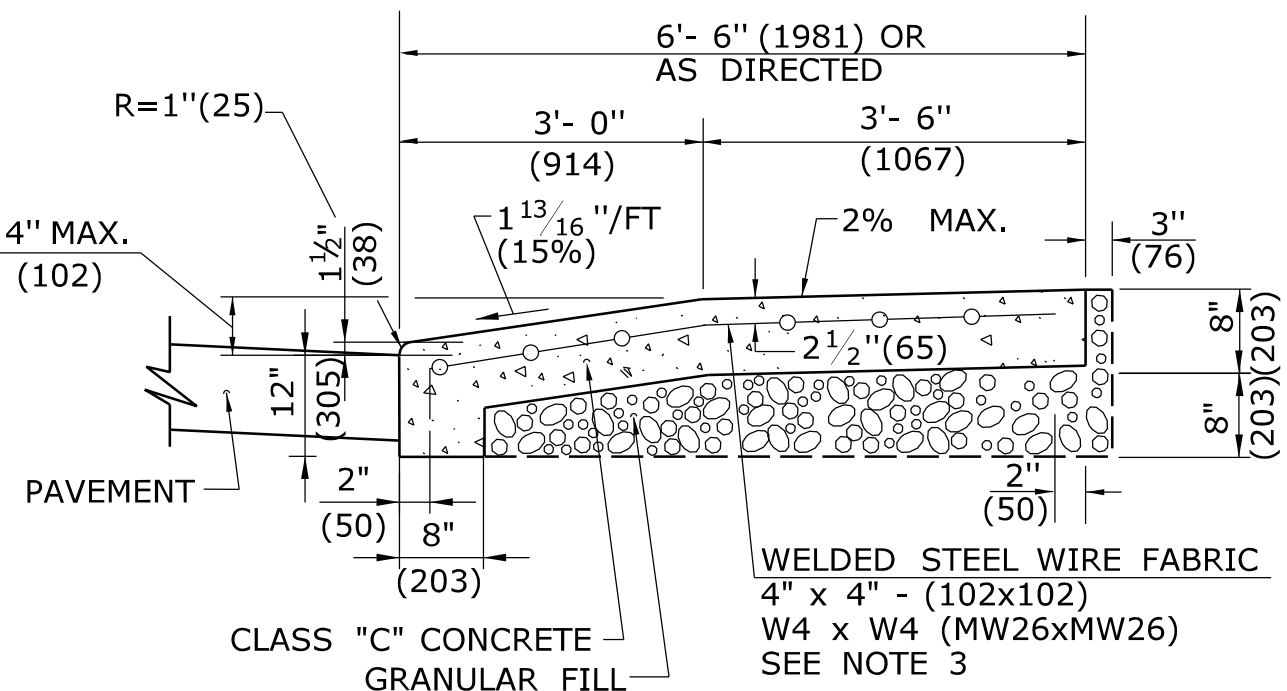


SECTION B

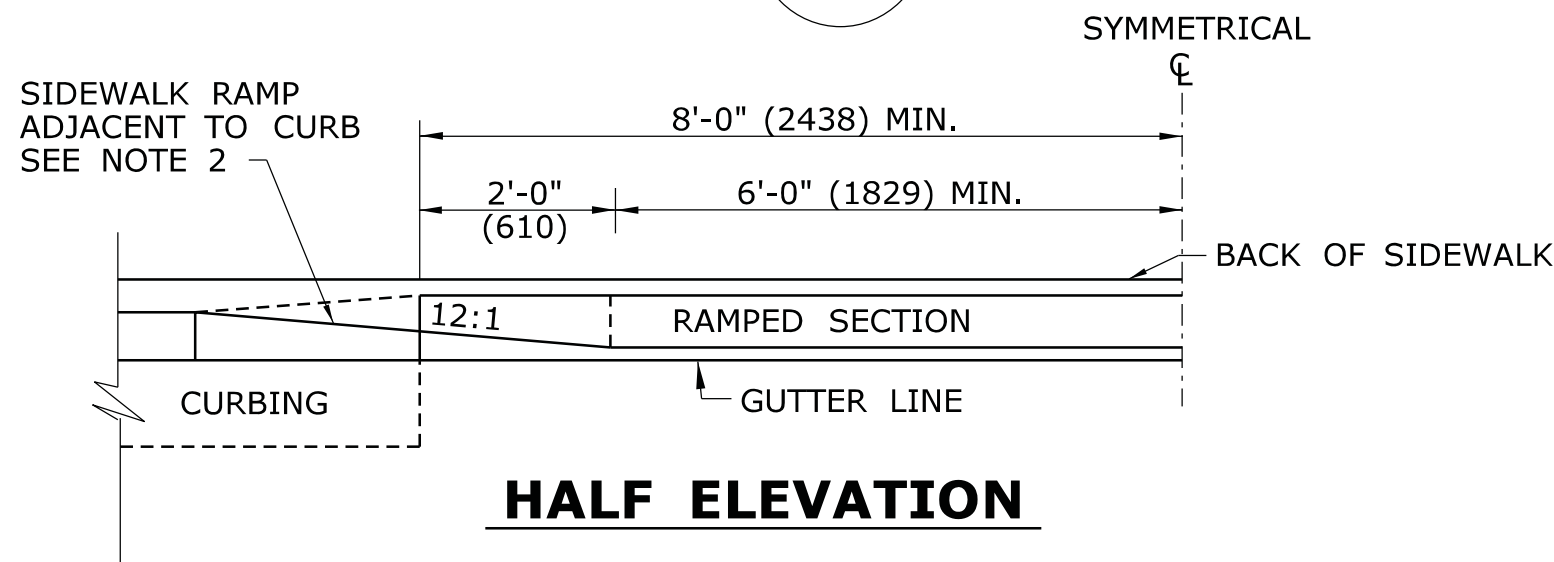


HALF ELEVATION

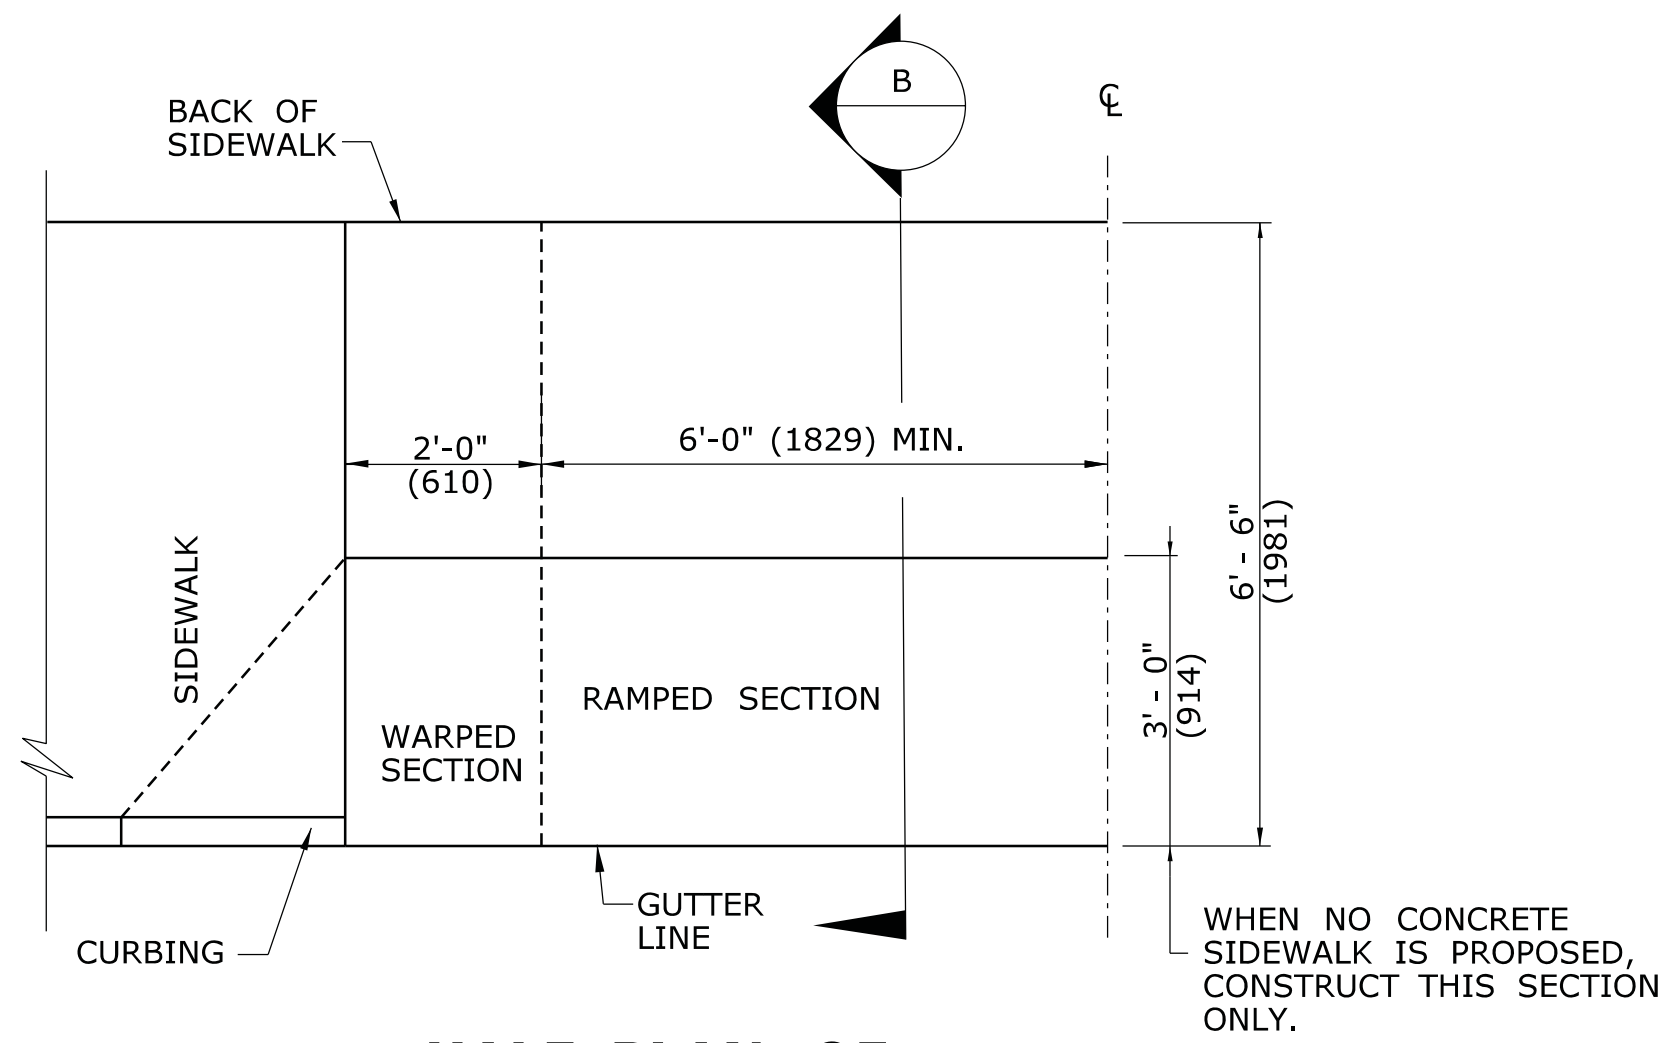


**HALF PLAN OF
CONCRETE DRIVEWAY RAMP WHERE
SIDEWALK ADJOINS CURBING**

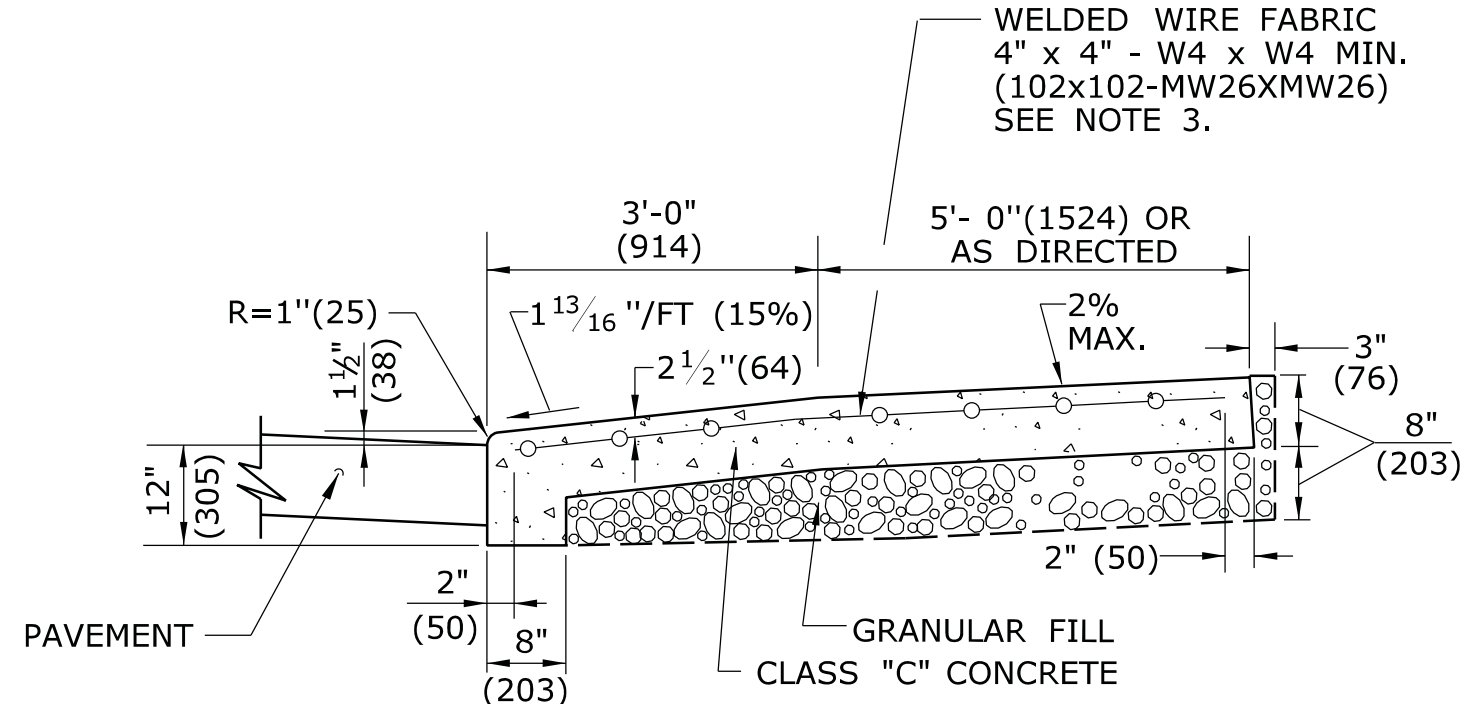

SECTION C

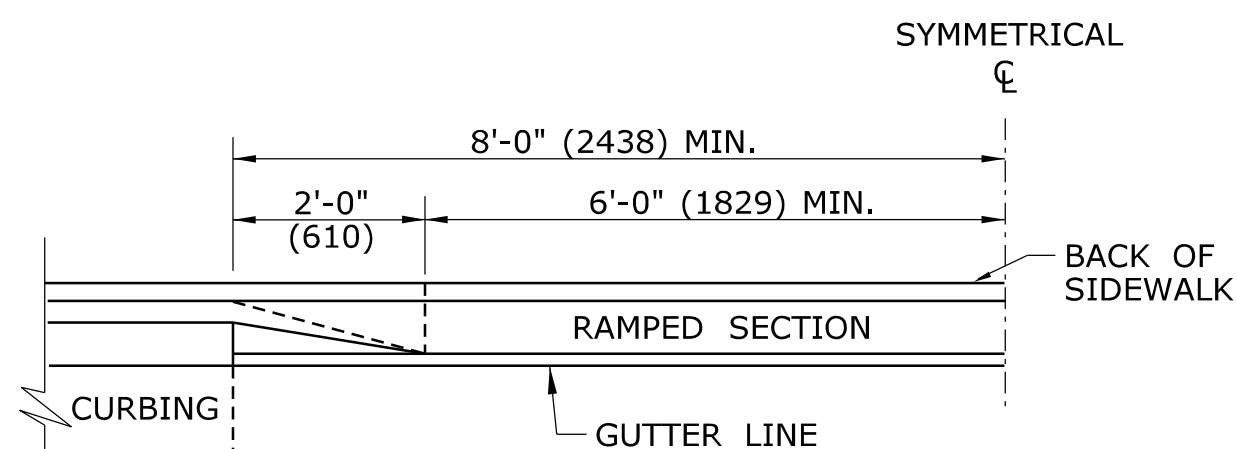


HALF ELEVATION

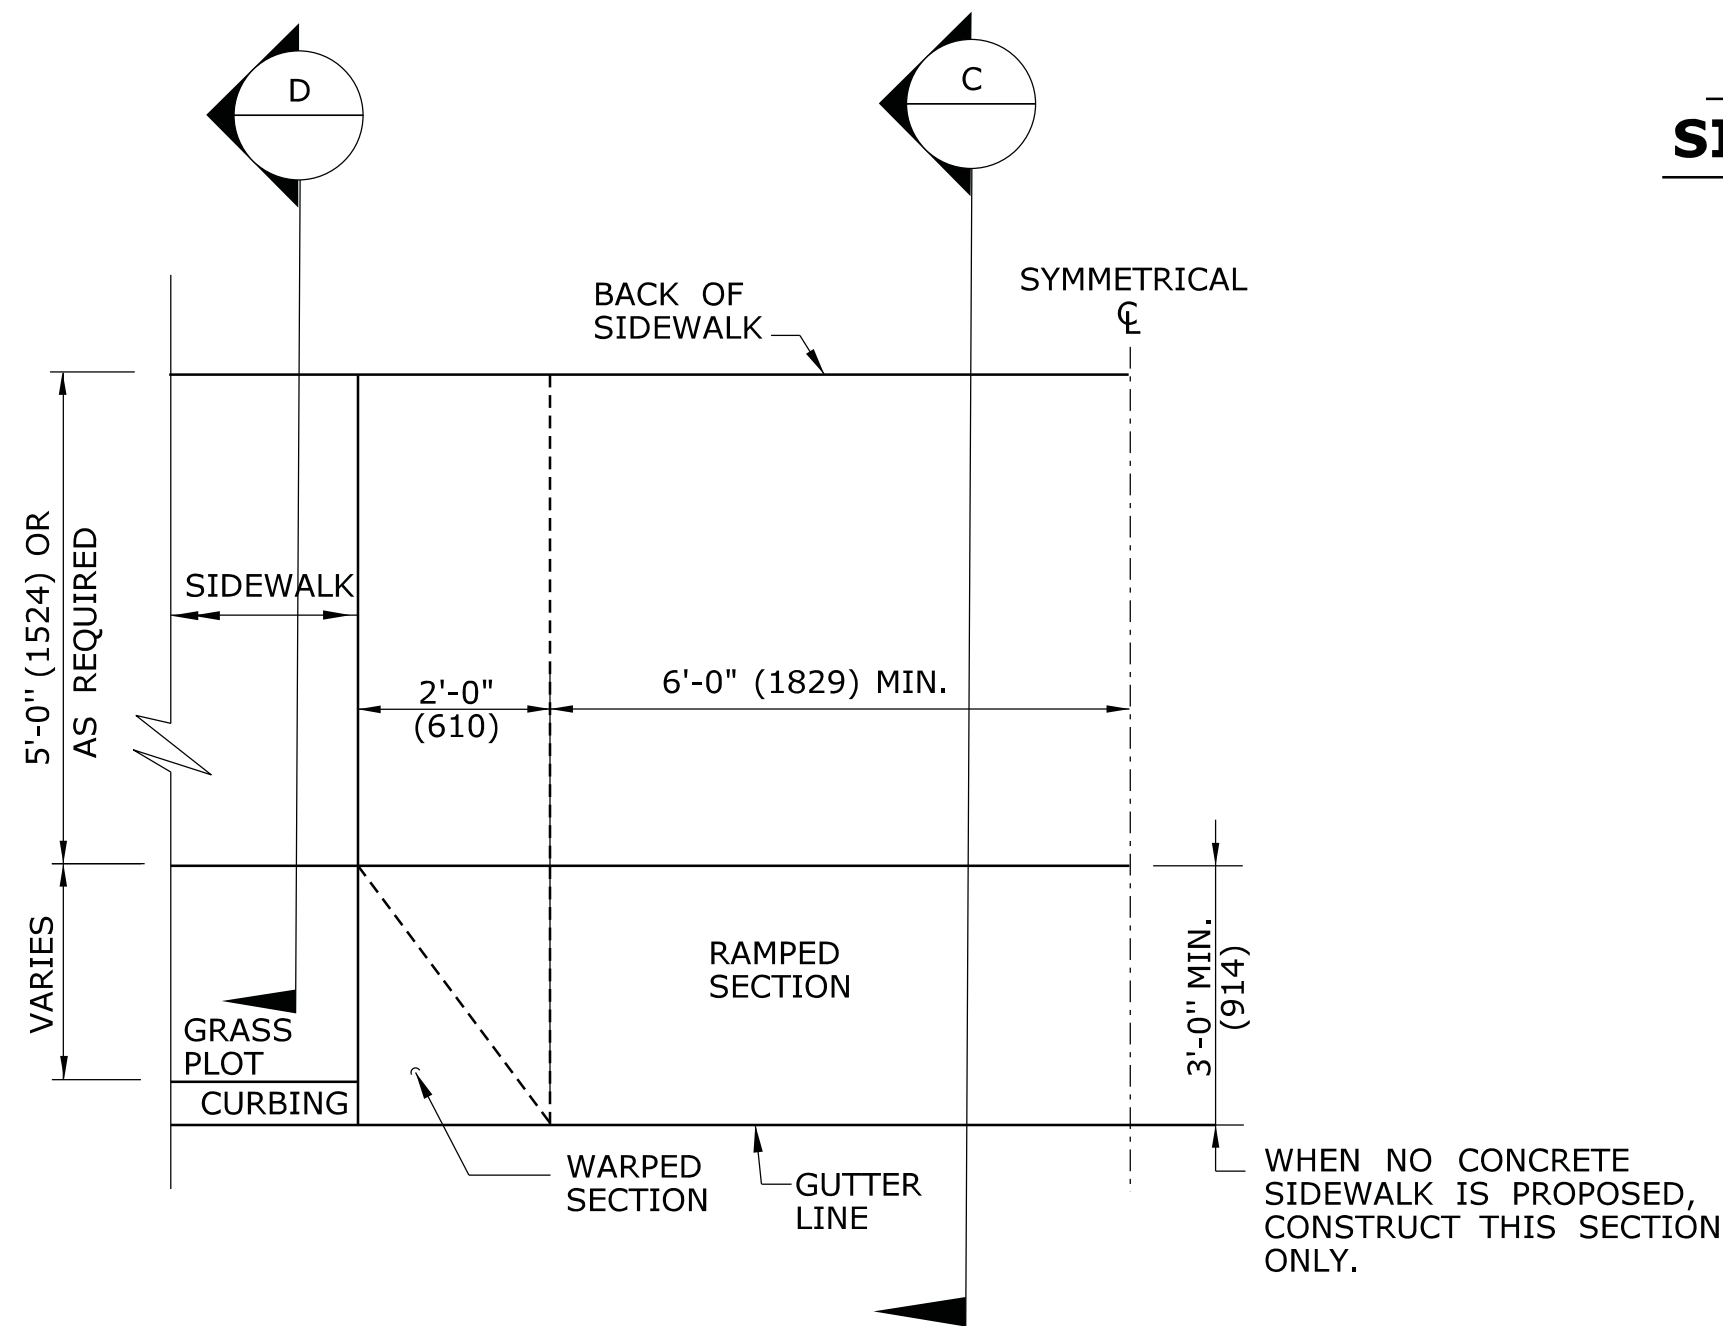

**HALF PLAN OF
CONCRETE DRIVEWAY RAMP WHERE
CURB IS SEPARATED FROM
SIDEWALK BY GRASS PLOT**

GENERAL NOTES:

1. DRIVEWAY ENTRANCE SHALL BE A MINIMUM OF 12' (3658) WIDE, EXCLUDING CURBING WHEN PRESENT.
2. SIDEWALK RAMPS SHALL BE A MINIMUM OF 36" (914) TO 40" (1016) MAXIMUM, WITH A MAXIMUM SLOPE OF 12:1. THERE SHALL BE NO LIP AT THE DRIVEWAY SIDEWALK INTERFACE.
3. WELDED WIRE FABRIC MATS WITH REINFORCING AT CLOSER SPACING MAY BE USED.

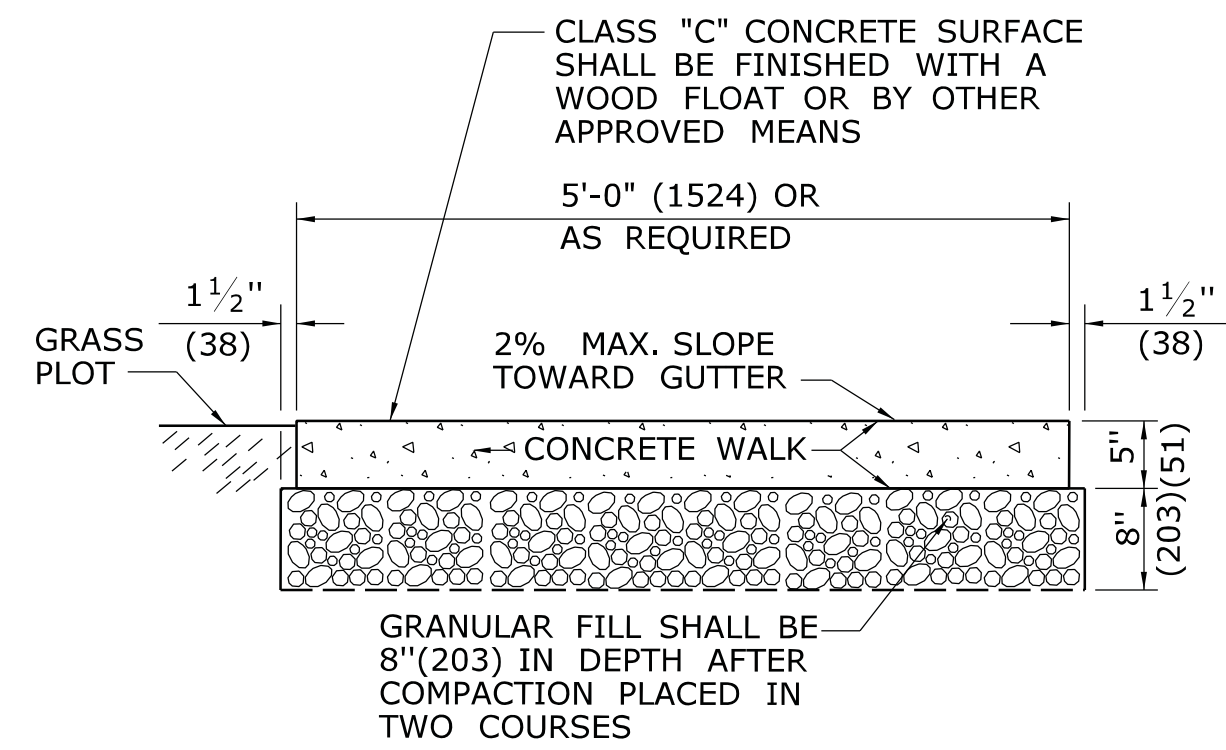

SECTION D

**5' (1524) WIDE CONCRETE
SIDEWALK WITH GRASS PLOT**

ALL METRIC DIMENSIONS ARE IN MILLIMETERS (mm) UNLESS OTHERWISE NOTED

1	6/01/10	REVISED BORDER TITLE	THE INFORMATION, INCLUDING ESTIMATED QUANTITIES OF WORK, SHOWN ON THESE SHEETS IS BASED ON LIMITED INVESTIGATIONS BY THE STATE AND IS IN NO WAY WARRANTED TO INDICATE THE CONDITIONS OF ACTUAL QUANTITIES OF WORK WHICH WILL BE REQUIRED.	NOT TO SCALE	STATE OF CONNECTICUT DEPARTMENT OF TRANSPORTATION	SUBMITTED BY: _____ NAME/DATE/TIME: _____ APPROVED BY: _____ NAME/DATE/TIME: _____	CTDOT STANDARD SHEET OFFICE OF ENGINEERING	STANDARD SHEET TITLE: DRIVEWAY RAMPS AND SIDEWALKS	STANDARD SHEET NO.: HW-921_01
2	6/01/10	REVISED HALF ELEVATION DETAILS							
3	1/12	REVISED 2% MAX. SLOPE NOTE							
-	-	-							
-	-	-							
REV.	DATE	REVISION DESCRIPTION	Plotted Date: 1/9/2012		Filename: Jan2012.dgn	Model: HW-921_01			

GENERAL NOTES:


1. THE PLANTING PIT SIZE SHALL BE TWICE THE DIAMETER OF THE ROOT BALL IN WIDTH AND 2"(51) LESS THAN THE HEIGHT OF THE ROOT BALL.
2. ALL EXTERIOR PACKAGING MATERIAL APPLIED TO PLANTS SHALL BE REMOVED AFTER THE PLANT IS LOCATED IN THE PLANTING PIT. CUT AND REMOVE TWINE, BURLAP OR WIRE BASKETS FROM THE TOP 2/3RDS OF THE ROOT BALL.
3. USE DOUBLE STRAND NO. 12 WIRE FOR DECIDUOUS TREES GREATER THAN OR EQUAL TO 3"(76) CALIPER AND USE DOUBLE STRAND NO. 10 WIRE FOR EVERGREEN TREES GREATER THAN OR EQUAL TO 8"(203) CALIPER.
4. TREE TRUNK WRAPPING MATERIAL SHALL BE USED AS DIRECTED BY THE ENGINEER.
5. PLANTING PITs FOR INDIVIDUAL SHRUBS ON SLOPES SHALL BE THREE TIMES THE DIAMETER OF THE ROOT BALL IN WIDTH.

EXAMPLES OF MINIMUM SIZE OF ROOT BALL FOR NURSERY GROWN PLANTS.

CALIPER* INCHES(mm)	BALL DIAMETER INCHES(mm)	PLANTING PIT SIZE INCHES(mm)
-	8(203)	16(406)
-	10(254)	20(508)
1/2(12.5)	12(304)	24(610)
3/4(19)	14(356)	28(711)
1(25)	16(406)	32(813)
1 1/2(38)	20(508)	40(1016)
2(50)	24(610)	48(1219)
2 1/2(65)	28(711)	56(1422)
3(75)	32(813)	64(1626)
3 1/2(90)	38(965)	76(1930)
4(100)	42(1166)	84(2134)
5(125)	54(1372)	108(2743)
6(150)**	-	-

* THE CALIPER OF THE TRUNK IS MEASURED 6"(152) ABOVE THE GROUND UP TO AND INCLUDING 4"(102) SIZES AND 12"(305) ABOVE THE GROUND FOR LARGER SIZES OR AS SPECIFIED IN THE MOST RECENT EDITION OF THE AMERICAN STANDARD FOR NURSERY STOCK, PUBLISHED BY THE AMERICAN ASSOCIATION OF NURSERYMEN.

** TREES GREATER THAN OR EQUAL TO 6"(152) CALIPER SHALL HAVE A ROOT BALL DIAMETER EQUAL TO 10"(254) PER INCH(25mm) OF TRUNK CALIPER (A 7"(178) CALIPER TREE SHOULD HAVE A ROOT BALL DIAMETER EQUAL TO 70"(1778)).

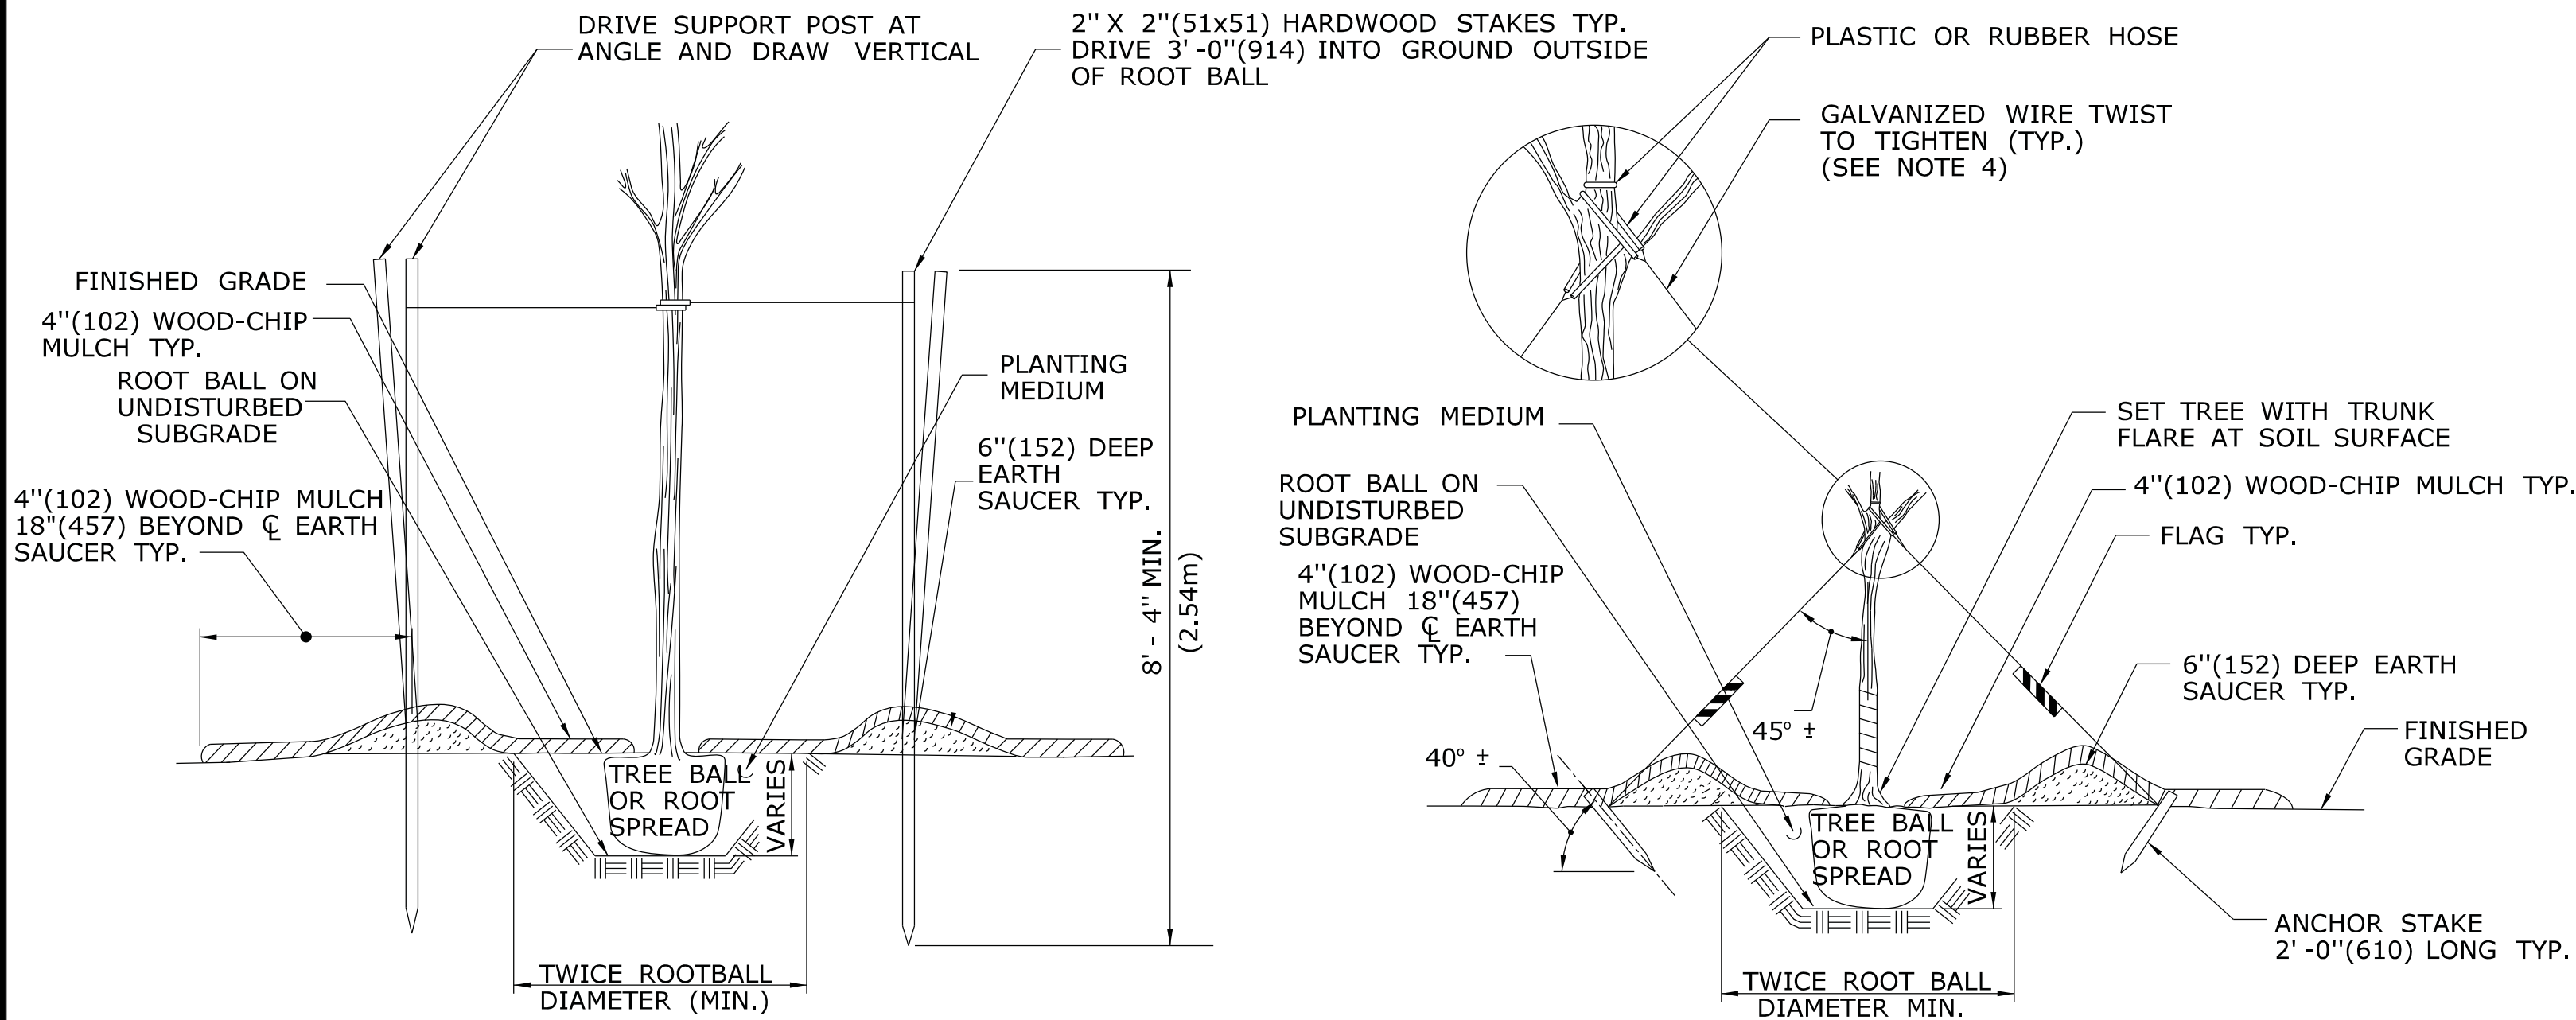


SECTION A

SECTION B

NOTE:

USE 3 POSTS FOR STAKING DECIDUOUS TREES 3"(76) CALIPER OR GREATER AND EVERGREEN TREES 8'(2.4m) HIGH OR GREATER. USE 2 POSTS FOR STAKING DECIDUOUS TREES LESS THAN 3"(76) CALIPER AND EVERGREEN TREES LESS THAN 8'(2.4m) HIGH.


GUYING PLAN

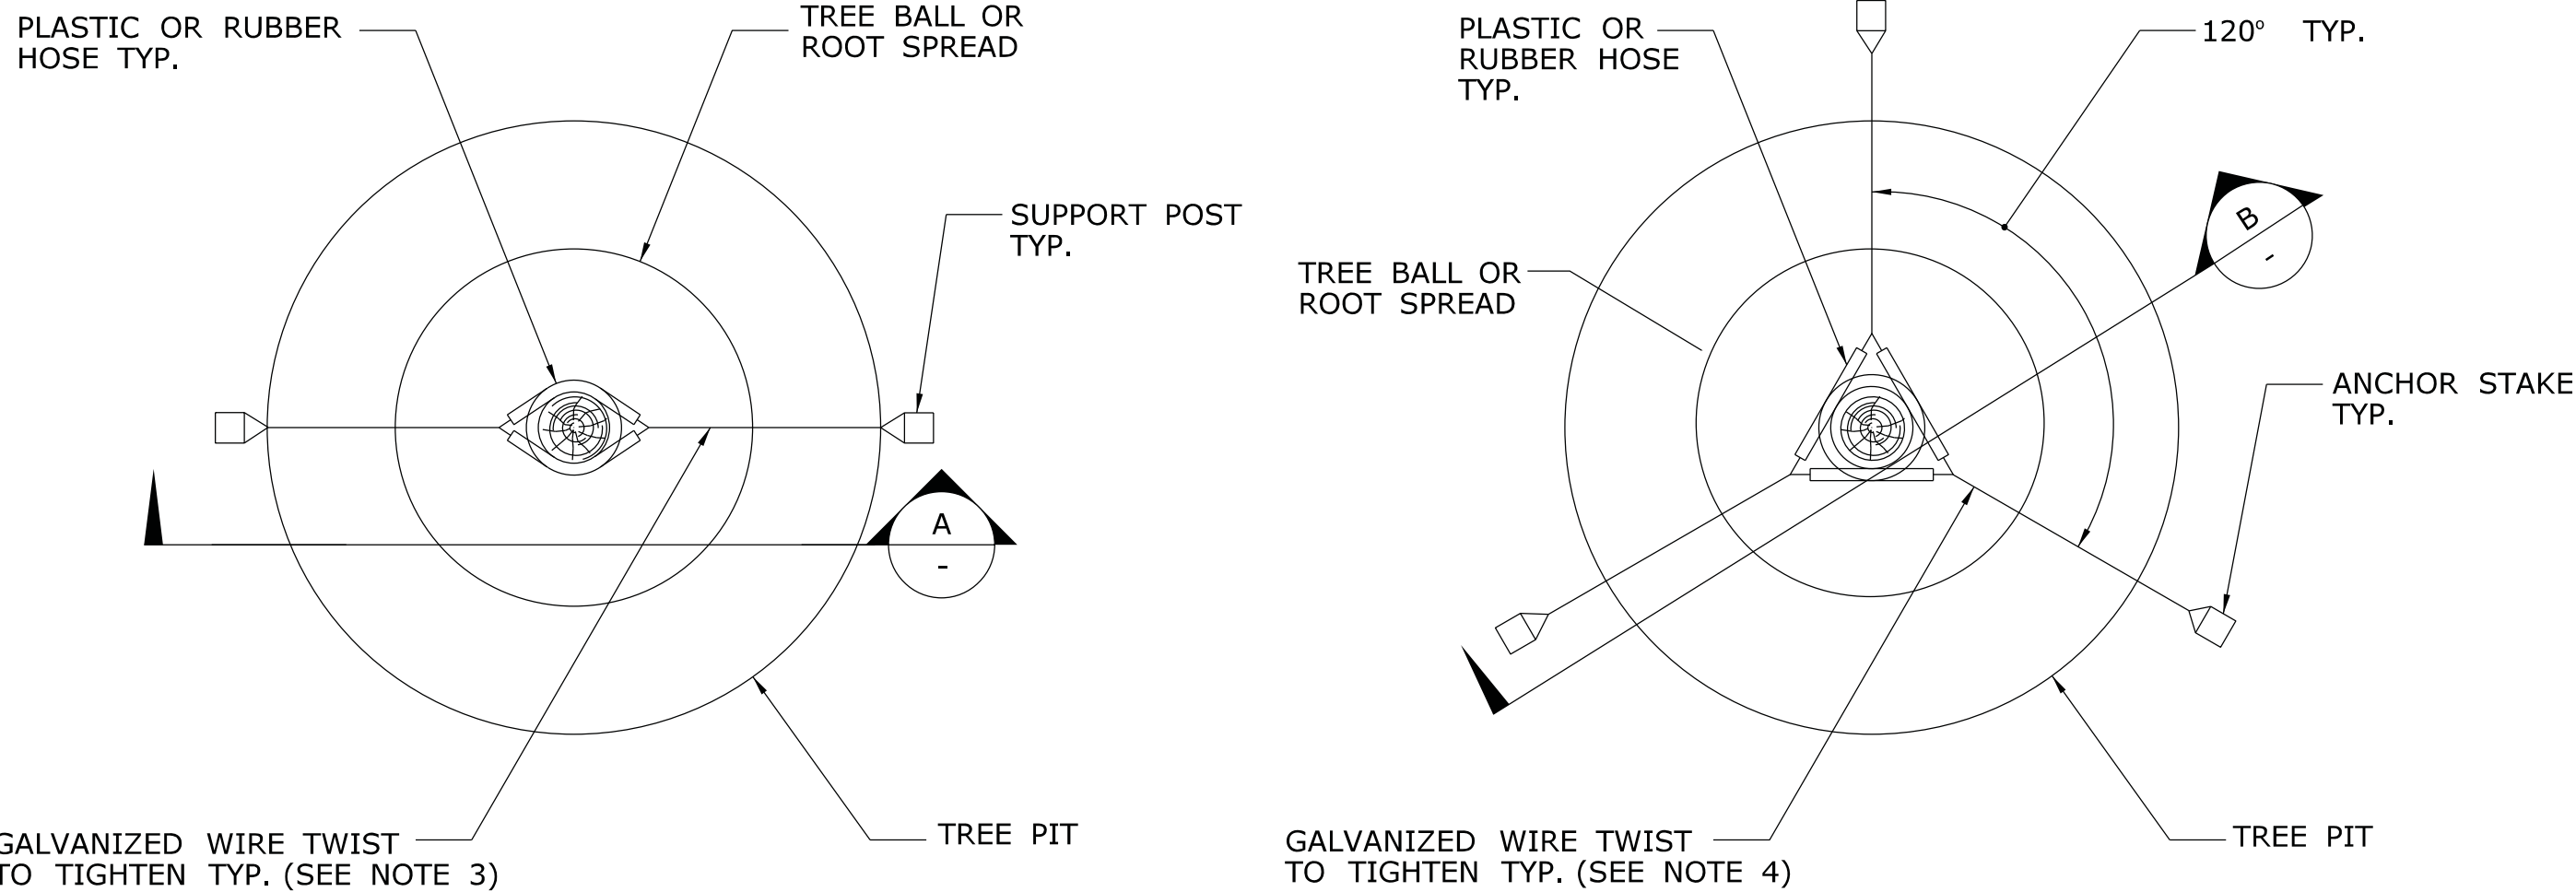


PLAN

PLAN

STAKING PLAN

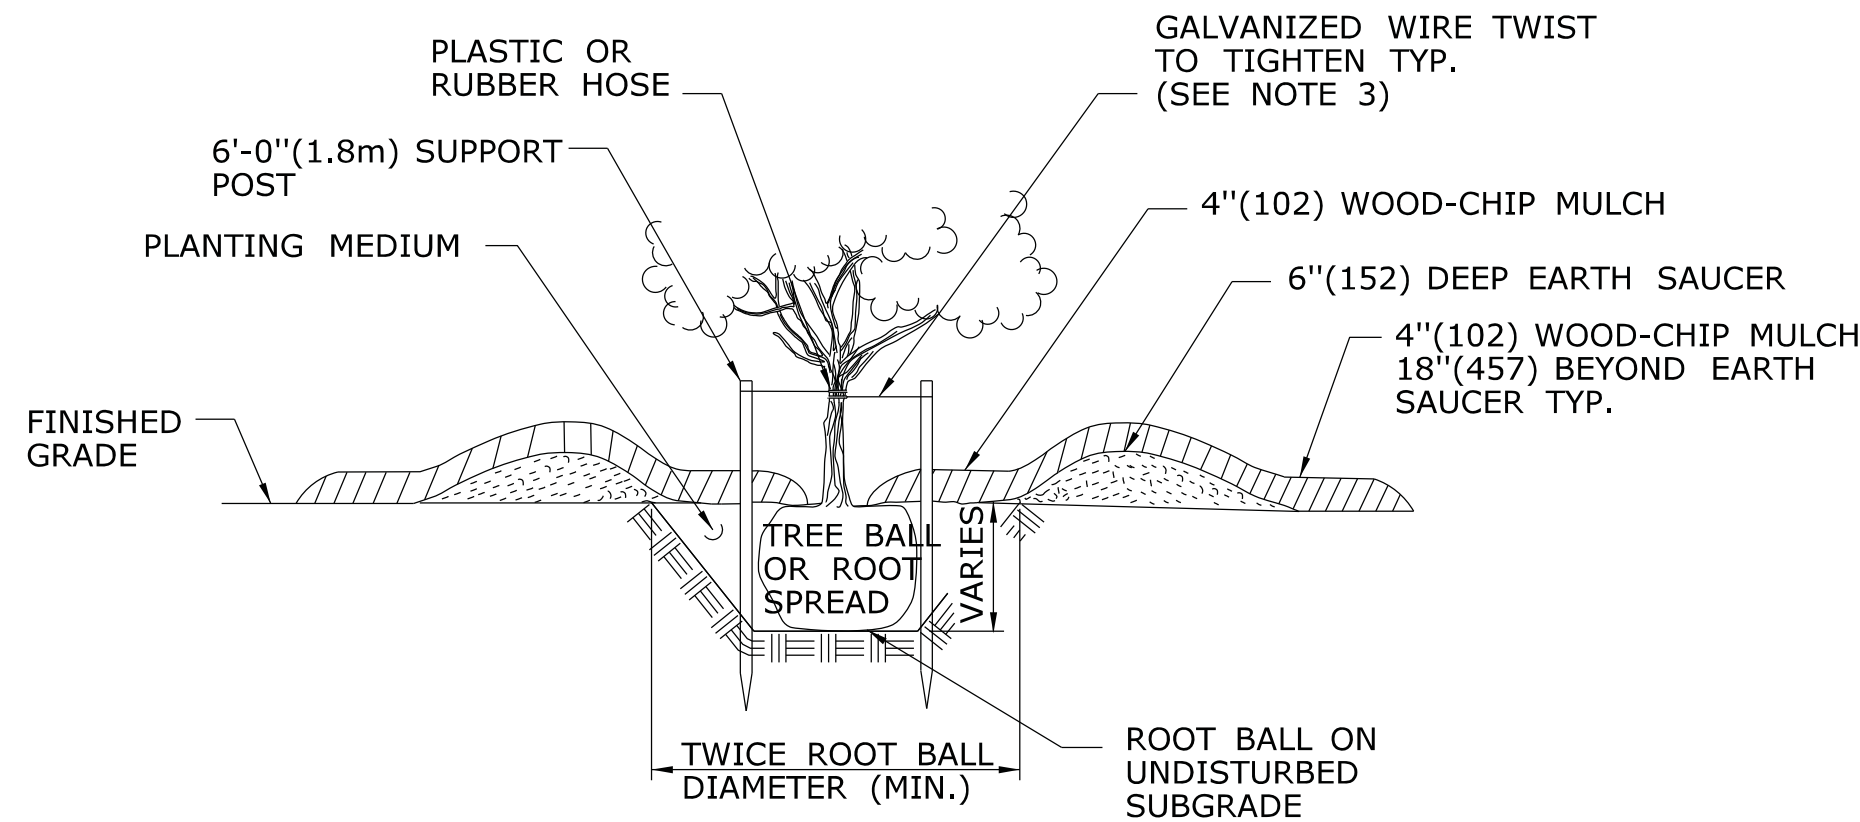


SECTION C

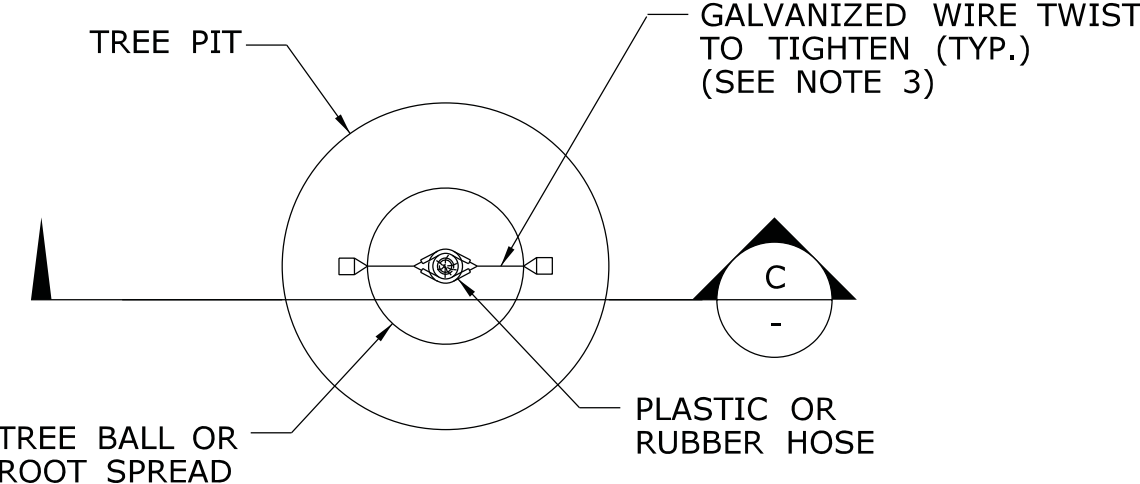

PLAN

STAKING PLAN FOR LOW BRANCHING DECIDUOUS AND EVERGREEN TREES FROM 5'(1.5m) TO 8'(2.4m) HIGH.

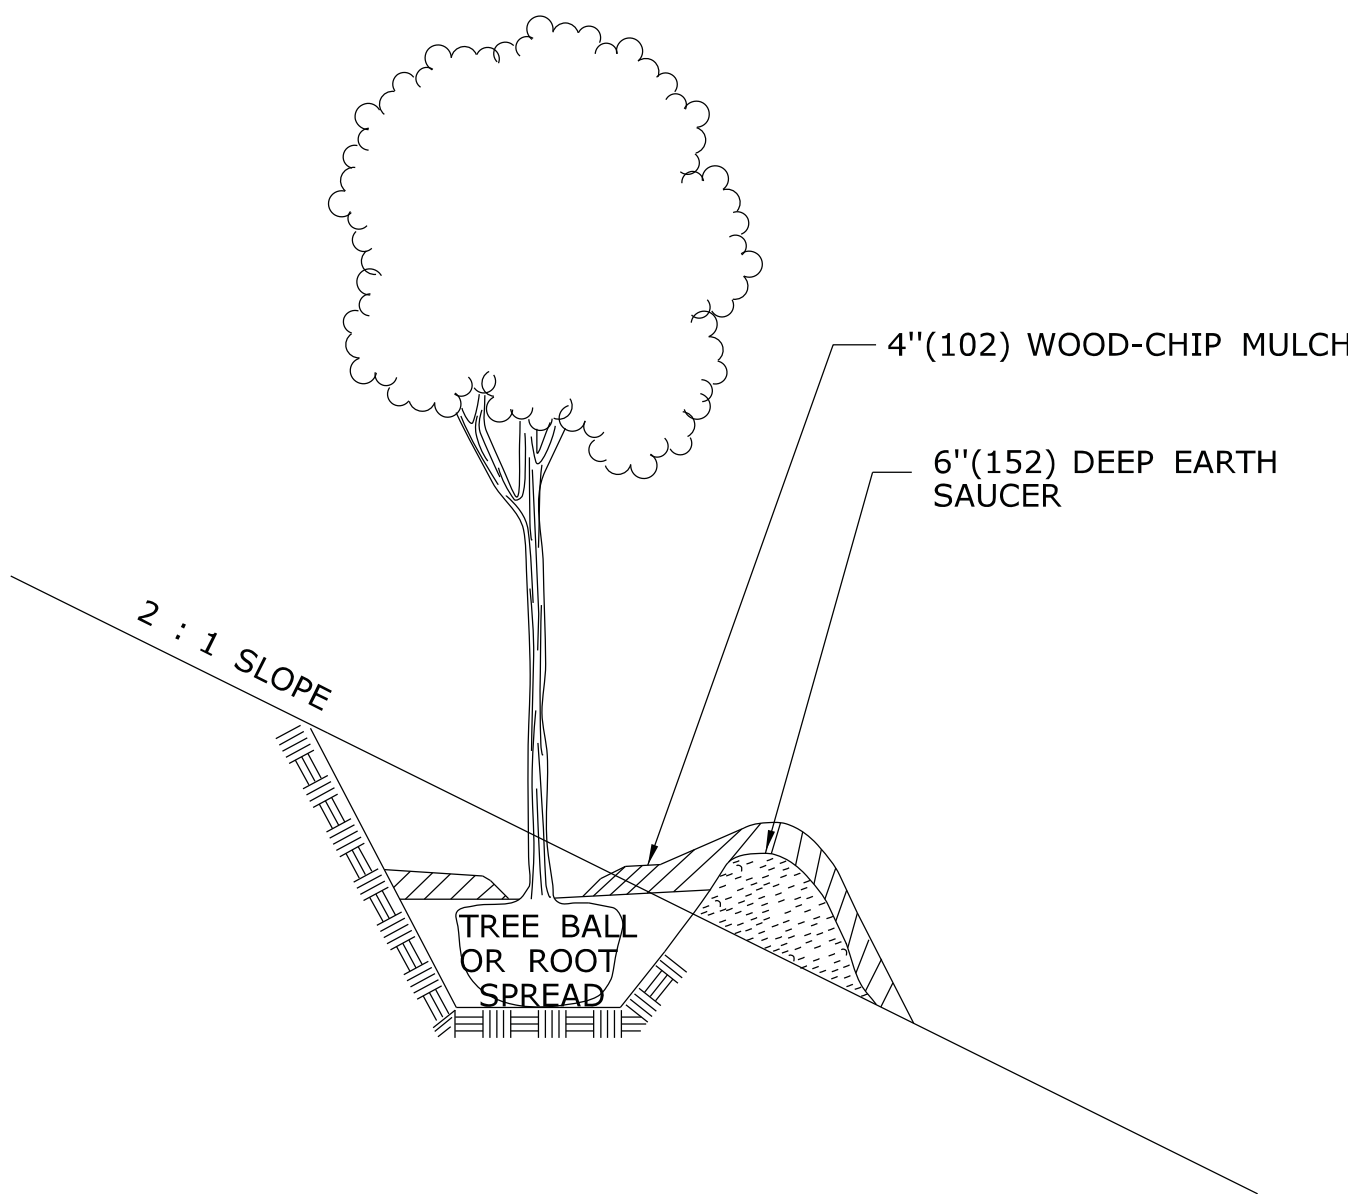

GRADING PLAN FOR TREES ON SLOPES


ALL METRIC DIMENSIONS ARE IN MILLIMETERS (mm) UNLESS OTHERWISE NOTED

THE INFORMATION, INCLUDING ESTIMATED QUANTITIES OF WORK, SHOWN ON THESE SHEETS IS BASED ON LIMITED INVESTIGATIONS BY THE STATE AND IS IN NO WAY WARRANTED TO INDICATE THE CONDITIONS OF ACTUAL QUANTITIES OF WORK WHICH WILL BE REQUIRED.			NOT TO SCALE		STATE OF CONNECTICUT DEPARTMENT OF TRANSPORTATION		SUBMITTED BY: NAME/DATE/TIME: APPROVED BY: NAME/DATE/TIME:		CTDOT STANDARD SHEET OFFICE OF ENGINEERING		STANDARD SHEET TITLE: PLANTING DETAILS FOR TREES	STANDARD SHEET NO.: HW-949_01
REV.	DATE	REVISION DESCRIPTION	Plotted Date: 6/23/2011		Filename: CTDOT_HIGHWAY STD_JUNE2011.dgn Model: 71 - HW-949_01							

FRONT AND REAR CASTER / JACK ASSEMBLY NOTES:

1. JACK SHALL BE SIDEWIND TYPE HAVING A LIFTING CAPACITY OF 1000LBS AND THROW DISTANCE OF 18" (457)
2. SWIVEL CASTER SHALL BE STEEL
3. THE LOCATION OF THE JACK MOUNT IN RELATION TO THE GROUND SHALL BE DETERMINED BY THE JACK SIZE AND MANUFACTURER'S SPECIFICATIONS.

Diagram of a rectangular plate with dimensions 8" (203) by 12" (305). The plate has a central vertical slot. The top edge is labeled "TOP" and the bottom edge is labeled "VARIABLE".

[illegible]

FRONT

SIDE VIEW



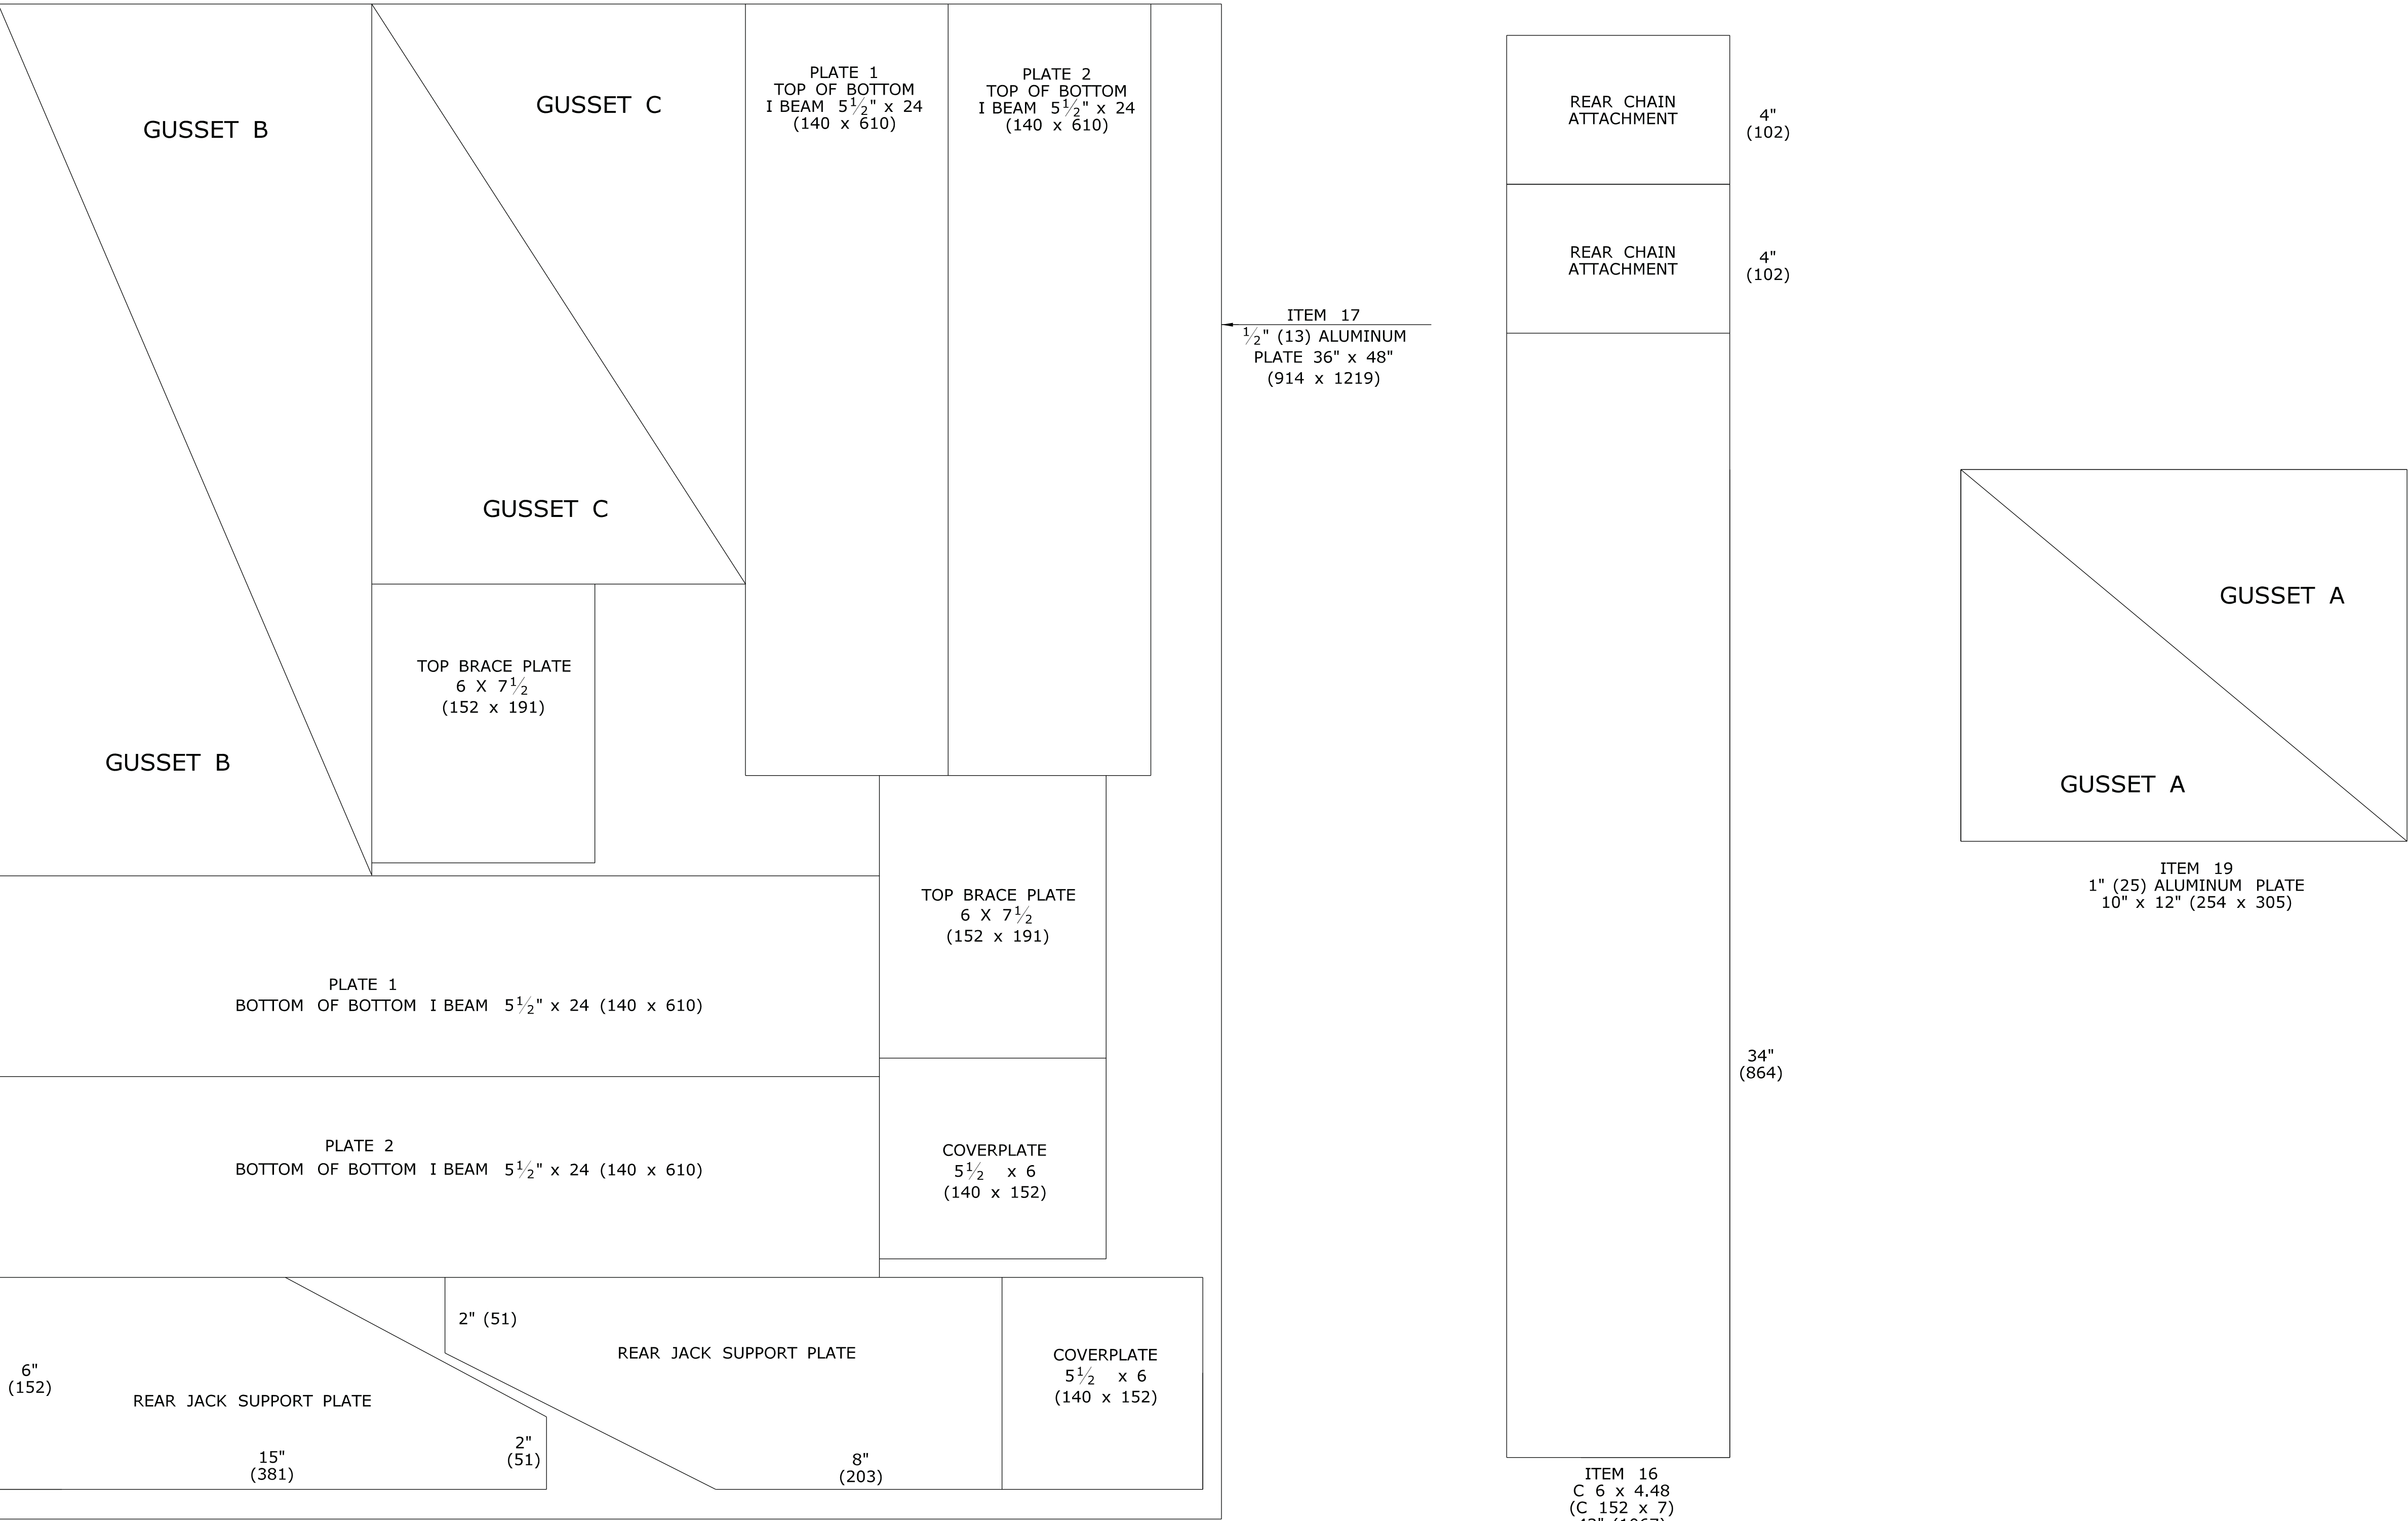


PLATE E

CASTER DETAIL


ALL METRIC DIMENSIONS ARE IN MILLIMETERS (mm) UNLESS OTHERWISE NOTED.

-	-	-	-	THE INFORMATION, INCLUDING ESTIMATED QUANTITIES OF WORK, SHOWN ON THESE SHEETS IS BASED ON LIMITED INVESTIGATIONS BY THE STATE AND IS IN NO WAY WARRANTED TO INDICATE THE CONDITIONS OF ACTUAL QUANTITIES OF WORK WHICH WILL BE REQUIRED.	NOT TO SCALE	 STATE OF CONNECTICUT DEPARTMENT OF TRANSPORTATION	SUBMITTED BY: _____ NAME/DATE/TIME: _____ APPROVED BY: _____ NAME/DATE/TIME: _____ <div style="border: 1px solid black; height: 40px; width: 100%;"></div>	CTDOT STANDARD SHEET OFFICE OF ENGINEERING	STANDARD SHEET TITLE: CT TRUCK MOUNTED IMPACT ATTENUATOR SHEET 2	STANDARD SHEET NO.: HW-1806_01b
-	-	-	-							
-	-	-	-							
-	-	-	-							
-	-	-	-							
-	-	-	-							
REV	DATE	REVISION	DESCRIPTION	Plotted Date: 9/30/2010		Filename: CTDOT_HIGHWAY STD.dgn Model: 76 - HW-1806_01b				

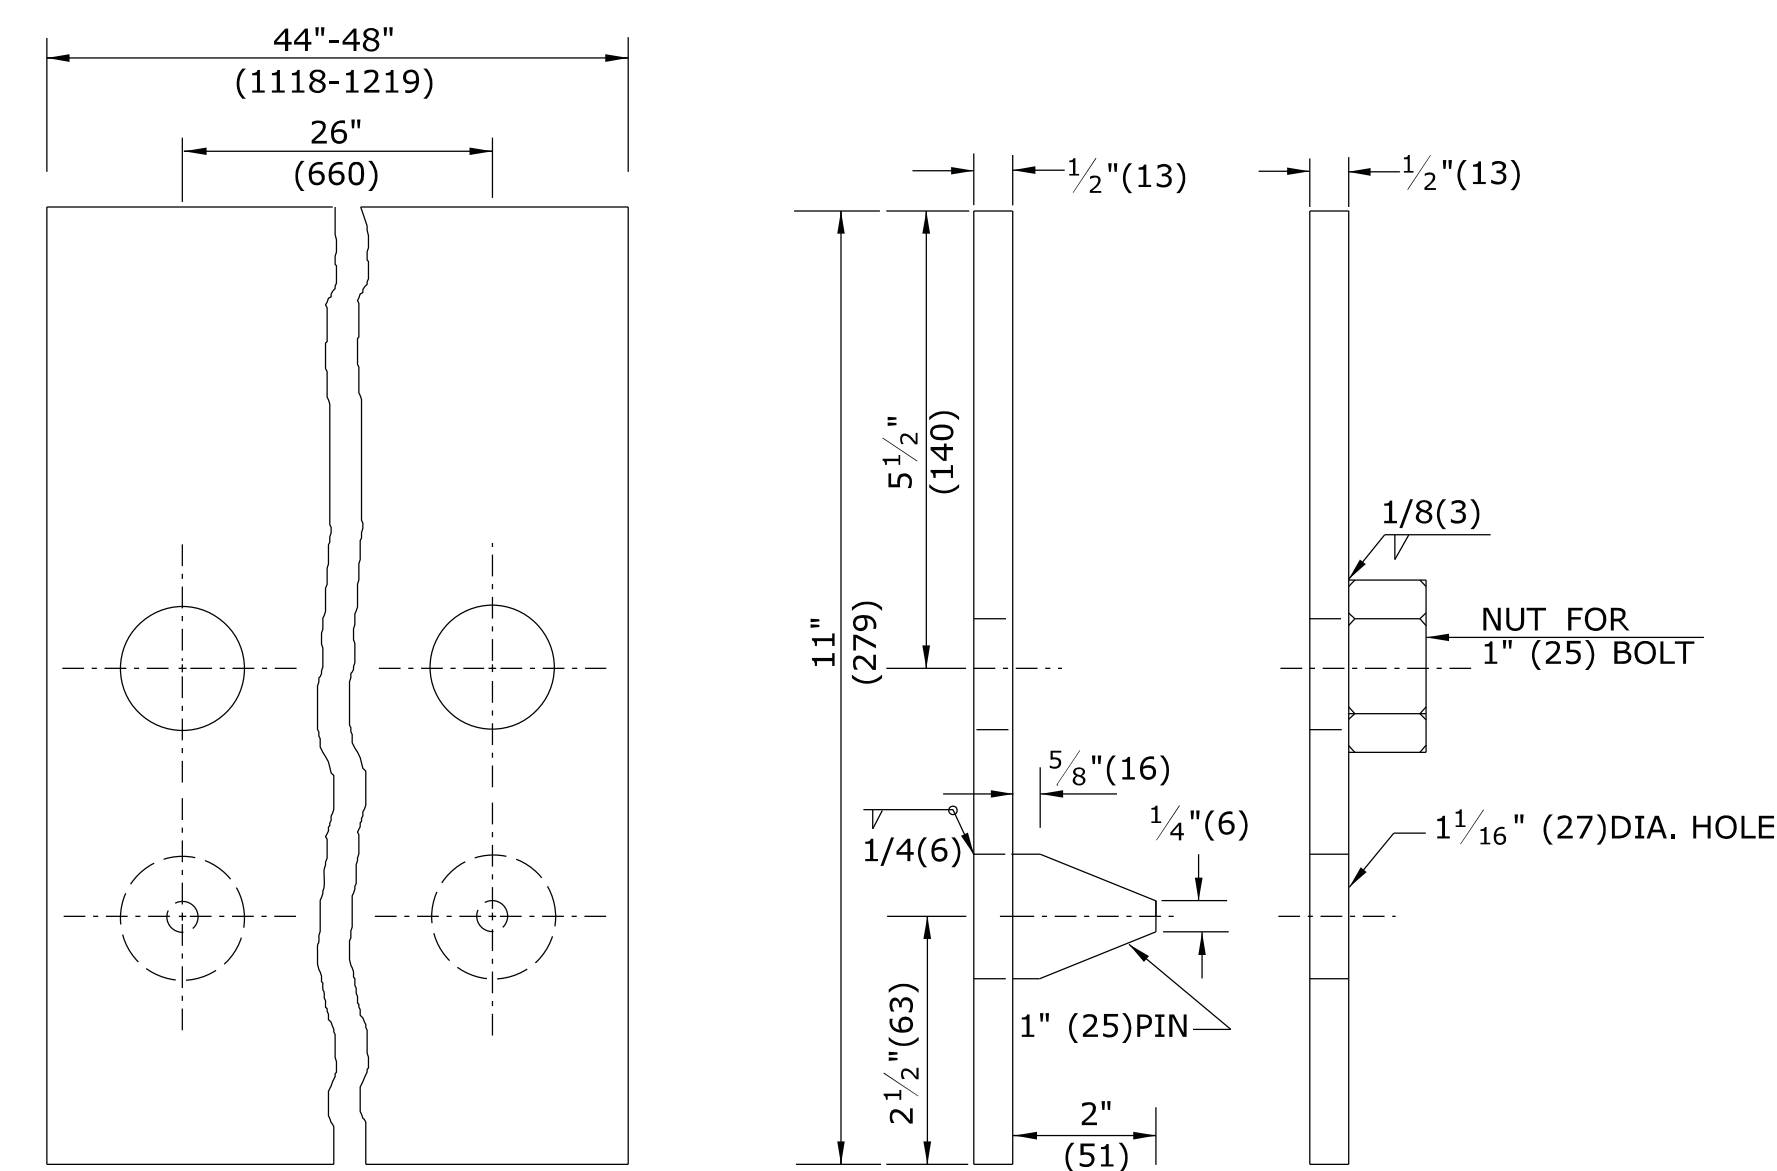

CUTTING PATTERN


ALL METRIC DIMENSIONS ARE IN MILLIMETERS (mm) UNLESS OTHERWISE NOTED.



-	-	-	THE INFORMATION, INCLUDING ESTIMATED QUANTITIES OF WORK, SHOWN ON THESE SHEETS IS BASED ON LIMITED INVESTIGATIONS BY THE STATE AND IS IN NO WAY WARRANTED TO INDICATE THE CONDITIONS OF ACTUAL QUANTITIES OF WORK WHICH WILL BE REQUIRED.	NOT TO SCALE	 STATE OF CONNECTICUT DEPARTMENT OF TRANSPORTATION	SUBMITTED BY: _____ NAME/DATE/TIME: _____ APPROVED BY: _____ NAME/DATE/TIME: _____	CTDOT STANDARD SHEET OFFICE OF ENGINEERING	STANDARD SHEET TITLE: CT TRUCK MOUNTED IMPACT ATTENUATOR SHEET 3	STANDARD SHEET NO.: HW-1806_01c
-	-	-							
-	-	-							
-	-	-							
-	-	-							
REV. DATE	REVISION DESCRIPTION		Plotted Date: 9/30/2010	Filename: CTDOT-HIGHWAY-STD.dgn Model: 77 - HW-1806_01c					


ONLY STANDARD SHEETS MARKED WITH AN "✓" ARE IN THIS PROJECT #

[illegible][illegible]

STANDARD SHEETS SHALL BE USED WITH STANDARD SPECIFICATIONS

			THE INFORMATION, INCLUDING ESTIMATED QUANTITIES OF WORK, SHOWN ON THESE SHEETS IS BASED ON LIMITED INVESTIGATIONS BY THE STATE AND IS IN NO WAY WARRANTED TO INDICATE THE CONDITIONS OF ACTUAL QUANTITIES OF WORK WHICH WILL BE REQUIRED.	NOT TO SCALE	<div><p>STATE OF CONNECTICUT DEPARTMENT OF TRANSPORTATION</p></div>	SUBMITTED BY: _____	NAME/DATE/TIME: _____	CTDOT STANDARD SHEET	TRAFFIC STANDARD SHEET INDEX	STANDARD SHEET TITLE: _____	STANDARD SHEET NO.: _____		
3	4-2014	REMOVED TR-1111_02.											
2	1-2014	REMOVED TR-1103_01.											
1	4-2012	RENUMBERED TR-1107_02 TO TR-1114_01. REMOVED TR-1116_01.											
REV.	DATE	REVISION DESCRIPTION	Plotted Date: 4/11/2014			Filename: CTDOT_TRAFFIC_STD.DGN	Model: TR-01-STD_INDEX	OFFICE OF ENGINEERING					


			THE INFORMATION, INCLUDING ESTIMATED QUANTITIES OF WORK SHOWN ON THESE SHEETS IS BASED ON LIMITED INVESTIGATIONS BY THE STATE AND IS IN NO WAY WARRANTED TO INDICATE THE CONDITIONS OF ACTUAL QUANTITIES OF WORK WHICH WILL BE REQUIRED.		DIMENSIONS ARE IN ENGLISH ("') & METRIC UNITS (mm). METRIC DIMENSIONS ARE ROUNDED: - OVER 1" TO NEAREST 5 mm - UNDER 1" TO NEAREST 1 mm.		 STATE OF CONNECTICUT DEPARTMENT OF TRANSPORTATION 		SUBMITTED BY: _____ NAME/DATE/TIME: _____ APPROVED BY: _____ NAME/DATE/TIME: _____		CTDOT STANDARD SHEET OFFICE OF ENGINEERING		STANDARD SHEET TITLE: TRENCHING & BACKFILLING, ELECTRICAL CONDUIT		STANDARD SHEET NO.: TR-1001_01	
1	4-2012	REVISED BITUMINOUS CONCRTE TO HMA, & MINOR REVISIONS.			NOT TO SCALE		Filename: CTDOT_TRAFFIC_STD.dgn Model: TR-1001_01									
REV.	DATE	REVISION DESCRIPTION	Plotted Date: 4/14/2012													

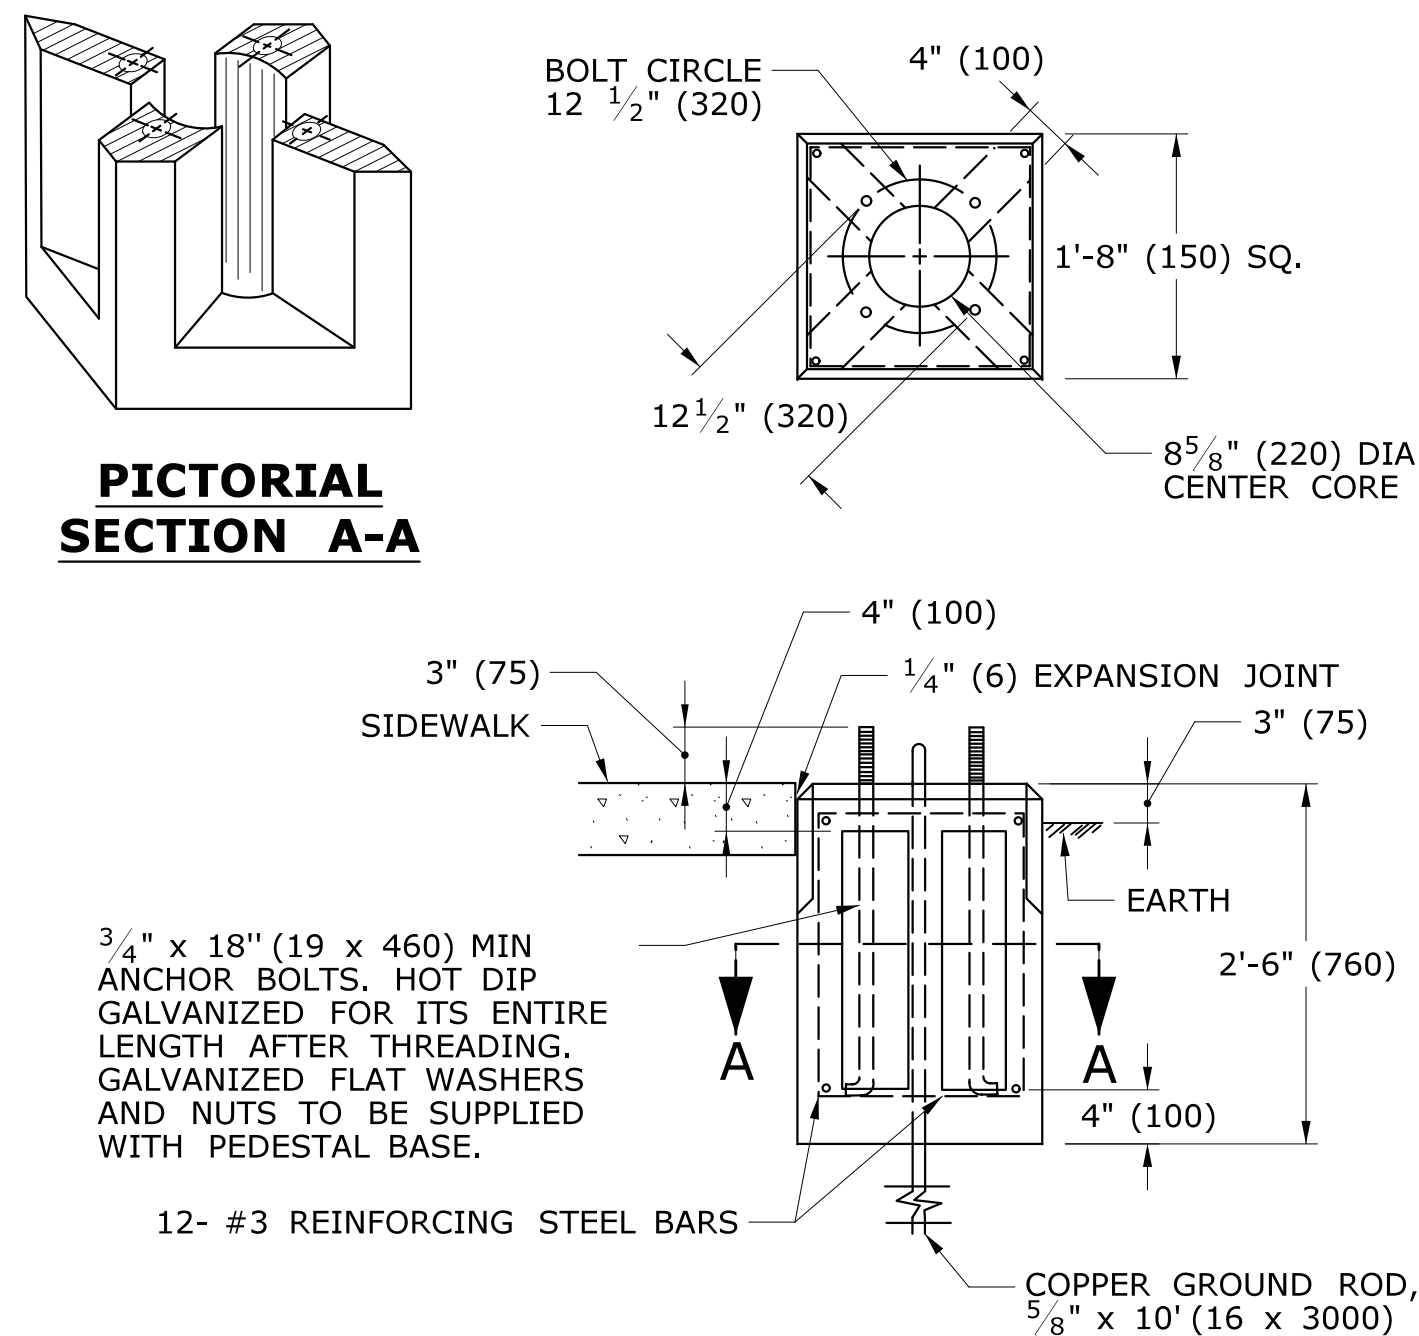


**TRAFFIC CONTROL FOUNDATION
PEDESTAL - TYPE I - PRECAST**

NOTES:

PLACE NO. 6 CRUSHED STONE IN CENTER OPENING AFTER
CONDUITS AND GROUND ROD HAVE BEEN INSTALLED.

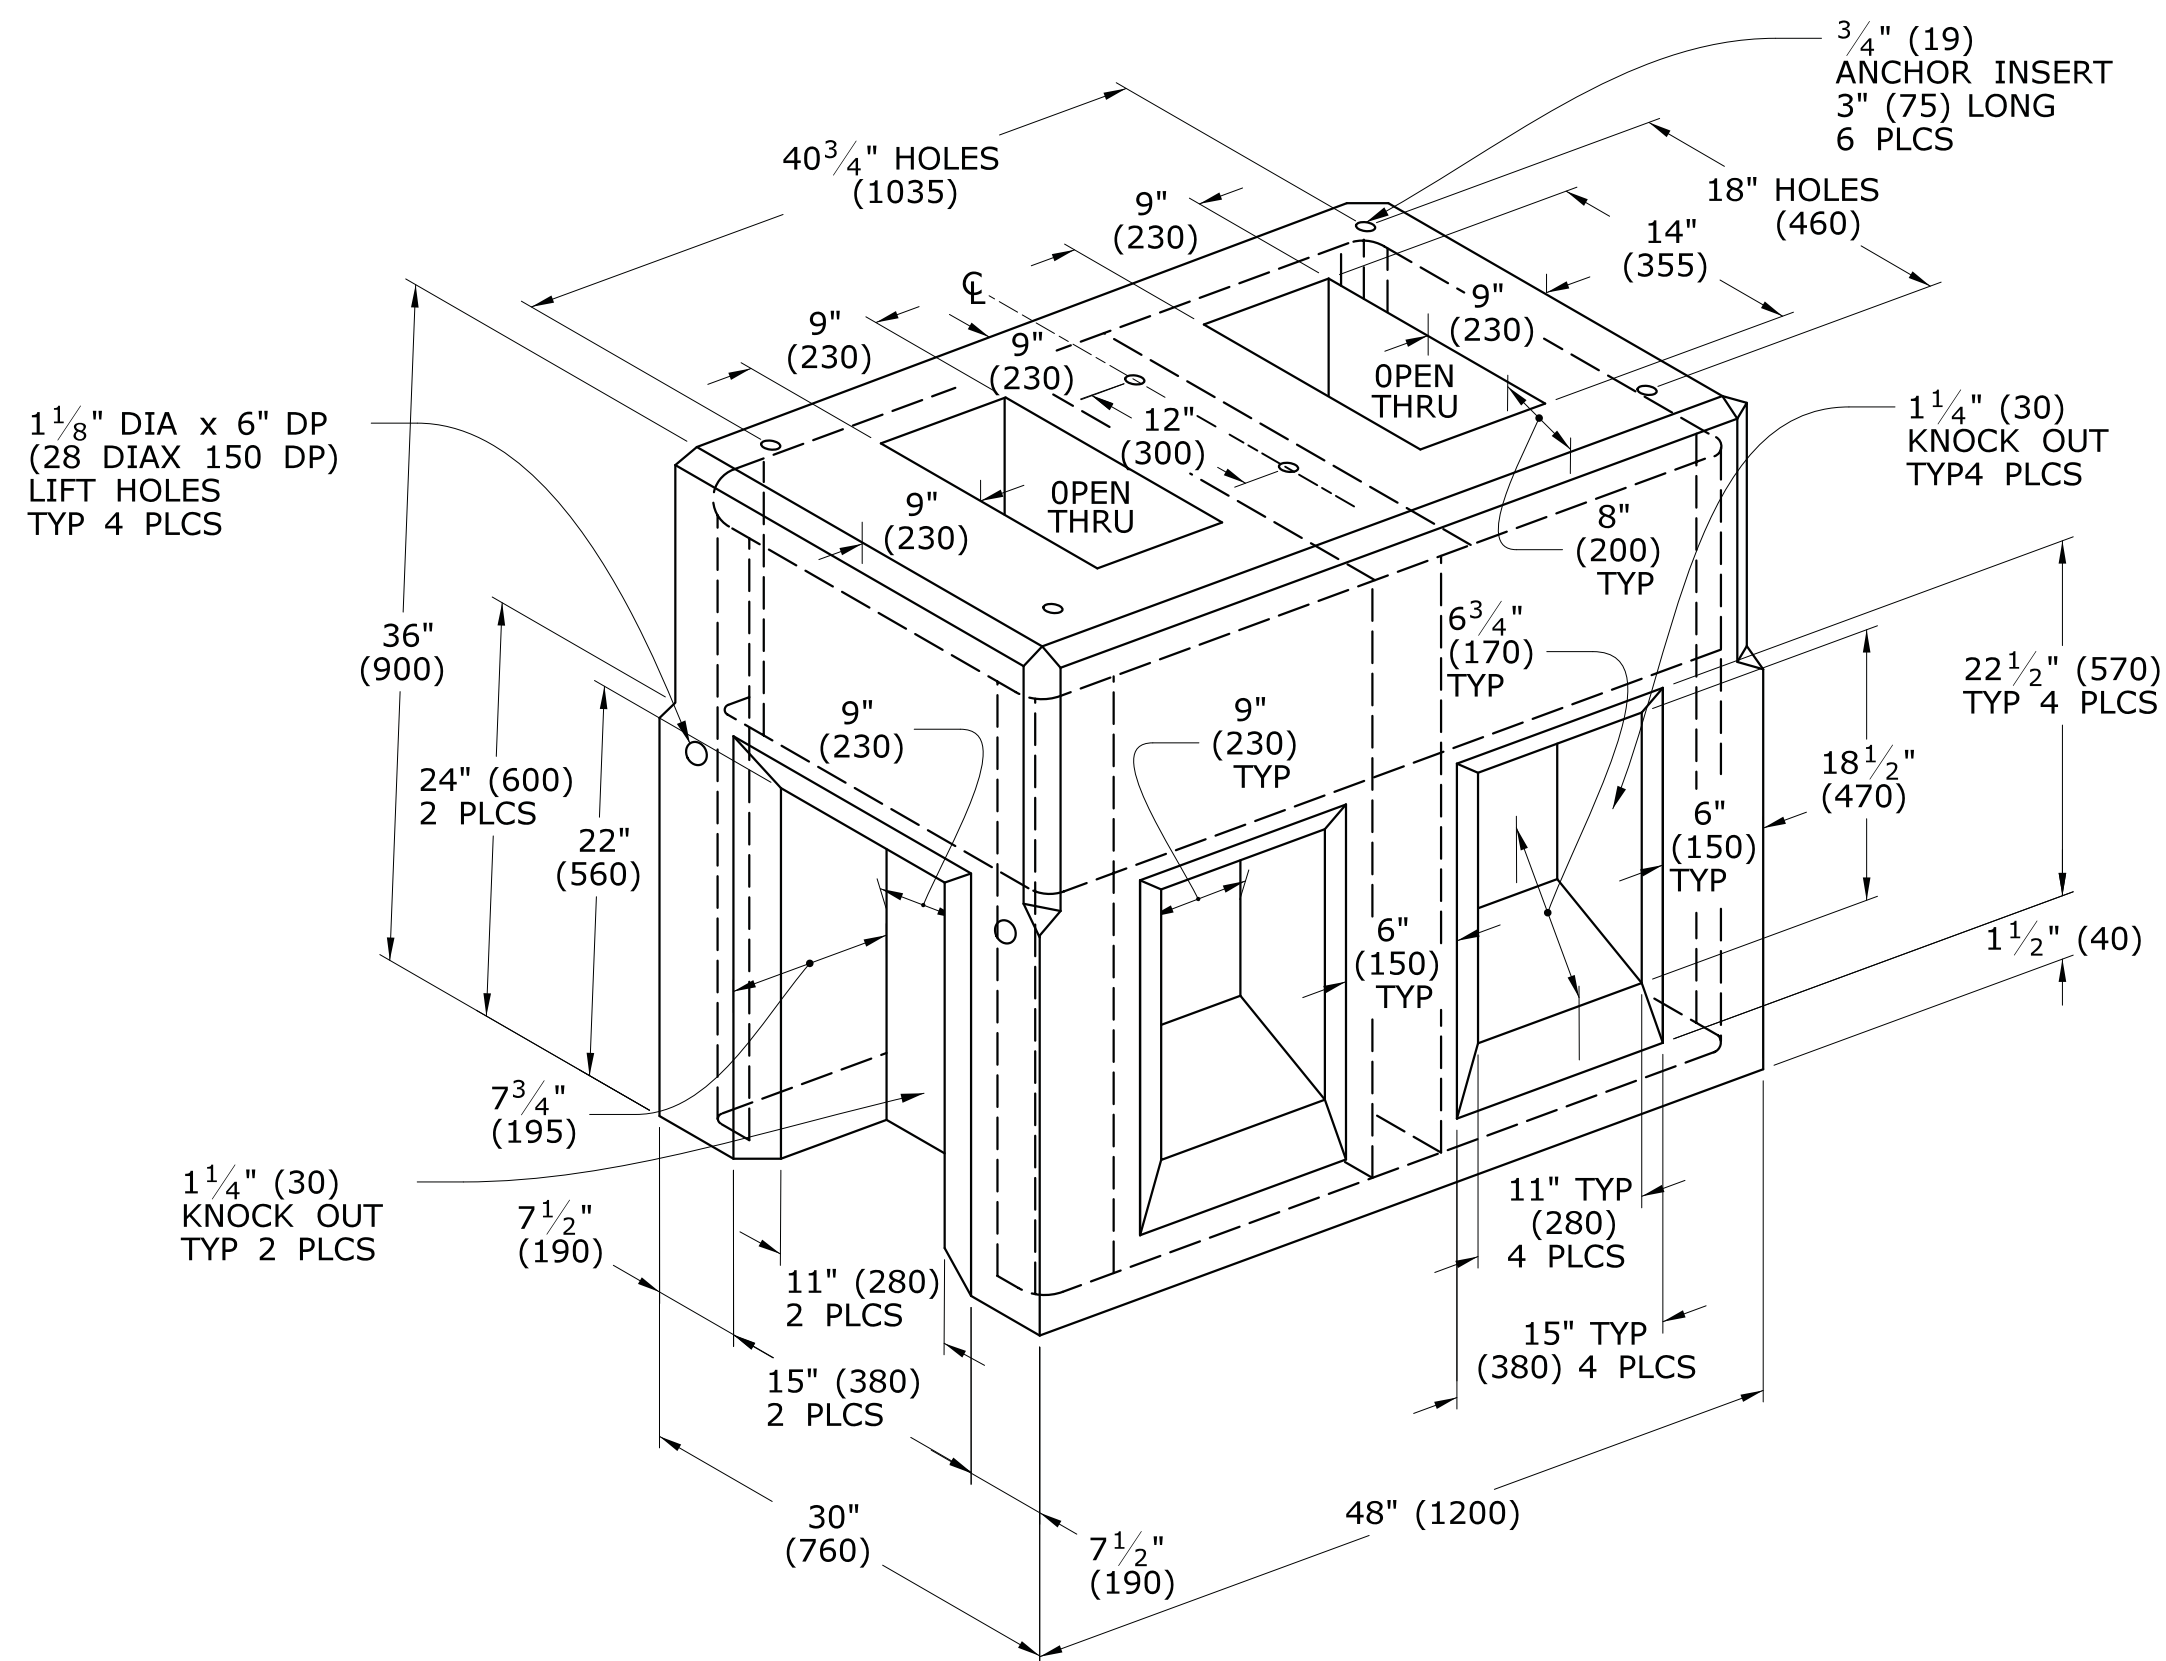


**TRAFFIC CONTROL FOUNDATION
CONTROLLER - TYPE IV - PRECAST**

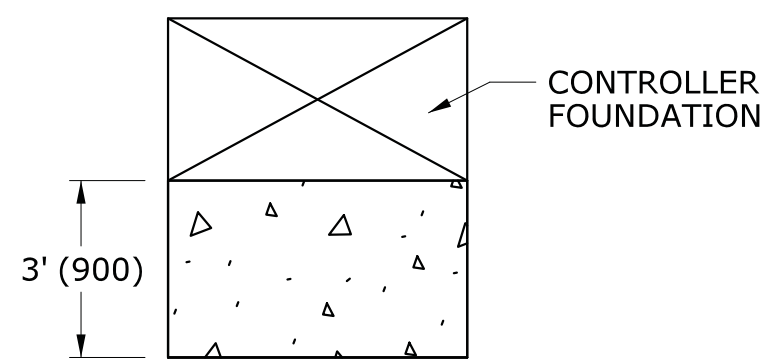

INSTALL PRECAST OR CAST IN PLACE CONCRETE SIDEWALK ON CABINET
DOOR SIDE OF CONTROLLER FOUNDATION.
PITCH SIDEWALK 1/4" PER FOOT (20 PER METER) AWAY FROM THE
CONTROLLER FOUNDATION.
REFER TO HIGHWAY STANDARD SHEET HW-921.01 FOR SIDEWALK CONSTRUCTION.

**TYPICAL CONCRETE SIDEWALK
AT CONTROLLER FOUNDATION**

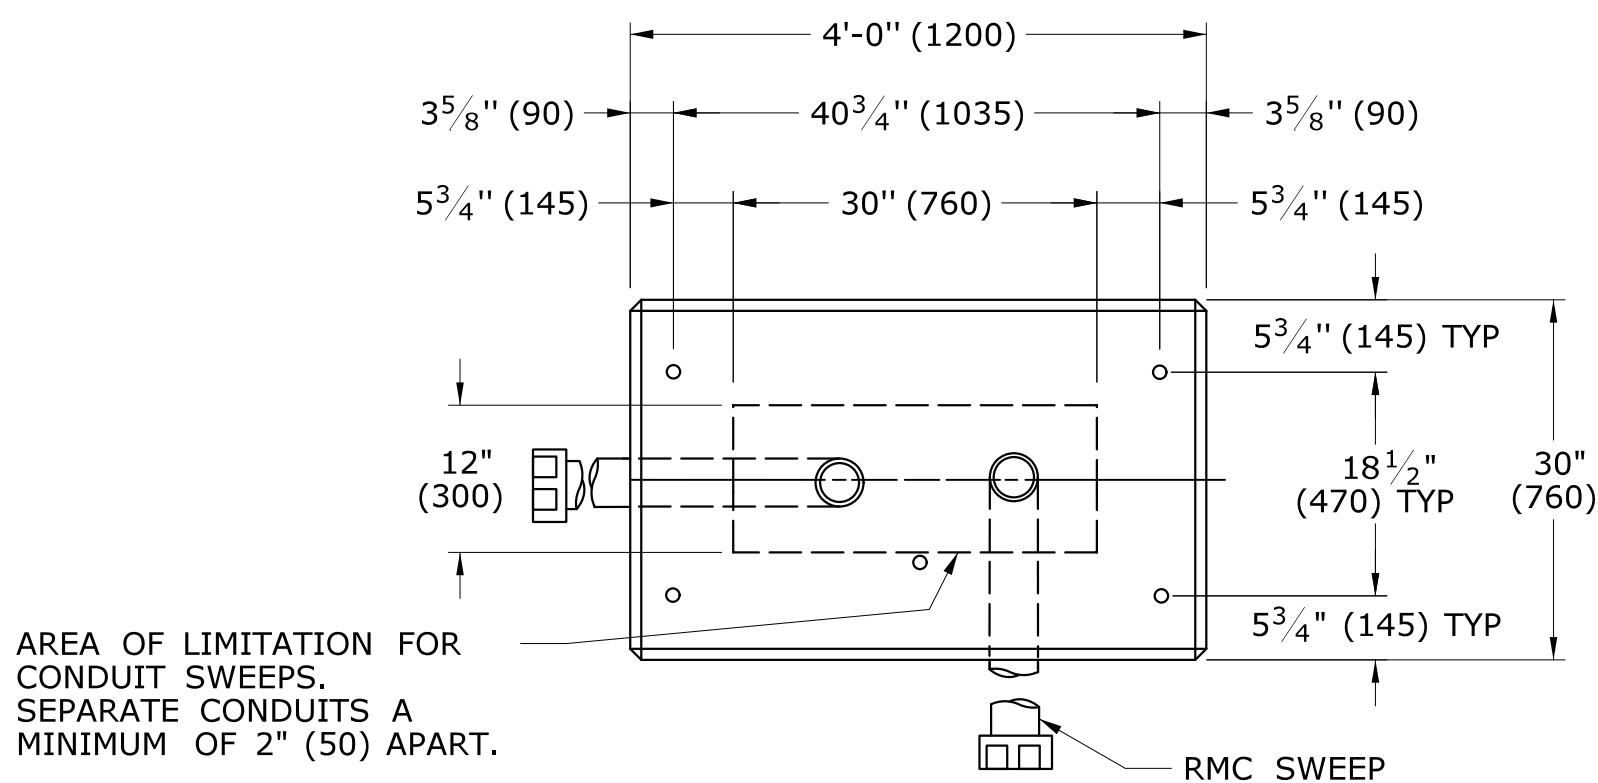

**TRAFFIC CONTROL FOUNDATION
CONTROLLER - TYPE IV - CAST IN PLACE**

NOTES:

INSTALL FOUNDATION ON 6" (150) OF COMPACTED GRAVEL IN ACCORDANCE WITH SECTION 2.14.
LEVEL FOUNDATION WITH A PROJECTION OF 4" (100) ABOVE FINISHED GRADE.
INSTALL COPPER GROUND ROD: 5/8" x 10' (16 x 3000).
PLACE NO. 6 CRUSHED STONE IN THE CENTER OPENINGS AFTER THE CONDUITS AND GROUND ROD
HAVE BEEN INSTALLED. THE OPENINGS SHALL BE CAPPED WITH A 2" (50) GROUT LEVEL WITH THE
TOP OF THE FOUNDATION AND NEATLY FINISHED. THE GROUT SHALL CONFORM WITH THE
REQUIREMENTS OF ARTICLE M.3.01-12.
CONCRETE: CLASS "A" CONFORMING TO ARTICLE M.03.01.
#4 REBAR 2" (50) MIN COVER AROUND ALL OPENINGS, 3-#4 REBARS IN EACH CORNER.
CONDUITS SHALL NOT PROJECT MORE THAN 2" (50) ABOVE FOUNDATION.

LEGEND AS SHOWN ON TRAFFIC CONTROL SIGNAL PLAN:	
	PROPOSED CONTROLLER
	EXISTING CONTROLLER
	PROPOSED STEEL SPAN POLE
	EXISTING STEEL SPAN POLE

REV.	DATE	REVISION DESCRIPTION
2	1-2014	REMOVED SPAN POLE FOUNDATION DETAILS, REVISED TYPICAL CONCRETE SIDEWALK AT CONTROLLER FOUNDATION.
1	4-2012	MINOR REVISIONS.

THE INFORMATION, INCLUDING ESTIMATED QUANTITIES OF WORK, SHOWN ON THESE SHEETS IS BASED ON LIMITED INVESTIGATIONS BY THE STATE AND IS IN NO WAY WARRANTED TO INDICATE THE CONDITIONS OF ACTUAL QUANTITIES OF WORK WHICH WILL BE REQUIRED.
Plotted Date: 1/7/2014

DIMENSIONS ARE IN ENGLISH ("') & METRIC UNITS (mm). METRIC DIMENSIONS ARE ROUNDED: - OVER 1" TO NEAREST 5 mm - UNDER 1" TO NEAREST 1 mm.
NOT TO SCALE

	STATE OF CONNECTICUT DEPARTMENT OF TRANSPORTATION	
Filename: CTDOT_TRAFFIC.STD.DGN	Model: TR-1002_01	

SUBMITTED BY:	NAME/DATE/TIME:
APPROVED BY:	NAME/DATE/TIME:


CTDOT STANDARD SHEET
OFFICE OF ENGINEERING

STANDARD SHEET TITLE:
TRAFFIC CONTROL FOUNDATIONS


STANDARD SHEET NO.:
TR-1002_01

COVER NOTES:


1. GROUNDING TAB WELDED TO BOTTOM CENTER OF COVER WITH 3/16" (5) WELD (3 SIDES).
2. ATTACH 6' (2 m) LENGTH OF NO. 8 GROUND WIRE TO GROUNDING TAB WITH CONDUCTOR CONNECTOR, 1/4" - 20 X 3/4" (M6 X 20) LG SST HEX HEAD BOLT, AND SST FLAT WASHER. ATTACH FREE END OF GROUND WIRE TO CONDUIT BONDING BUSHING IN HANDHOLE.
3. CONDUCTOR CONNECTOR: COPPER ALLOY BODY, BRASS SCREW, BRASS OR COPPER ALLOY PRESSURE PLATE.
4. COVER SCREW INSERT: 3/8"-16 (9-16), 1 1/2"L (37L), STAINLESS STEEL.
5. COVER SCREW: 3/8"-16 (9-16), 1"L (25L), FLAT HEAD, SLOTTED, STAINLESS STEEL.

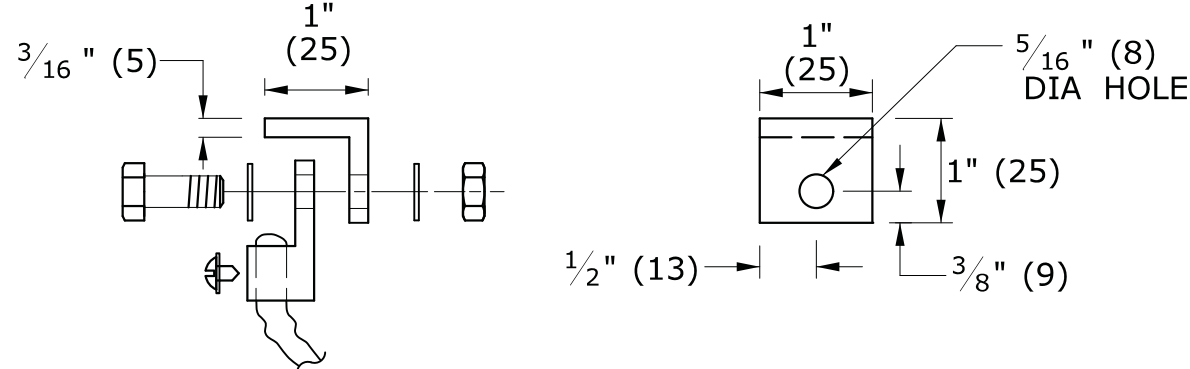


STEEL GROUNDING TAB
w/ CONDUCTOR CONNECTOR

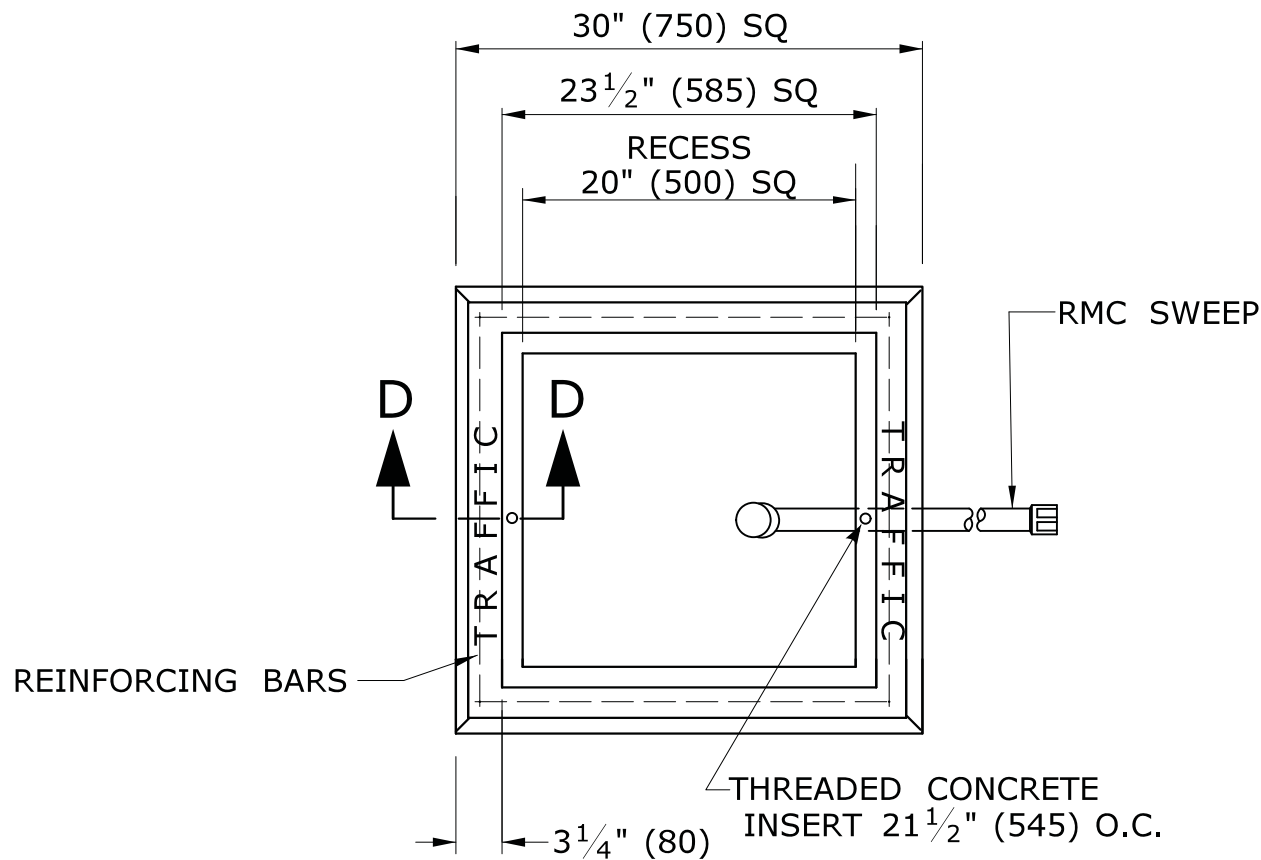




PLAN VIEW

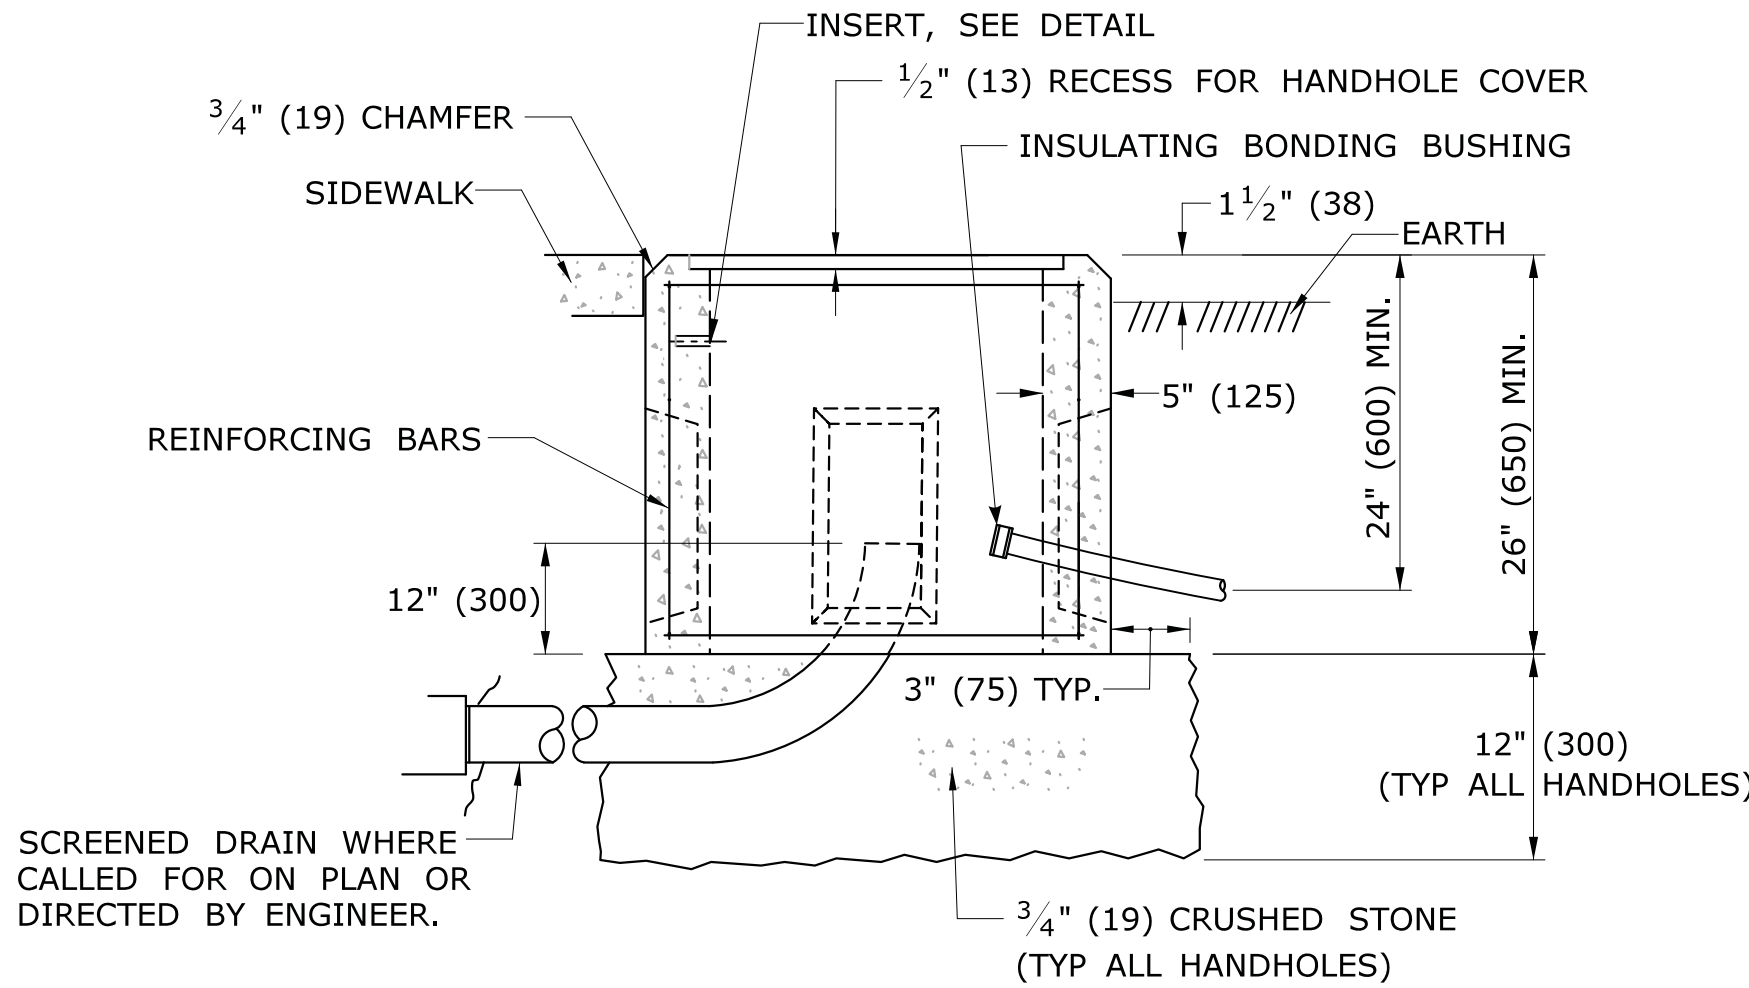


CONCRETE HANDHOLE TYPE I

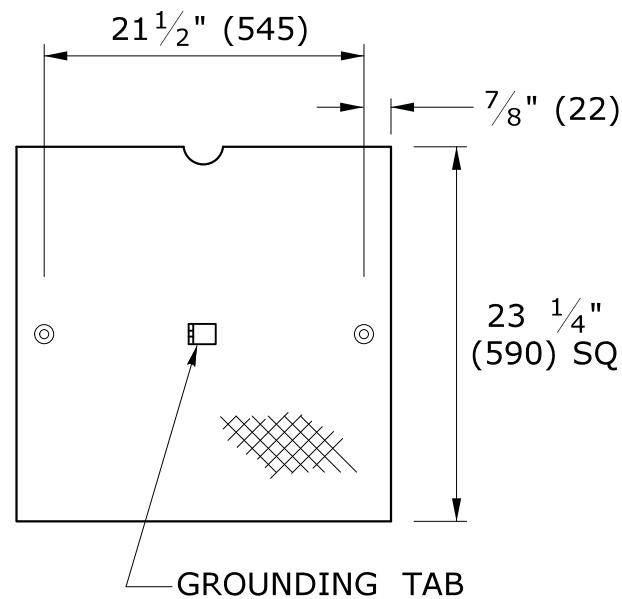

NON SKID FLOOR PLATE
GALVANIZED STEEL, 3/8" (10)

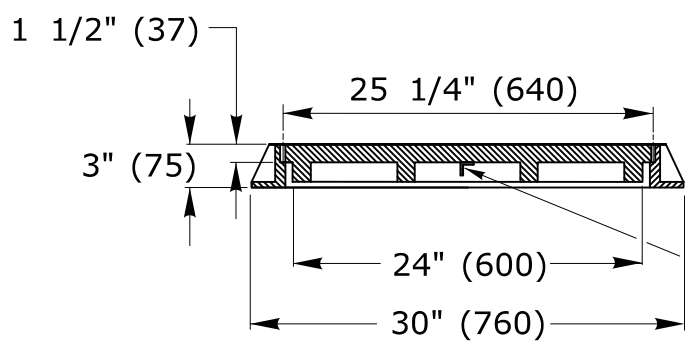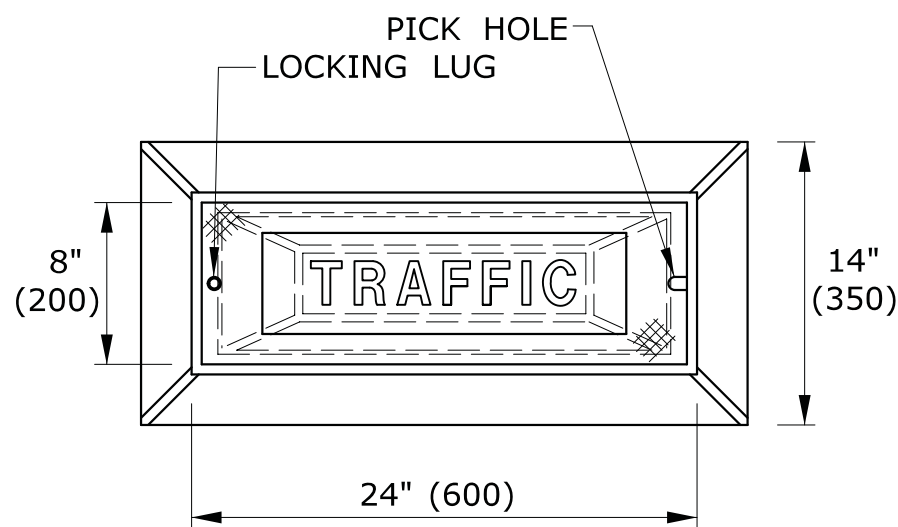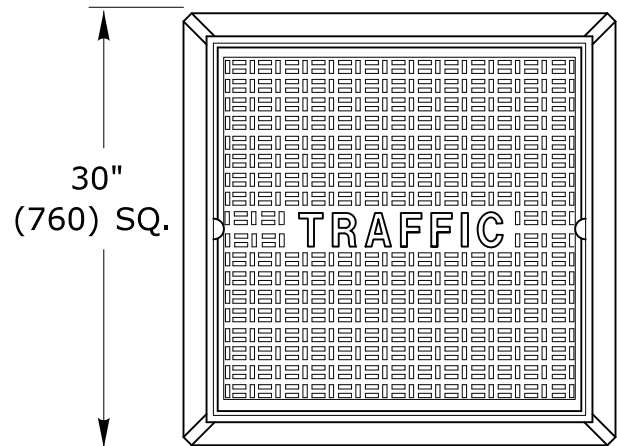

CAST IRON
HANDHOLE COVERS


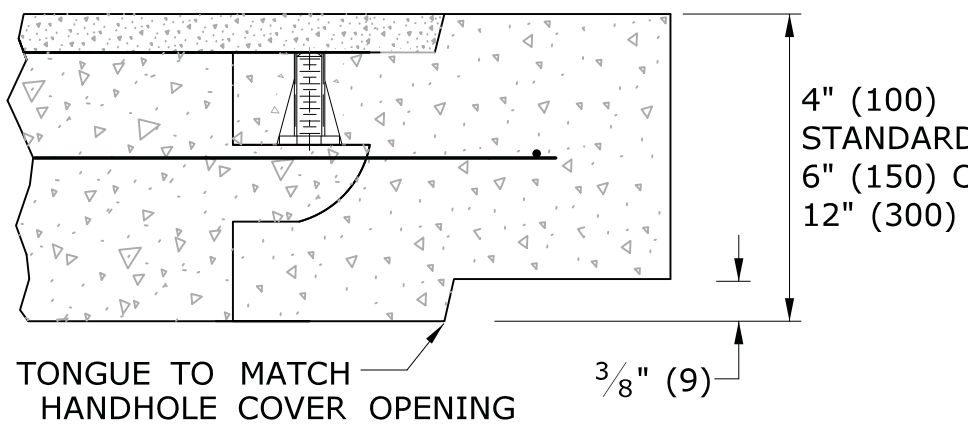


SECTION A-A
HANDHOLE EXTENSIONS


4 - #8 REINFORCING BARS REQ'D

HANDHOLE NOTES:


1. MINIMUM CLASS "C" CONCRETE.
2. COMPLETE TYPE II HANDHOLE:
IN EARTH AREAS, CONSISTS OF A BASE SECTION WITH 4" (100) HANDHOLE EXTENSION, IN SIDEWALK AREAS, CONSISTS OF A BASE SECTION WITH 4" (100) CAST IRON COVER.
3. PLAN VIEW DIMENSIONS, SECTION VIEW, & DETAILS, SAME FOR BASE SECTION, EXTENSIONS & BANK ADAPTER.
4. GROUT AROUND ALL CONDUITS.

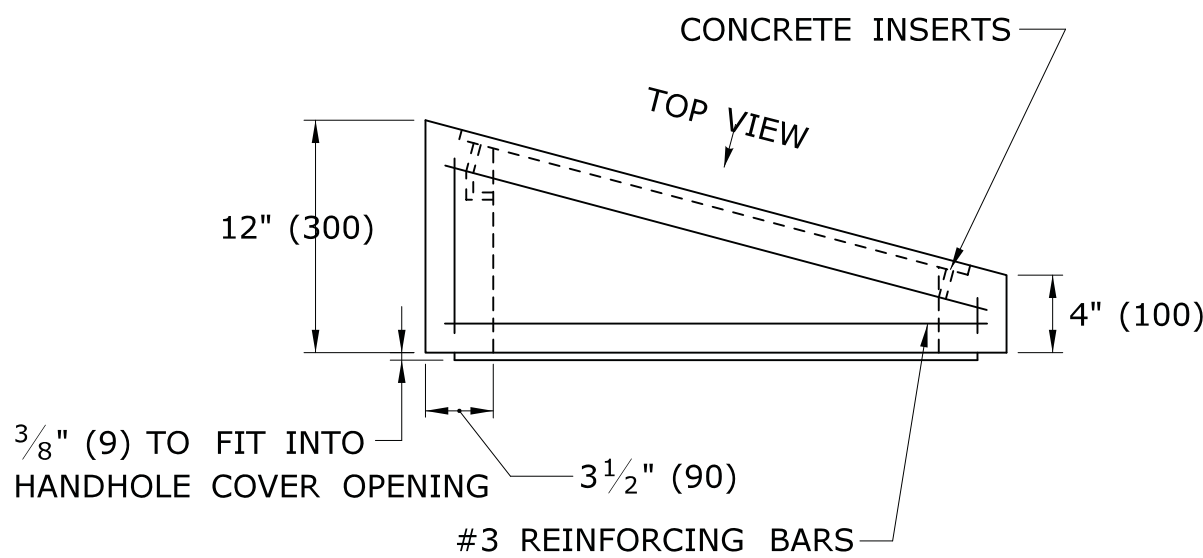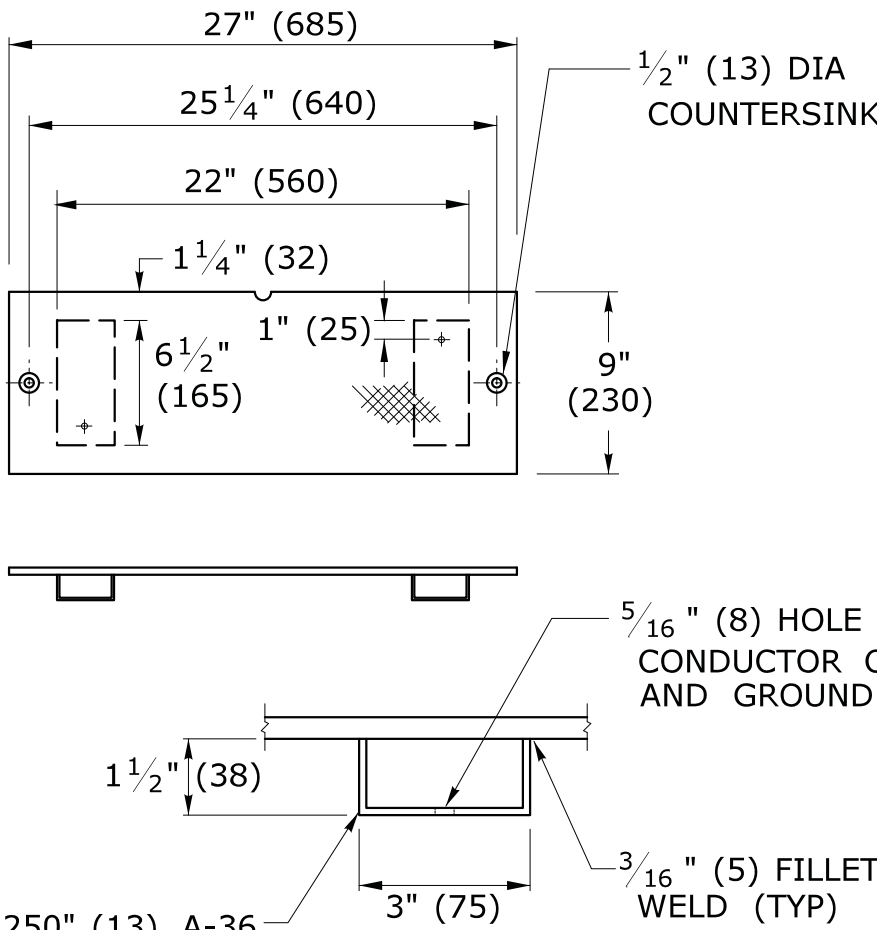


BANK ADAPTER

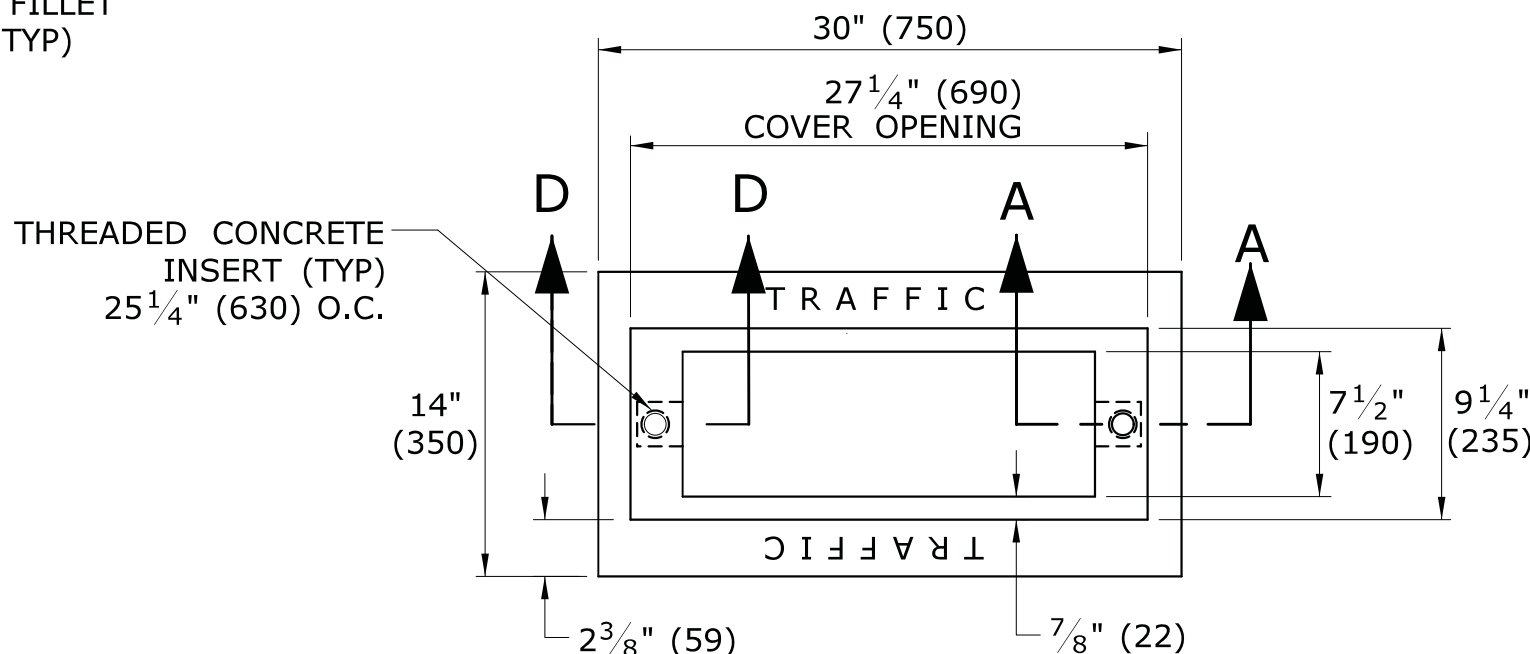

PLAN VIEW

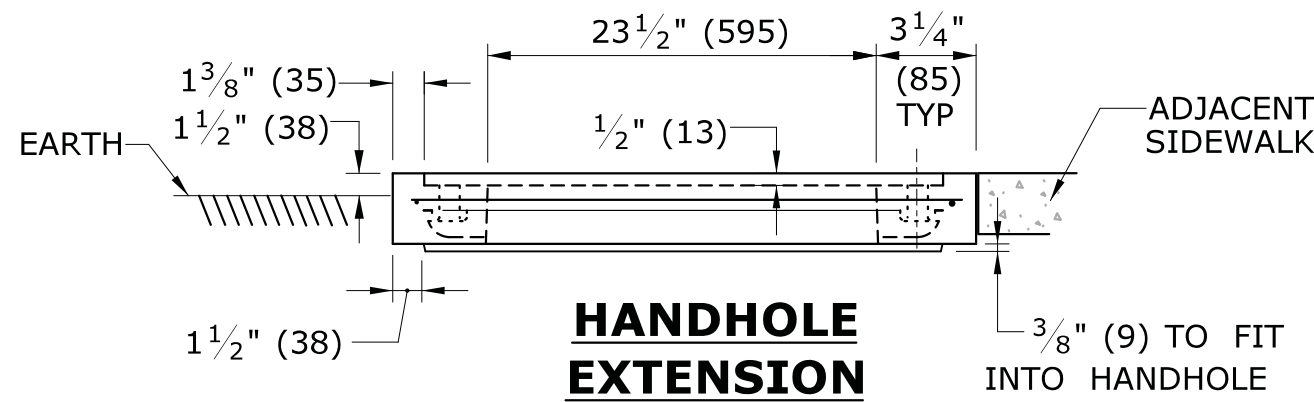


HANDHOLE
EXTENSION

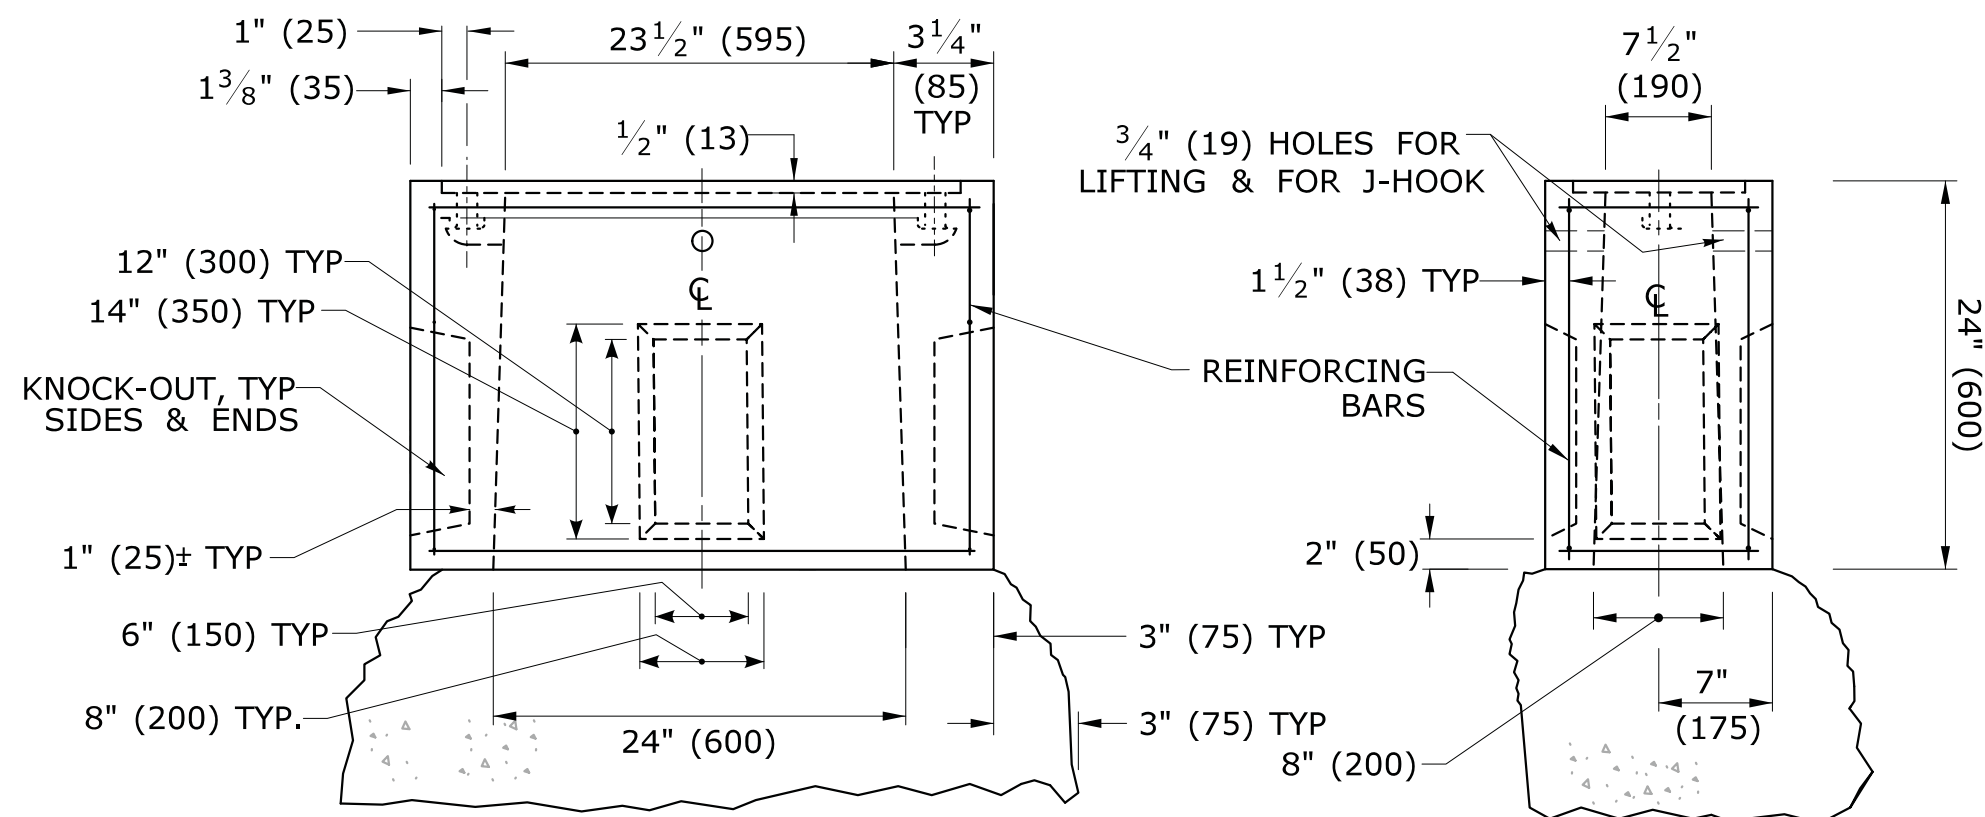


BASE SECTION
CONCRETE HANDHOLE TYPE II

5. INSTALL 30" (750) SIDE PARALLEL TO ROAD UNLESS OTHERWISE NOTED.
6. INSTALL HANDHOLES APPROX. 12" (300) BEHIND CURB OR IF NO CURB, 24" (600) BEHIND EDGE OF ROAD UNLESS OTHERWISE SPECIFIED.
7. CAST THE WORD "TRAFFIC" INTO TOP EDGE OF HANDHOLE, 1 1/2" (38) LETTERS.
8. WHERE AN EXISTING CONCRETE SIDEWALK SLAB ABUTTING A HANDHOLE IS DAMAGED OR CUT DURING INSTALLATION, REPLACE THE ENTIRE SIDEWALK SECTION.
9. 12-#3 REINFORCING BARS REQUIRED FOR ALL HANDHOLES. (8 HORIZONTAL, 4 VERTICAL)

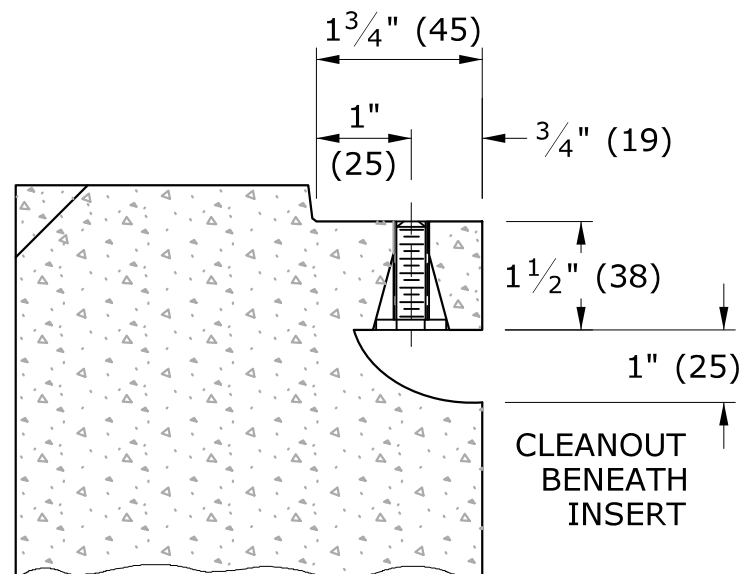

SECTION D-D

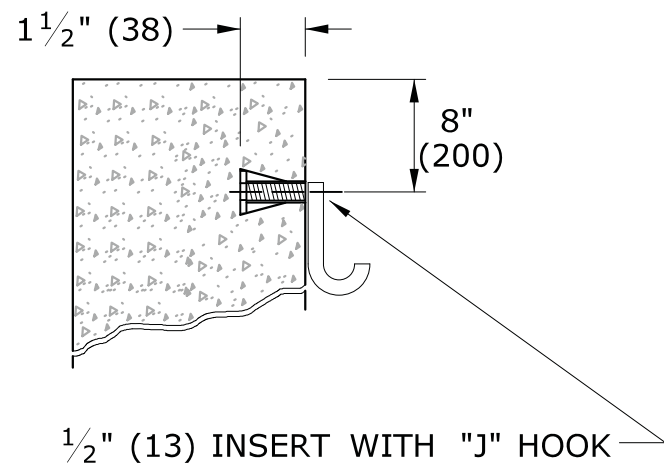

INSERT DETAIL

TYP IN TWO PLACES FOR ALL HANDHOLES

LEGEND AS SHOWN ON TRAFFIC CONTROL SIGNAL PLAN:

- PROPOSED HANDHOLE
- EXISTING HANDHOLE


REV.	DATE	REVISION DESCRIPTION
2	4-2014	REVISED HANDHOLES NOTES, ADDED NOTE #6. ADDED "J" HOOK TO INSERT DETAIL.
1	4-2012	CAST IRON COVER: CHANGED BOLT TO PICK HOLE. ADDED EXTENSIONS, C-CHANNEL, CONDUCTOR CONNECTOR & MINOR REVISIONS.

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Plotted Date: 4/11/2014

DIMENSIONS ARE IN ENGLISH ("') & METRIC UNITS (mm). METRIC DIMENSIONS ARE ROUNDED: - OVER 1" TO NEAREST 5 mm - UNDER 1" TO NEAREST 1 mm.

NOT TO SCALE

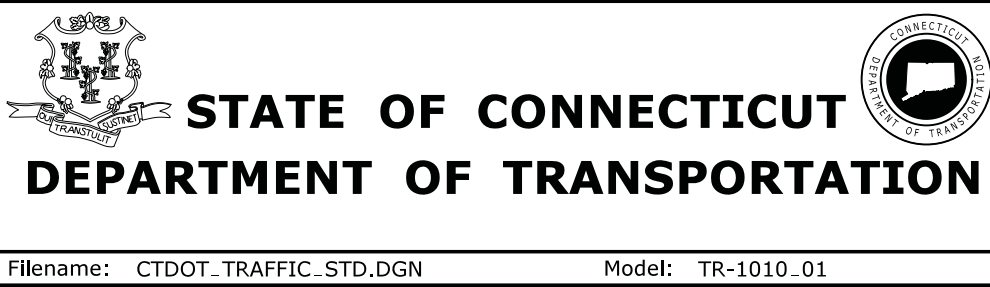


SUBMITTED BY:	NAME/DATE/TIME:
APPROVED BY:	NAME/DATE/TIME:

CTDOT
STANDARD SHEET
OFFICE OF ENGINEERING


STANDARD SHEET TITLE:
CONCRETE HANDHOLE

STANDARD SHEET NO.:
TR-1010_01

TR-1102_01

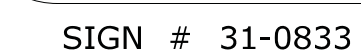


* USE APPROPRIATE ARROW UNLESS OTHERWISE NOTED ON PLAN.

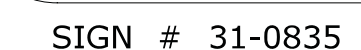

FOR CROSSING
WITH SIDE STREET GREEN

GENERAL NOTES:

3'-6" (1050) FROM FINISHED GRADE SUCH AS SIDEWALK TO CENTER OF PUSH BUTTON.
PUSH BUTTON INSTALLATIONS SHALL CONFORM TO THE REQUIREMENTS OF THE AMERICANS
WITH DISABILITIES ACT (ADA) STANDARDS FOR ACCESSIBLE DESIGN, CURRENT EDITION GOVERNS.
4'-4" (1300) PEDESTAL TO INCLUDE ALLOY CAP SECURED WITH STAINLESS STEEL SET SCREW.

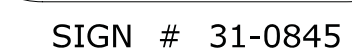

* USE APPROPRIATE ARROW UNLESS OTHERWISE NOTED ON PLAN.

EXAMPLE ALIGNMENTS FOR EXCLUSIVE PEDESTRIAN PHASE


2	4-2014	ADDED PEDESTRIAN EXAMPLE ALIGNMENTS
1	4-2012	MINOR REVISIONS & UPDATED SIGN #31-0845.
REV.	DATE	REVISION DESCRIPTION

THE INFORMATION, INCLUDING ESTIMATED QUANTITIES OF WORK, SHOWN ON THESE SHEETS IS BASED ON LIMITED INVESTIGATIONS BY THE STATE AND IS IN NO WAY WARRANTED TO INDICATE THE CONDITIONS OF ACTUAL QUANTITIES OF WORK WHICH WILL BE REQUIRED.

Plotted Date: 4/25/2014

DIMENSIONS ARE IN ENGLISH ("")
& METRIC UNITS (mm).
METRIC DIMENSIONS ARE ROUNDED:
- OVER 1" TO NEAREST 5 mm
- UNDER 1" TO NEAREST 1 mm.

NOT TO SCALE

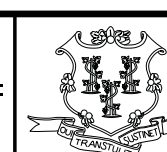

STATE OF CONNECTICUT
DEPARTMENT OF TRANSPORTATION



Filename: CTDOT_TRAFFIC_STD.DGN

Model: TR-1107_01

SUBMITTED BY:	NAME/DATE/TIME:
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APPROVED BY: _____ NAME/DATE/TIME: _____

**CTDOT
STANDARD SHEET**


OFFICE OF ENGINEERING

STANDARD SHEET TITLE:

PEDESTRIAN PUSH BUTTONS

STANDARD SHEET NO.:

TR-1107_01

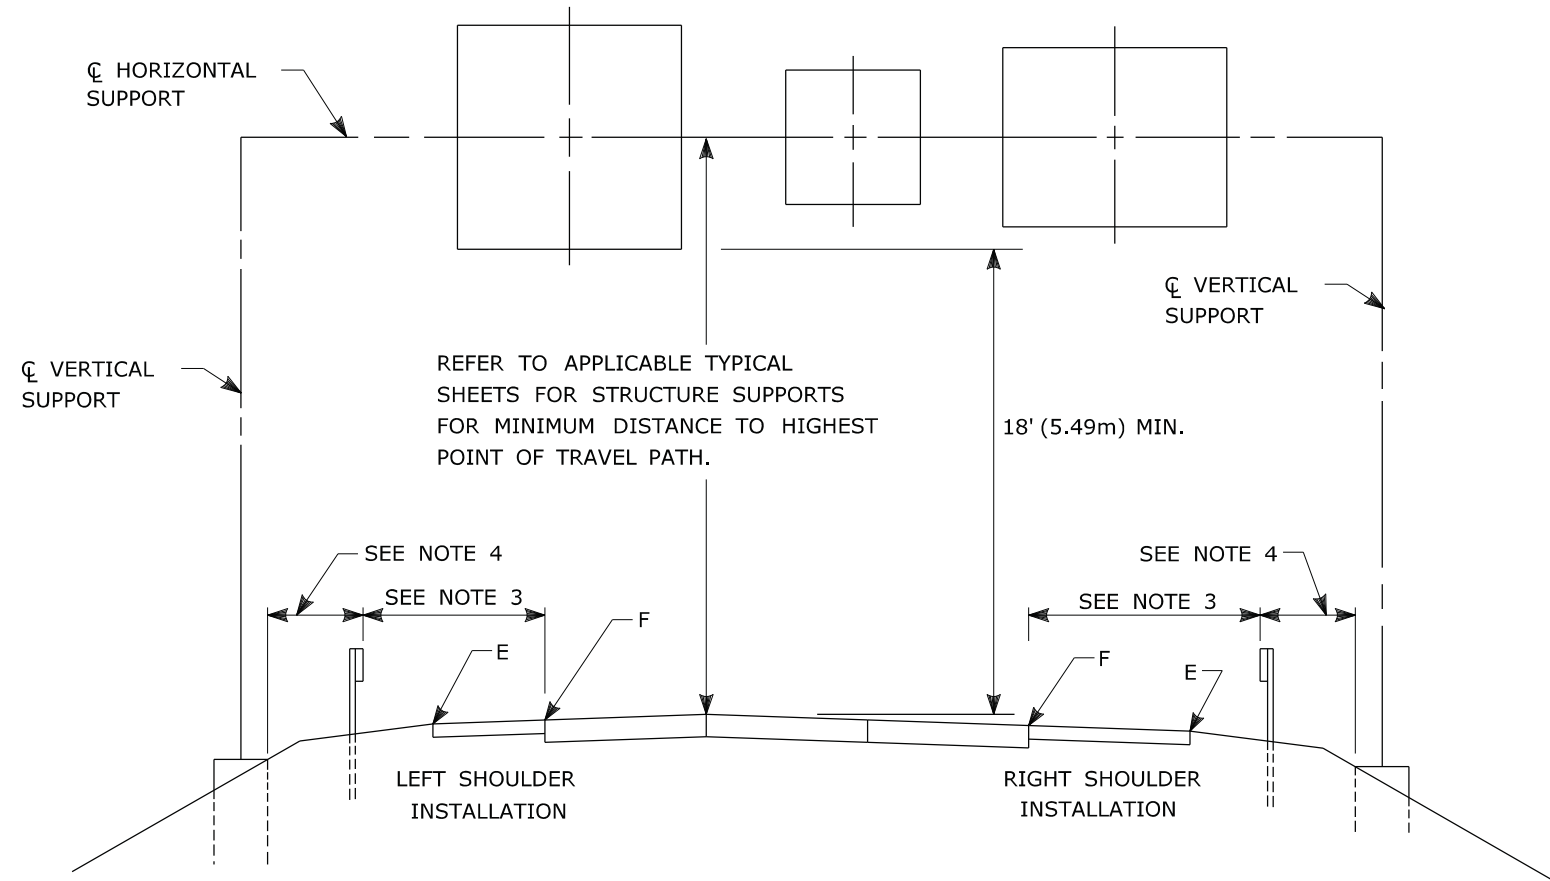

GUIDE RAIL PLACEMENT FOR SIGN SUPPORTS

- NOTES:
- 1) FOR PLACEMENT OF CANTILEVER SIGN SUPPORT USE APPLICABLE PORTION OF ABOVE DETAIL.
 - 2) BARRIER SYSTEM IS REQUIRED FOR BOTH SIDES OF MEDIAN SUPPORTS IN NARROW MEDIANS.
 - 3) AT LOCATIONS WHERE IMPACT PROTECTION IS NOT REQUIRED FOR ROADSIDE ELEMENTS, FACE OF GUIDE RAIL SHALL BE PLACED 30' (9.1m) FROM EDGE OF TRAVELWAY.
 - 4) OFFSETS OF FOUNDATIONS FROM BARRIER SYSTEMS SHALL BE AS SHOWN ELSEWHERE ON THE CONTRACT PLANS.
 - 5) ALL SIGNS ARE TO BE HORIZONTAL, REGARDLESS OF CAMBER IN SUPPORT.

FOR MAXIMUM EFFECTIVENESS AND TO ELIMINATE OR MINIMIZE GLARE, POSITION SIDE MOUNTED SIGNS ON STRUCTURAL STEEL BREAKAWAY SIGN SUPPORTS AS FOLLOWS:

ON A TANGENT SECTION, POSITION THE SIGN SO THE VERTICAL AXIS IS PLUMB AND THE HORIZONTAL AXIS IS AT AN ANGLE OF 93° WITH THE TRAFFIC LANE WHICH THE SIGN SERVES:

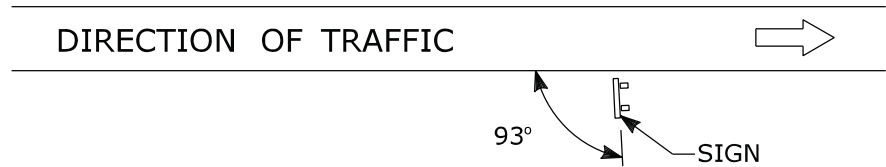


DIAGRAM "A"

ON A HORIZONTAL CURVE SECTION, POSITION THE SIGN SO THE VERTICAL AXIS IS PLUMB AND THE HORIZONTAL AXIS IS AT AN ANGLE OF 90° WITH A STRAIGHT LINE BETWEEN THE SIGN AND THE POINT AT WHICH THE SIGN SHALL BE READ.



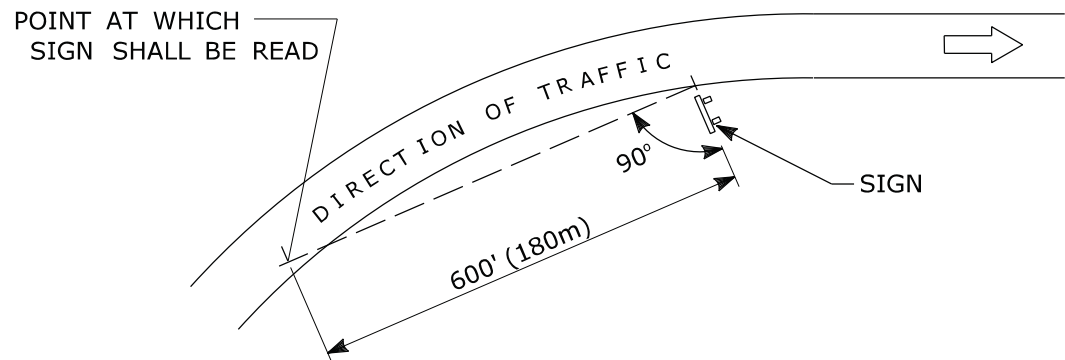


DIAGRAM "B"


SIGN ORIENTATION DETAILS

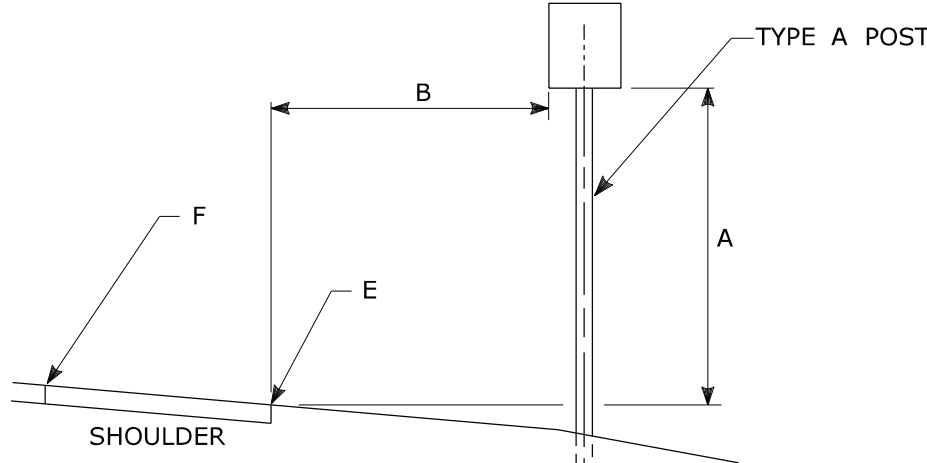

TYPICAL REGULATORY & WARNING SIGN PLACEMENT

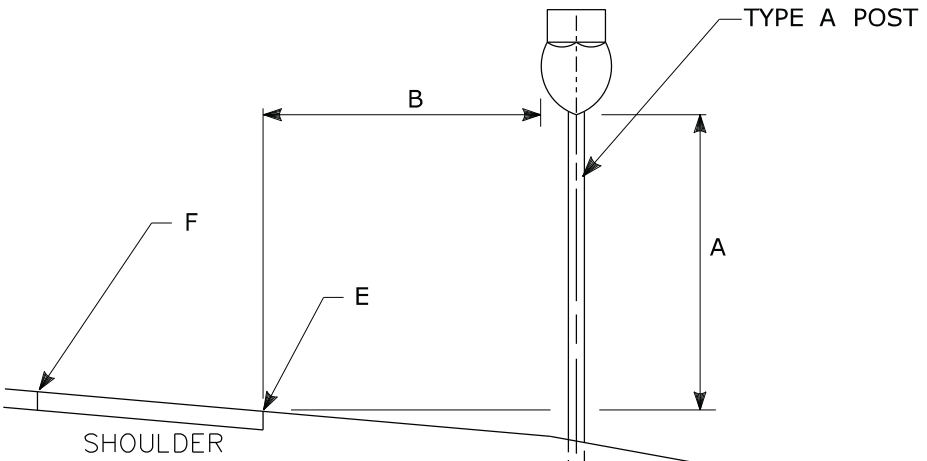

TYPICAL CONFIRMATORY ROUTE MARKER PLACEMENT

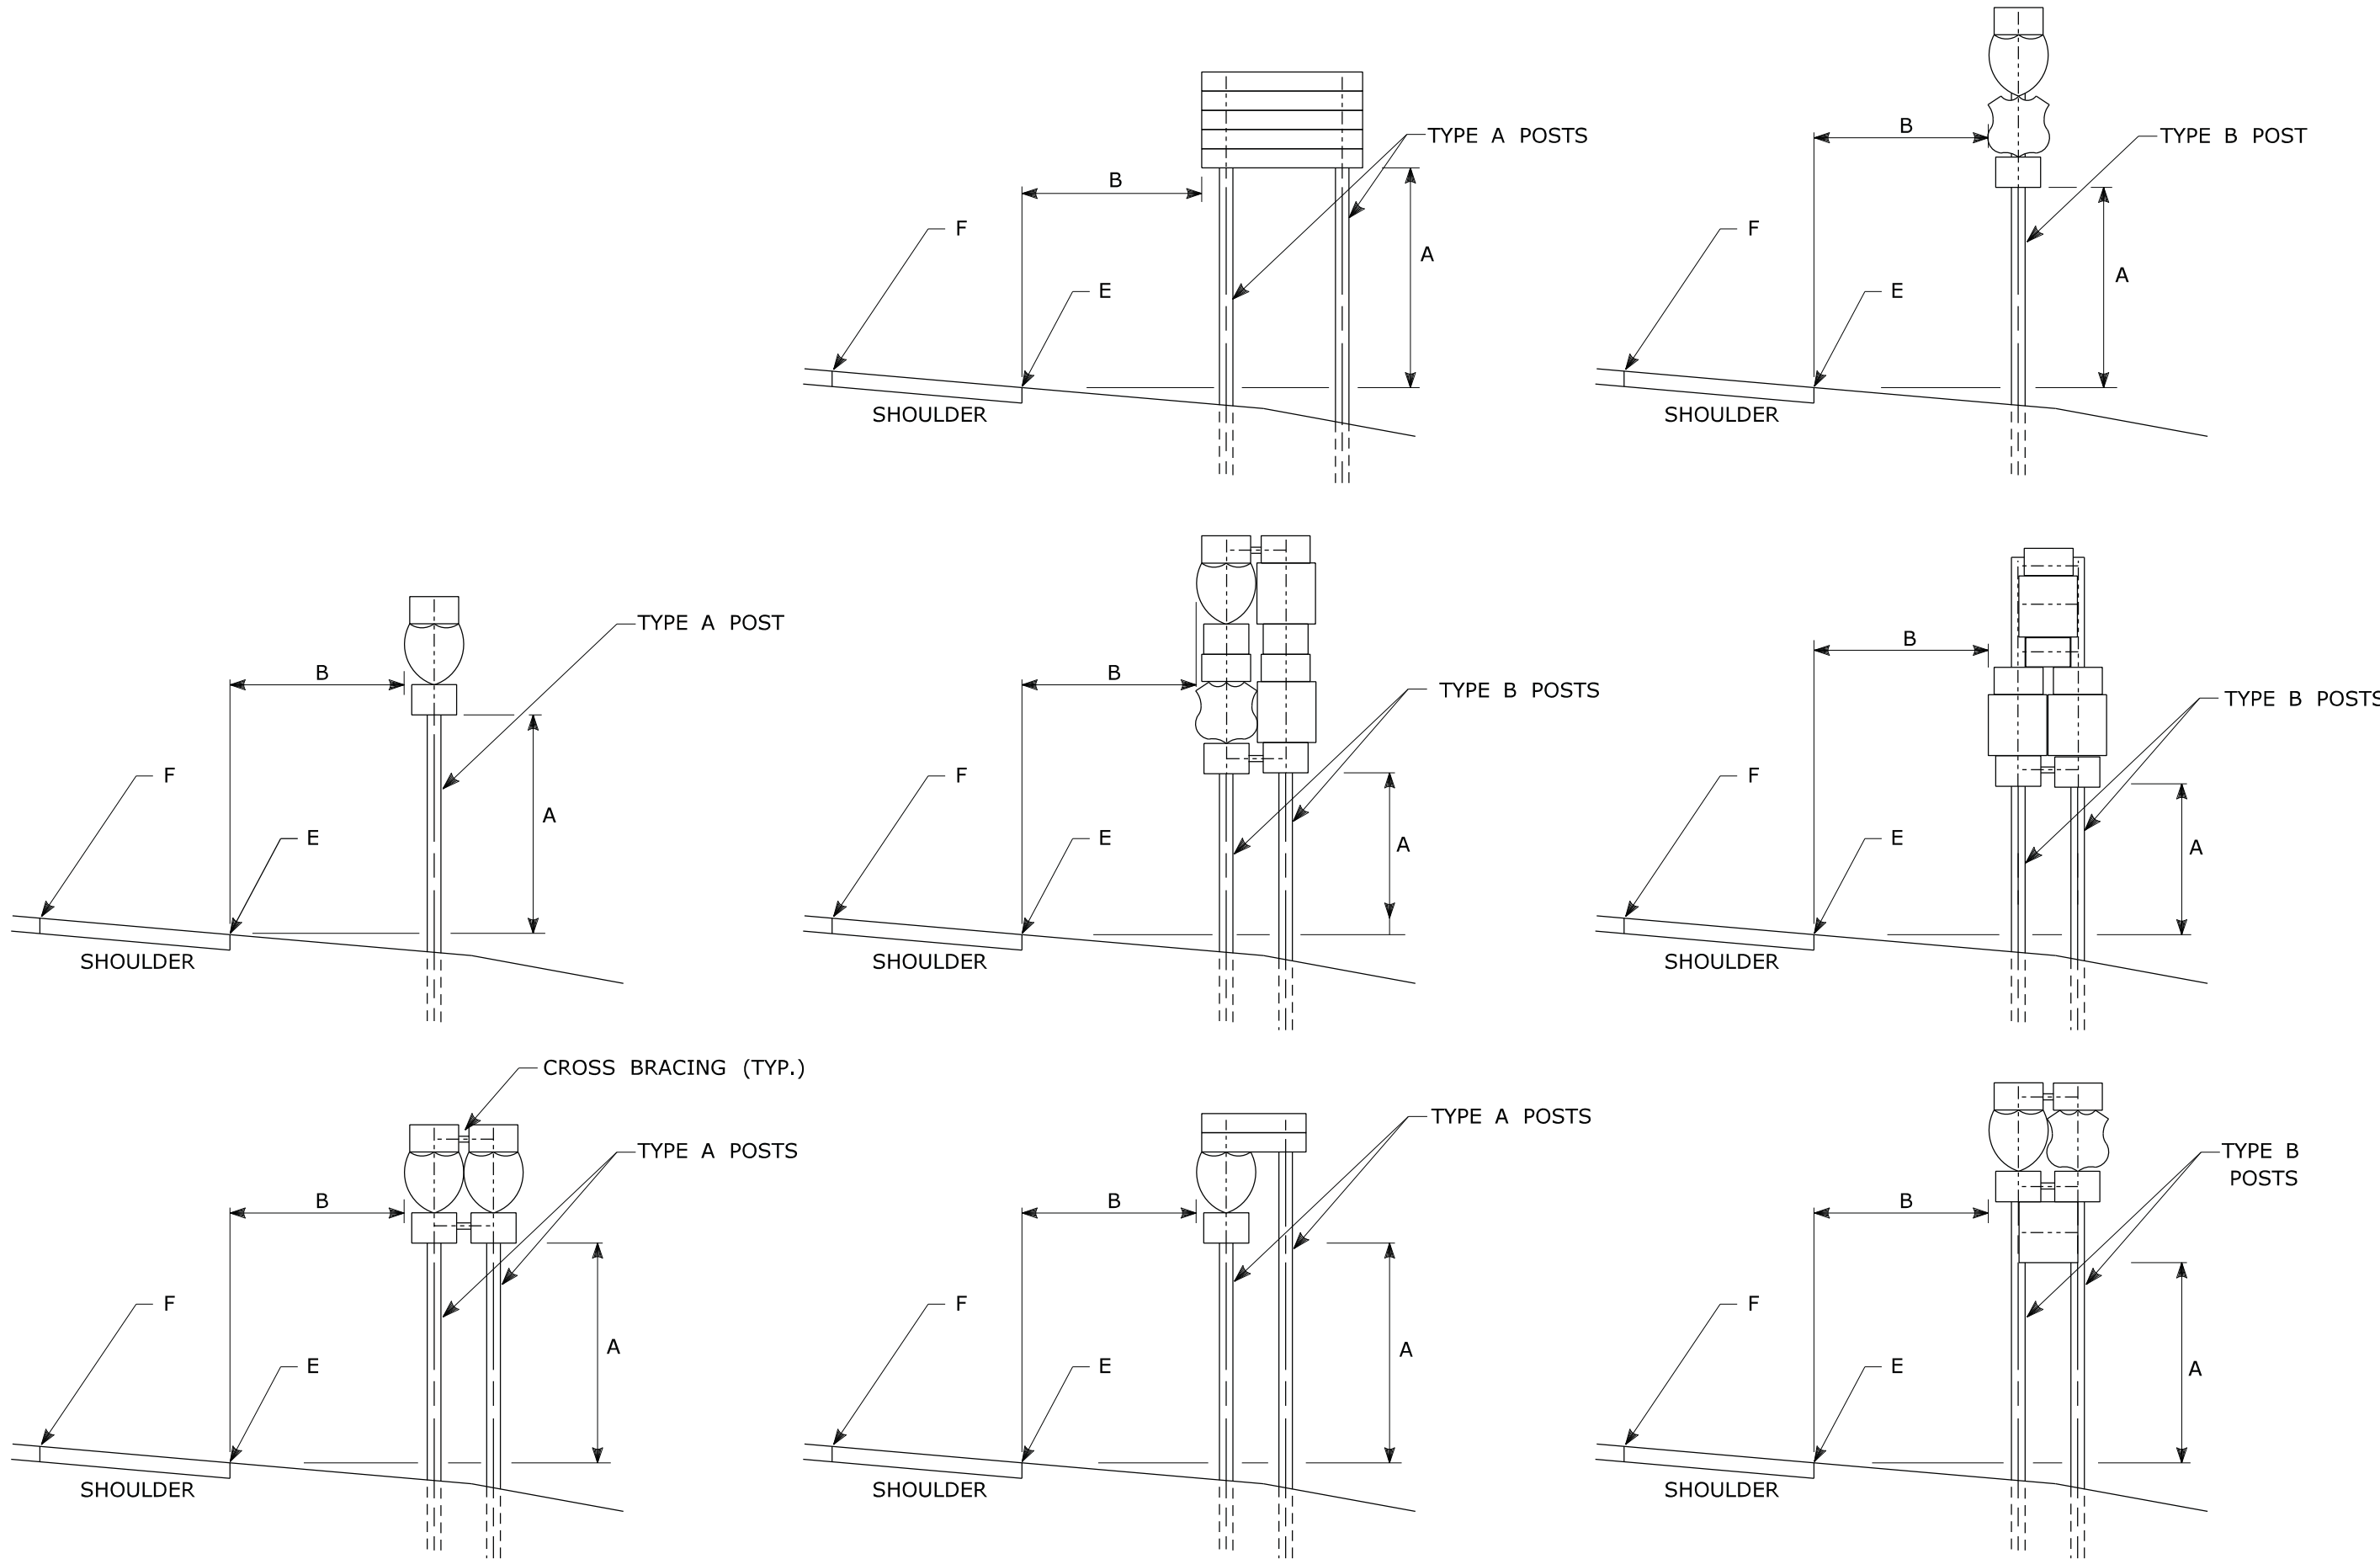

TYPICAL SIGN PLACEMENT AND POST SELECTION

NOTES:

ALL SIGNS AND SHIELDS ON DIRECTIONAL ASSEMBLIES SHALL ABUT VERTICALLY

2 POST ASSEMBLIES SHALL BE PROVIDED WITH 3" X 1/4" (75 X 6) GALVANIZED STEEL BAR CROSS BRACING.





REFER TO TRAFFIC TYPICAL SHEET "TYPICAL METAL SIGN POSTS AND SIGN MOUNTING DETAILS" FOR SIGN POSTS.

DIM."A"	DIM."B" ¹	ASSEMBLY LOCATION
7' (2.1m)	6' (1.8m) ² 12' (3.6m) ²	RURAL DISTRICTS & EXPRESSWAYS
7' (2.1m)	2' (0.6m)	BUSINESS & RESIDENTIAL DISTRICTS WHERE PARKING OR OTHER OBSTRUCTIONS LIMIT VISIBILITY
8'-6" (2.6m)	1' (0.3m)	SIDEWALKS ³

- ¹ OR AS DIRECTED BY THE ENGINEER
- ² 6' FROM EDGE OF SHOULDER, WHEN SHOULDER IS OVER 6' WIDE
12' FROM EDGE OF TRAVELWAY, WHEN SHOULDER IS LESS THAN 6' WIDE.
- ³ A CLEAR PATH OF NOT LESS THAN 3 FT (0.9m) SHALL BE PROVIDED IN SIDEWALK AREAS.
- "E" DENOTES EDGE OF SHOULDER OR FACE OF CURB
- "F" DENOTES EDGE OF TRAVELWAY

TYPICAL PLACEMENT OF SIDE MOUNTED SIGNS ON STRUCTURAL STEEL BREAKAWAY SIGN SUPPORTS

- NOTES:
- 1) MIN. VERTICAL CLEARANCE ABOVE SIDEWALKS SHALL BE 8'-6" (2.6m).
 - 2) WHERE GUIDE RAIL IS USED, THE OFFSET TO THE NEAR EDGE OF SIGN FACE SHALL BE AS SHOWN ELSEWHERE IN THE CONTRACT PLANS.
 - 3) ON INTERSECTING ROADS AT RAMP TERMINI, THE OFFSET TO THE NEAR EDGE OF OF SIGN FACE SHALL BE 6' (1.8m) MIN. FROM POINT "E".
 - 4) IF 30'-0" (9.1m) MIN. CANNOT BE MET, PLEASE CONTACT THE ENGINEER.

				THE INFORMATION, INCLUDING ESTIMATED QUANTITIES OF WORK, SHOWN ON THESE SHEETS IS BASED ON LIMITED INVESTIGATIONS BY THE STATE AND IS IN NO WAY WARRANTED TO INDICATE THE CONDITIONS OF ACTUAL QUANTITIES OF WORK WHICH WILL BE REQUIRED.		DIMENSIONS ARE IN ENGLISH (") & METRIC UNITS (mm). METRIC DIMENSIONS ARE ROUNDED: - OVER 1" TO NEAREST 5 mm - UNDER 1" TO NEAREST 1 mm.		 STATE OF CONNECTICUT DEPARTMENT OF TRANSPORTATION 		SUBMITTED BY:  Charles S. Harlow 2011.02.22 11:09:17 -05'00'		NAME/DATE/TIME:		CTDOT STANDARD SHEET		SIGN SUPPORT & SIGN PLACEMENT DETAILS, GORE EXIT SIGN		STANDARD SHEET TITLE:		STANDARD SHEET NO.: TR-1208_01	
1		2-2011		MINOR REVISIONS.		NOT TO SCALE		Filename: CTDOT_TRAFFIC_STD.dgn Model: TR-1208_01		APPROVED BY:  John F. Carey 2011.03.02 09:19:01 -05'00'		NAME/DATE/TIME:									
REV.		DATE		REVISION DESCRIPTION		Plotted Date: 2/16/2011															

The drawing illustrates two types of tapered pipe piles, A and B, used for foundation work. It includes cross-sectional views (SECTION A-A and SECTION B-B) and side elevation views showing the tapered profile and dimensions.

Cross-Section Details:

- SECTION A-A:** Shows a pile with a top width of 1" (25), a bottom width of A, and a height of B.
- SECTION B-B:** Shows a pile with a top width of 1" (25), a bottom width of A, and a height of B.

Table 1: Dimensions and Weights for SECTION A-A

TYPE	WT.	A	B	C
A	3lbs or 3lbs	1 5/8"	1 3/4"	3 1/2"
		1 5/16"	1 7/8"	3 1/2"
B	4lbs	1 5/8"	1 3/4"	3 1/2"

Table 2: Dimensions and Weights for SECTION B-B

TYPE	kg/m	A	B	C
A	4.5 or 4.5	41	44	89
		33	48	89
B	6.0	41	44	89

Side Elevation Details:

- PILE A:** Shows a tapered pile with a top diameter of 60 - 3/8" (10) DIA. and holes spaced at 1" (25) O.C. The length is indicated as "LENGTH AS REQUIRED". The bottom diameter is 3" (75).
- PILE B:** Shows a tapered pile with a top diameter of 3/8" (10) DIA. and holes spaced at 1" (25) O.C. The length is indicated as "LENGTH AS REQUIRED". The bottom diameter is 3" (75).

Labels:

- TAPER:** Indicated at the bottom of both pile types.
- HOLES 1" (25) O.C.:** Indicated for both pile types.

WASHER $\frac{11}{32}$ " I.D. X $\frac{11}{16}$ " O.D. X $\frac{1}{16}$ " THICK
(9 I.D. X 17 O.D. X 1.6 THICK)

SIGN PANEL

$\frac{5}{16}$ " (8) BOLT
HEX HEAD

SELF LOCKING NUT WITH PLASTIC OR FIBER INSERT

NYLON WASHER
 $\frac{3}{8}$ " I.D. X $\frac{5}{8}$ " O.D. X $\frac{1}{32}$ " THICK
(10 I.D. X 16 O.D. X 0.8 THICK)

BACK-UP PLATE $\frac{1}{8}$ " (3) THICK

WASHER $1\frac{1}{32}$ " I.D. X $1\frac{1}{16}$ " O.D. X $\frac{1}{16}$ " THICK
(9 I.D. X 17 O.D. X 1.6 THICK)

SELF LOCKING NUT WITH PLASTIC OR FIBER INSERT

SIGN PANEL


$\frac{5}{16}$ " (8) BOLT HEX HEAD

NYLON WASHER
 $\frac{3}{8}$ " I.D. X $\frac{5}{8}$ " O.D. X $\frac{1}{32}$ " THICK
(10 I.D. X 16 O.D. X 0.8 THICK)

BACK-UP PLATE $\frac{1}{8}$ " (3) THICK


BOLTS - STAINLESS STEEL CONFORMING TO ASTM F593,
ALLOY GROUP 1 OR 2 (ALLOY TYPES 304 OR 316).
SELF LOCKING NUTS - STAINLESS STEEL CONFORMING TO ASTM F594,
ALLOY GROUP 1 OR 2 (ALLOY TYPES 304 OR 316).
WASHERS - STAINLESS STEEL CONFORMING TO ASTM A240,
(ALLOY TYPES 304 OR 316).

WT./FT. = 1.12 LBS. MIN.
(MASS/m = 1.67 kg/m MIN.)

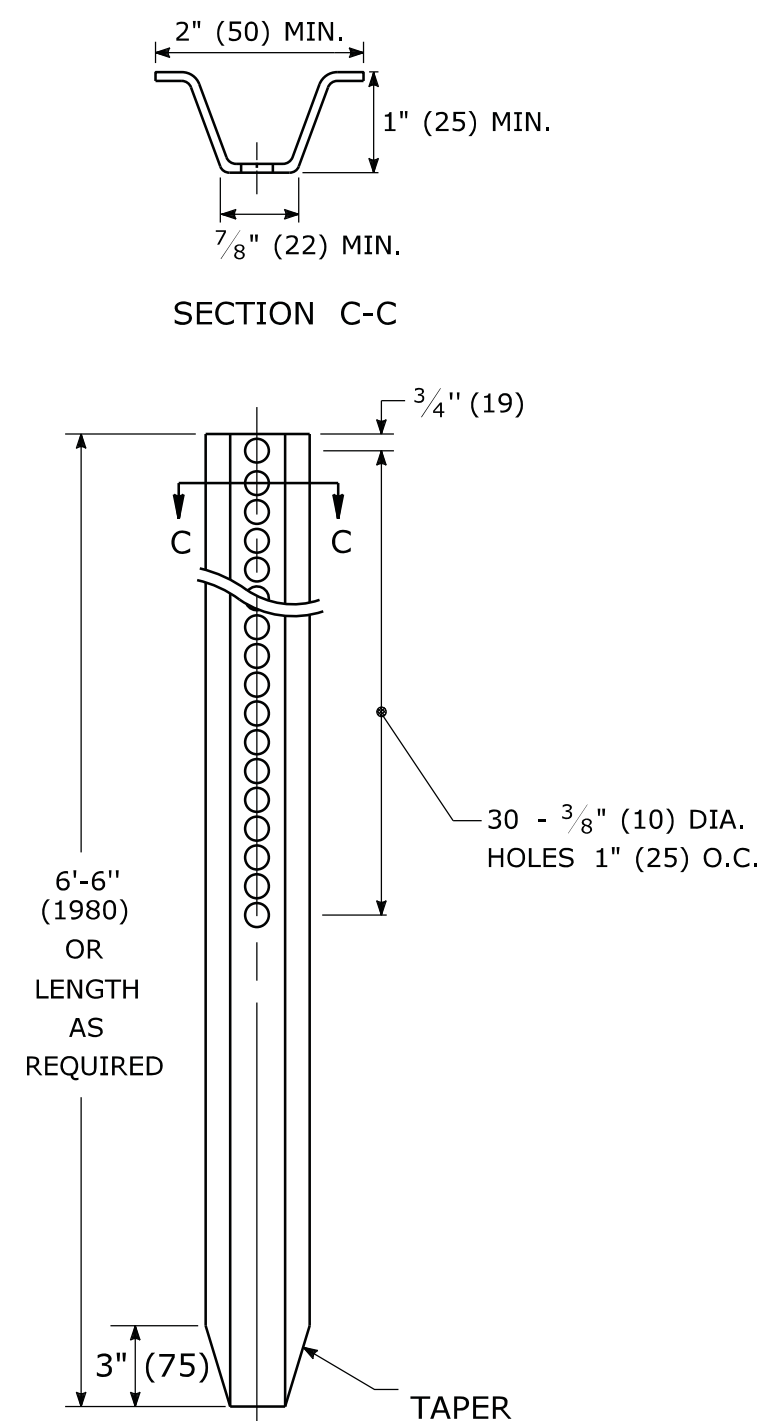


1. STEEL FOR DELINEATOR POSTS SHALL BE ASTM A36/A36(m) STEEL.
STEEL FOR ALL OTHER POSTS SHALL CONFORM TO THE MECHANICAL REQUIREMENTS OF ASTM A 499 GRADE 60 AND TO THE CHEMICAL REQUIREMENTS OF ASTM A1 CARBON STEEL TEE RAIL HAVING NOMINAL WEIGHT (MASS) OF 91lbs. (45 kg.) OR GREATER PER LINEAR YARD (METER).
2. AFTER FABRICATION, ALL STEEL POSTS, STRAPS AND PLATES SHALL BE GALVANIZED TO MEET THE REQUIREMENTS OF ASTM A123/A123(m).
3. WASHERS FOR BREAKAWAY INSTALLATIONS SHALL MEET ASTM F436, TYPE 1.
4. ALL BOLTS, NUTS, AND WASHERS FOR BREAKAWAY INSTALLATIONS SHALL BE GALVANIZED TO MEET THE REQUIREMENTS OF ASTM A153/A153(m).
5. ALL SIGN POSTS SHALL HAVE BREAKAWAY FEATURES THAT MEET AASHTO REQUIREMENTS CONTAINED IN THE CURRENT "STANDARD SPECIFICATIONS FOR STRUCTURAL SUPPORTS FOR HIGHWAY SIGNS, LUMINAIRES AND TRAFFIC SIGNALS." THE BREAKAWAY FEATURES SHALL BE STRUCTURALLY ADEQUATE TO CARRY THE SIGNS SHOWN IN THE PLANS AT 60 mph (97 km/h) WIND LOADINGS. INSTALLATIONS SHALL BE IN ACCORDANCE WITH MANUFACTURERS RECOMMENDATIONS.
6. TYPE A POSTS - 3 lbs/ft (4.5 kg/m) TYPE B POSTS - 4 lbs/ft (6 kg/m).

FOR 3 & 4 LB. POSTS
(FOR 4.5 & 6.0 kg/m POSTS)

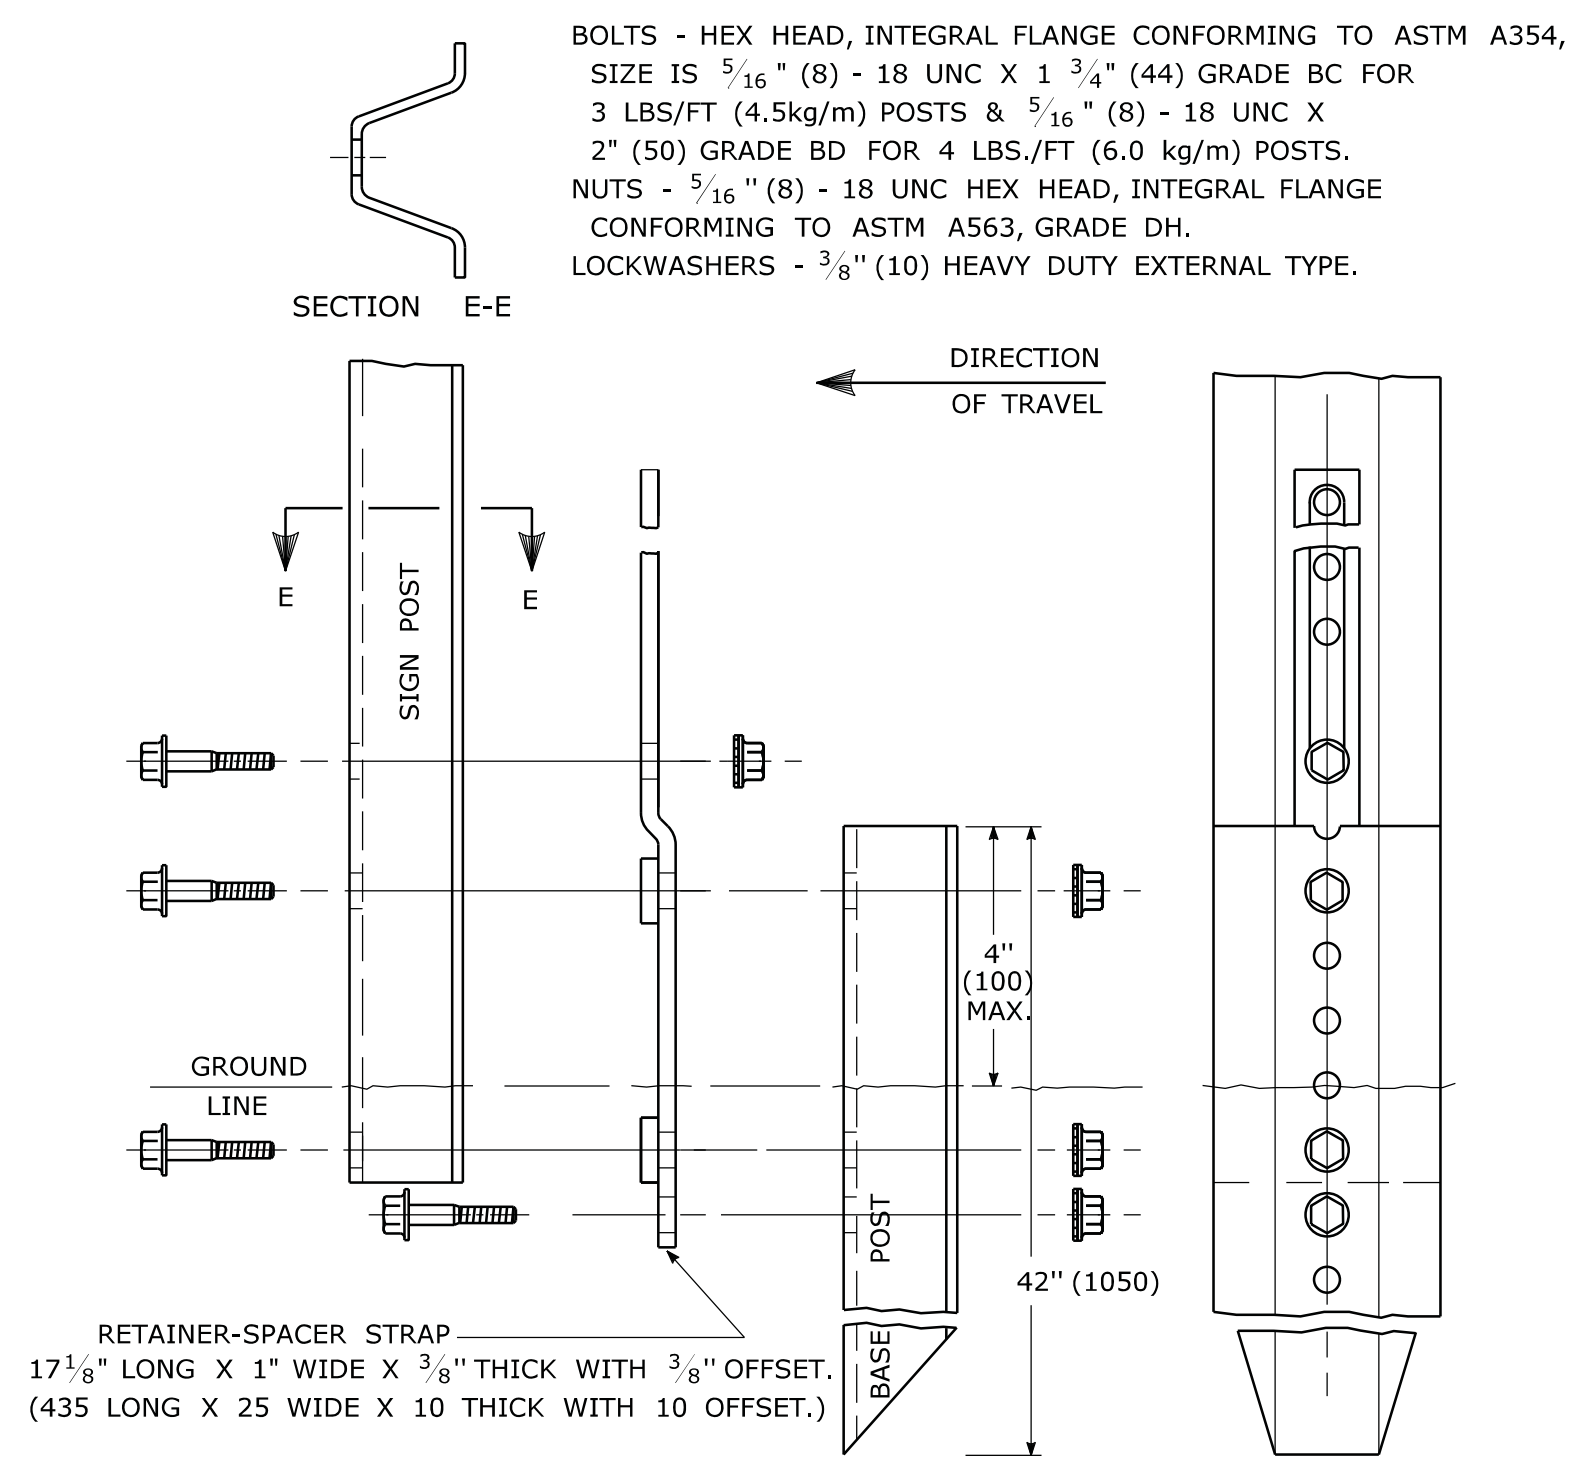

FOR 3 & 4 LB. POSTS
(FOR 4.5 & 6.0 kg/m POSTS)

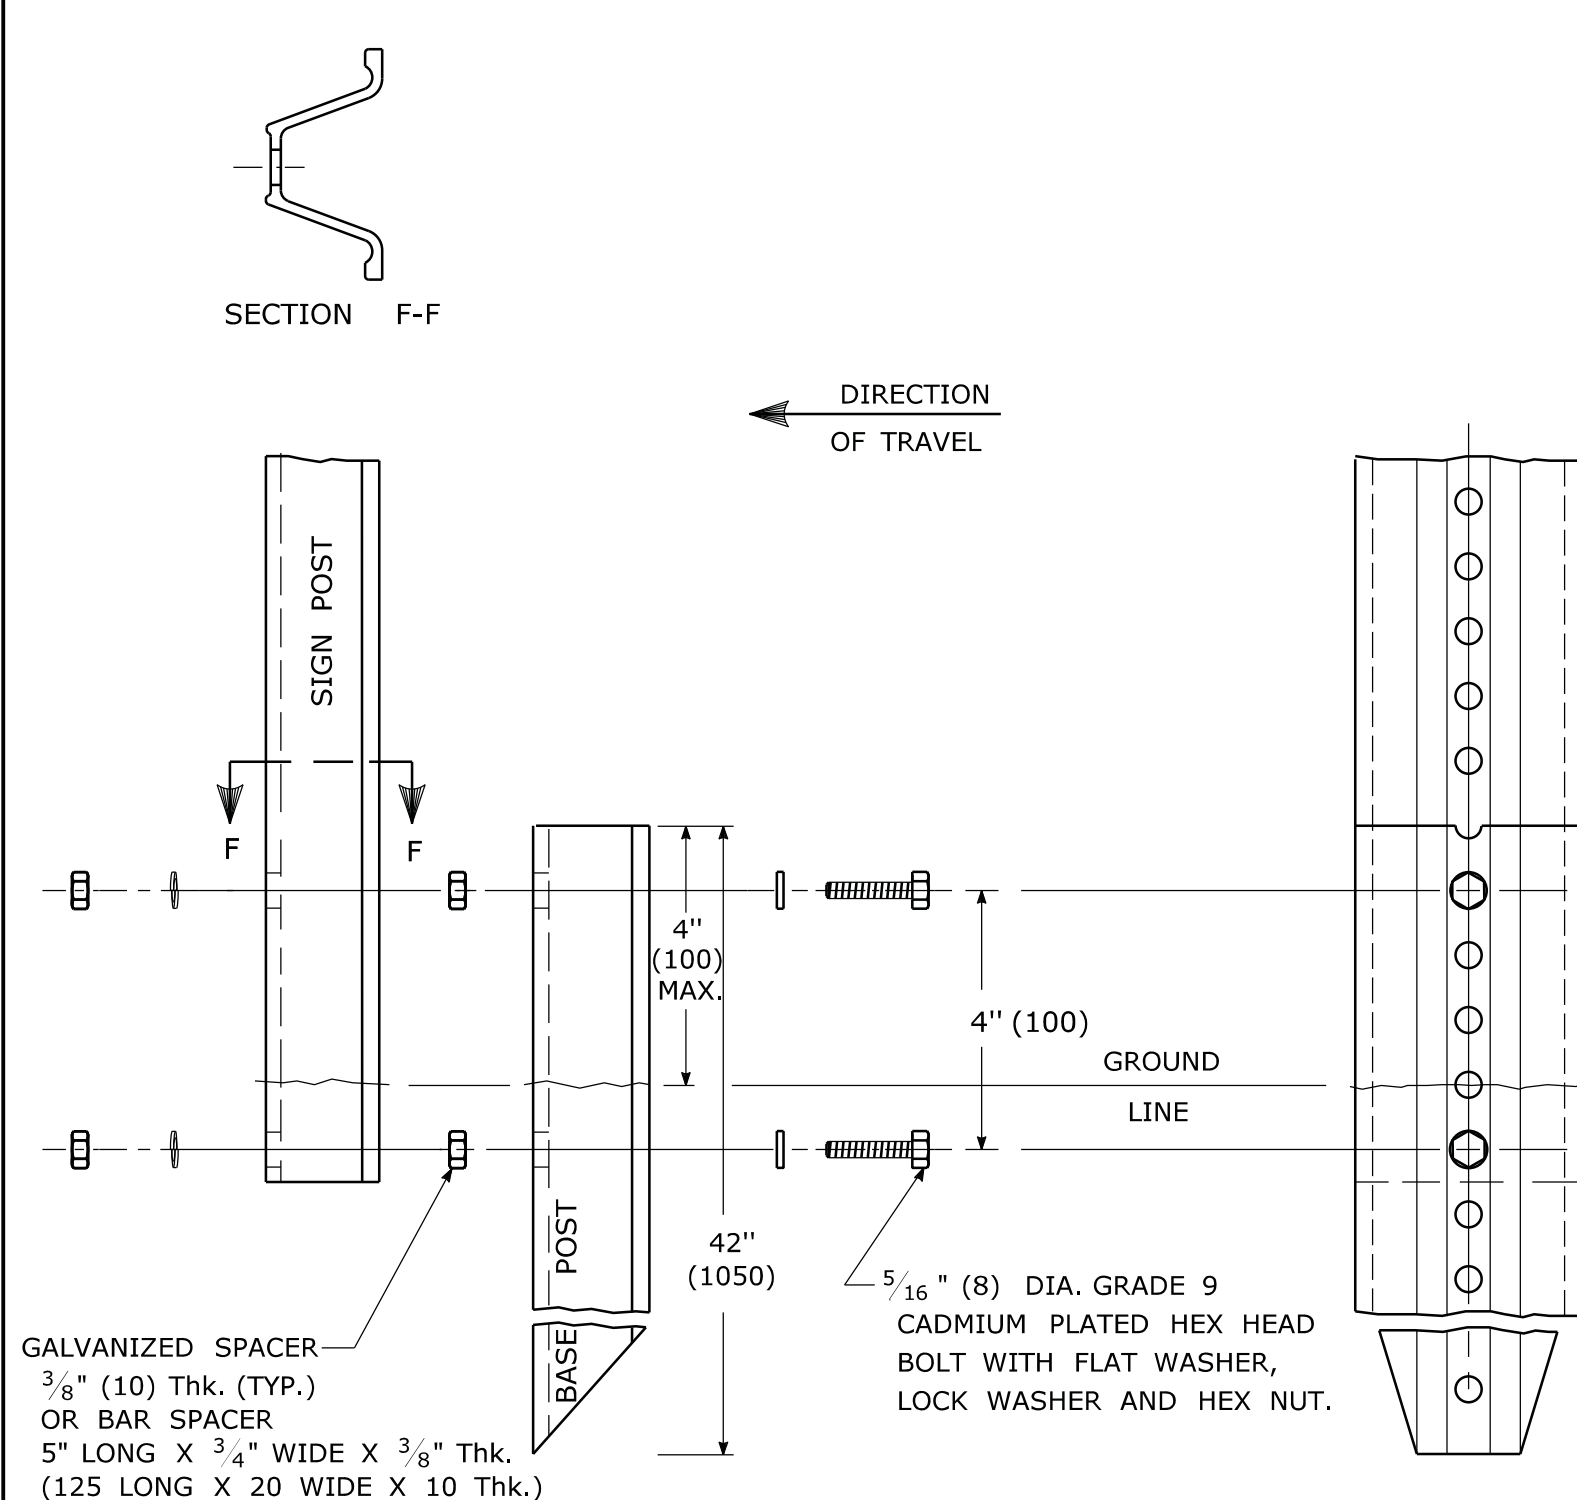

6" (150) POLYVINYL CHLORIDE CONDUIT
SCHEDULE 40 OR 80

G G

BREAKAWAY SIGN POST

DIRECTION OF TRAVEL

BITUMINOUS OR CONCRETE SIDEWALK

PVC

2" (50) LIGHTLY TAMPED COLD PATCH

6" (150)

LIGHTLY COMPACTED FILL

SUB-BASE

Technical drawing of a sign panel assembly, showing front and side views with dimensions and component labels.

Front View Dimensions:

- Overall width: 1" (25)
- Distance from left edge to center hole: $3\frac{1}{8}"$ (79)
- Hole diameter: $\frac{3}{8}"$ (10) DIA. HOLE
- Panel thickness: $\frac{1}{2}"$ (13)

Side View Dimensions:

- Overall length: $6\frac{1}{4}"$ (157)
- Distance from front edge to center hole: 5" (125)
- Distance from back edge to center hole: 5" (125)
- Panel thickness: $\frac{1}{2}"$ (13)

Component Labels:

- SIGN PANEL
- HEX HEAD BOLT
- $\frac{3}{8}"$ (10) DIA. HOLE
- RADIUS SHALL BE AS SMALL AS PRACTICAL
- .080 (2.0) THICK ALUMINUM
- SELF LOCKING NUT WITH PLASTIC OR FIBER INSERT.
- STAINLESS STEEL WASHER
- NYLON WASHER

Washer Dimensions:

- Stainless Steel Washer: $\frac{11}{32}"$ I.D. X $\frac{11}{16}"$ O.D. X $\frac{1}{16}"$ THICK (9 I.D. X 17 O.D. X 1.6 THICK)
- Nylon Washer: $\frac{11}{32}"$ I.D. X $\frac{5}{16}"$ O.D. X $\frac{1}{32}"$ THICK (9 I.D. X 16 O.D. X 0.8 THICK)

Other Dimensions:

- Distance from bottom edge to center hole: $2\frac{1}{2}"$ (63)
- Panel width (side view): 5" (125) TYP.

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1	2-2011	MINOR REVISIONS.			
REV.	DATE	REVISION DESCRIPTION			Plotted Date: 3/22/2011

THE INFORMATION, INCLUDING ESTIMATED QUANTITIES OF WORK, SHOWN ON THESE SHEETS IS BASED ON LIMITED INVESTIGATIONS BY THE STATE AND IS IN NO WAY WARRANTED TO INDICATE THE CONDITIONS OF ACTUAL QUANTITIES OF WORK WHICH WILL BE REQUIRED.

Plotted Date: 3/22/2011

DIMENSIONS ARE IN ENGLISH ("")
& METRIC UNITS (mm).
METRIC DIMENSIONS ARE ROUNDED
- OVER 1" TO NEAREST 5 mm
- UNDER 1" TO NEAREST 1 mm.

NOT TO SCALE



 **STATE OF CONNECTICUT** 
DEPARTMENT OF TRANSPORTATION



Filename: CTDOT_TRAFFIC_STD.dgn

Model: TR-1208_02

SUBMITTED BY:

NAME/DATE/TIME:

APPROVED BY:

NAME/DATE/TIME:

**CTDOT
STANDARD SHEET**










OFFICE OF ENGINEERING

STANDARD SHEET TITLE:





METAL SIGN POSTS AND SIGN MOUNTING DETAILS

STANDARD SHEET NO.:

TR-1208_02

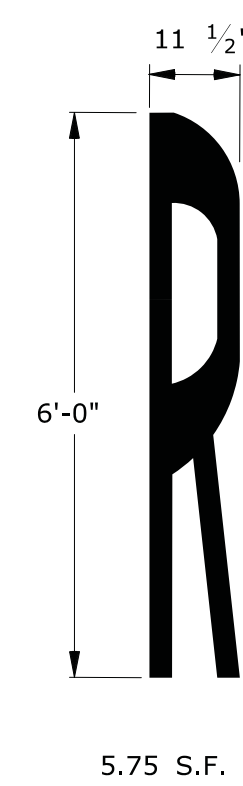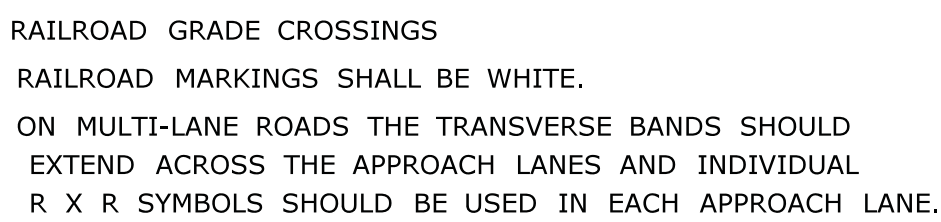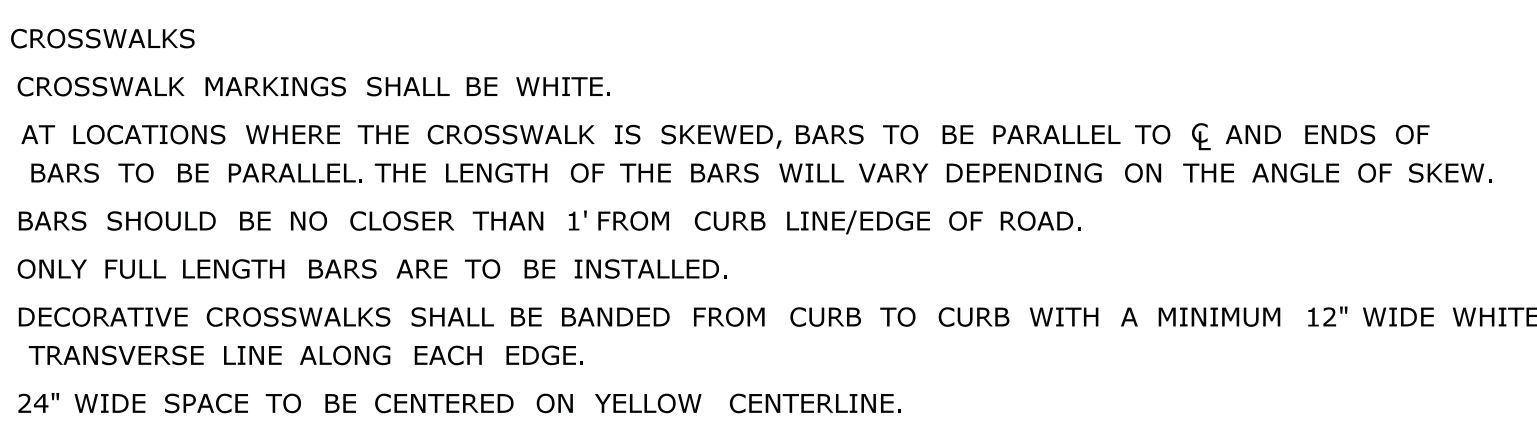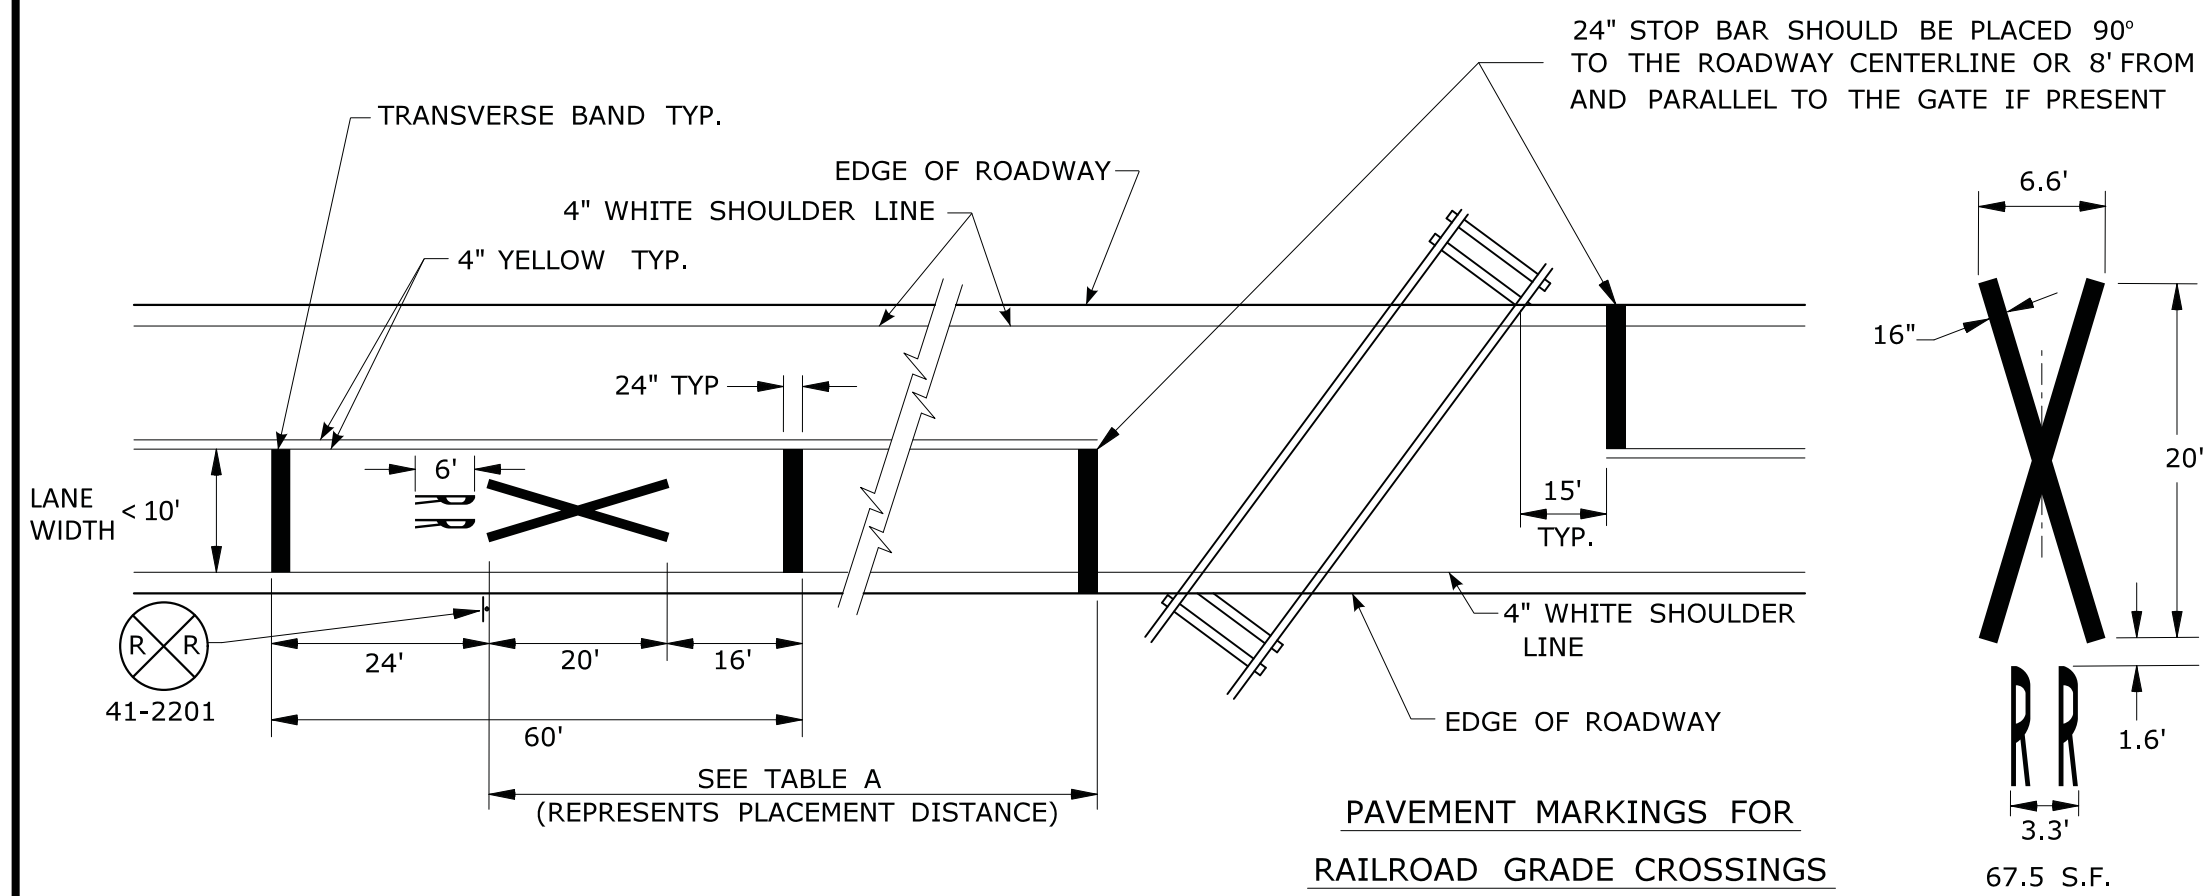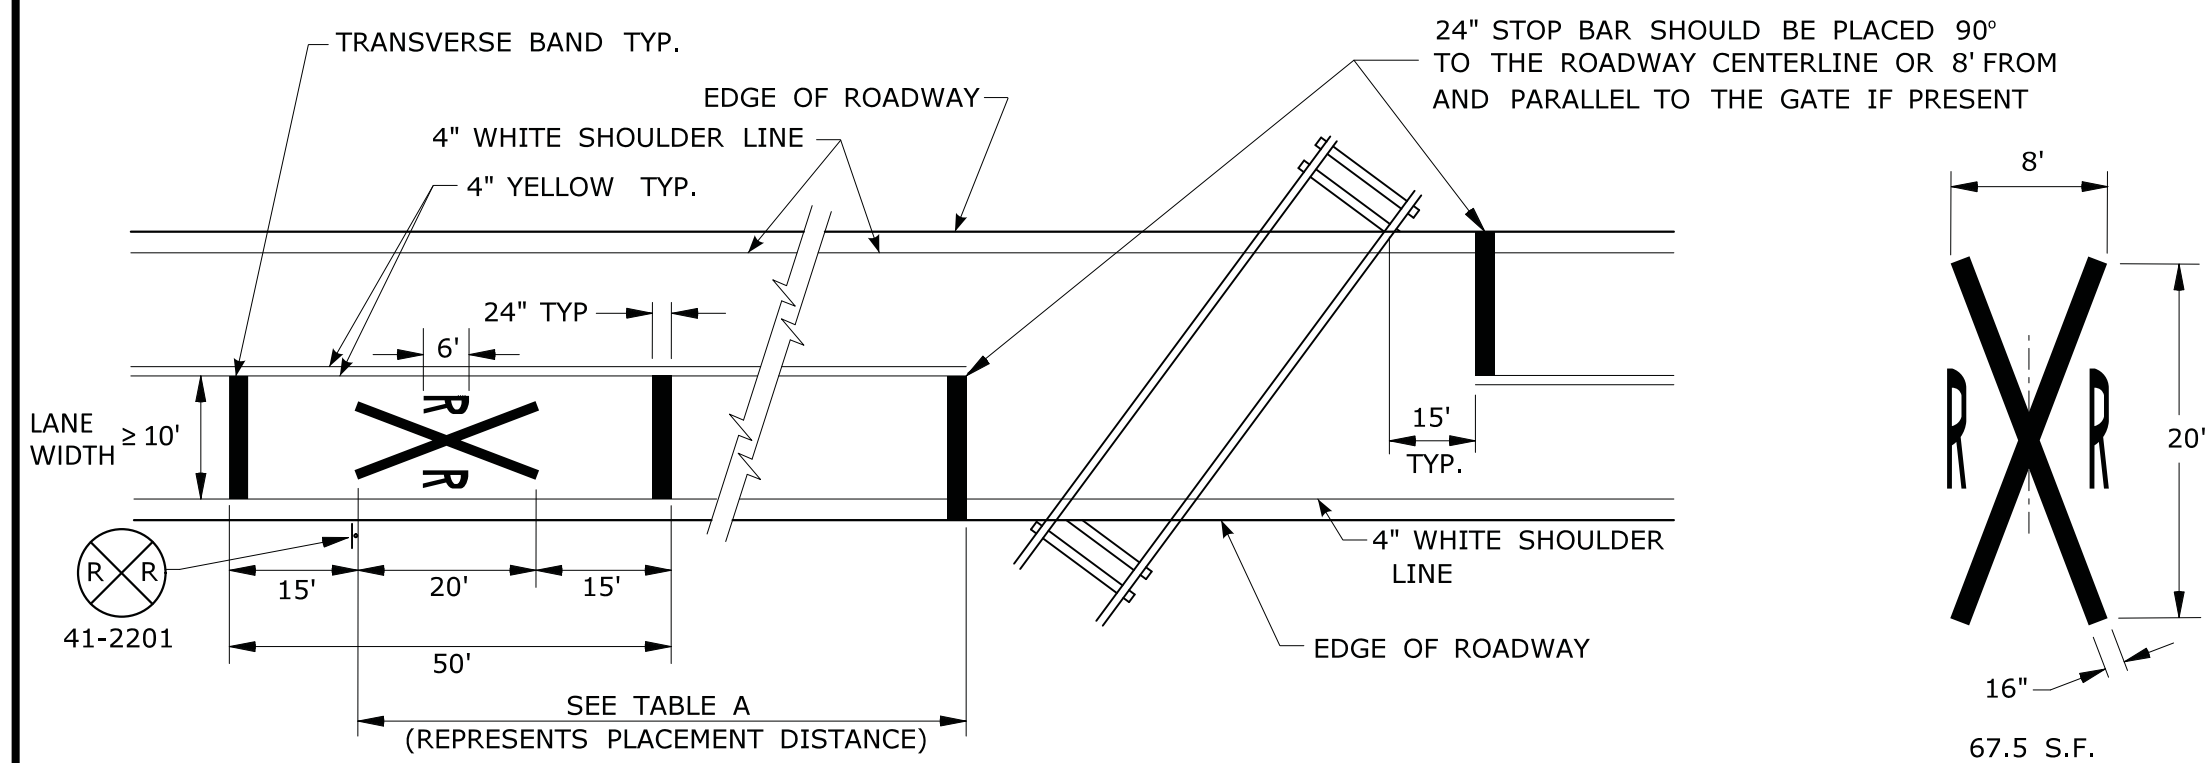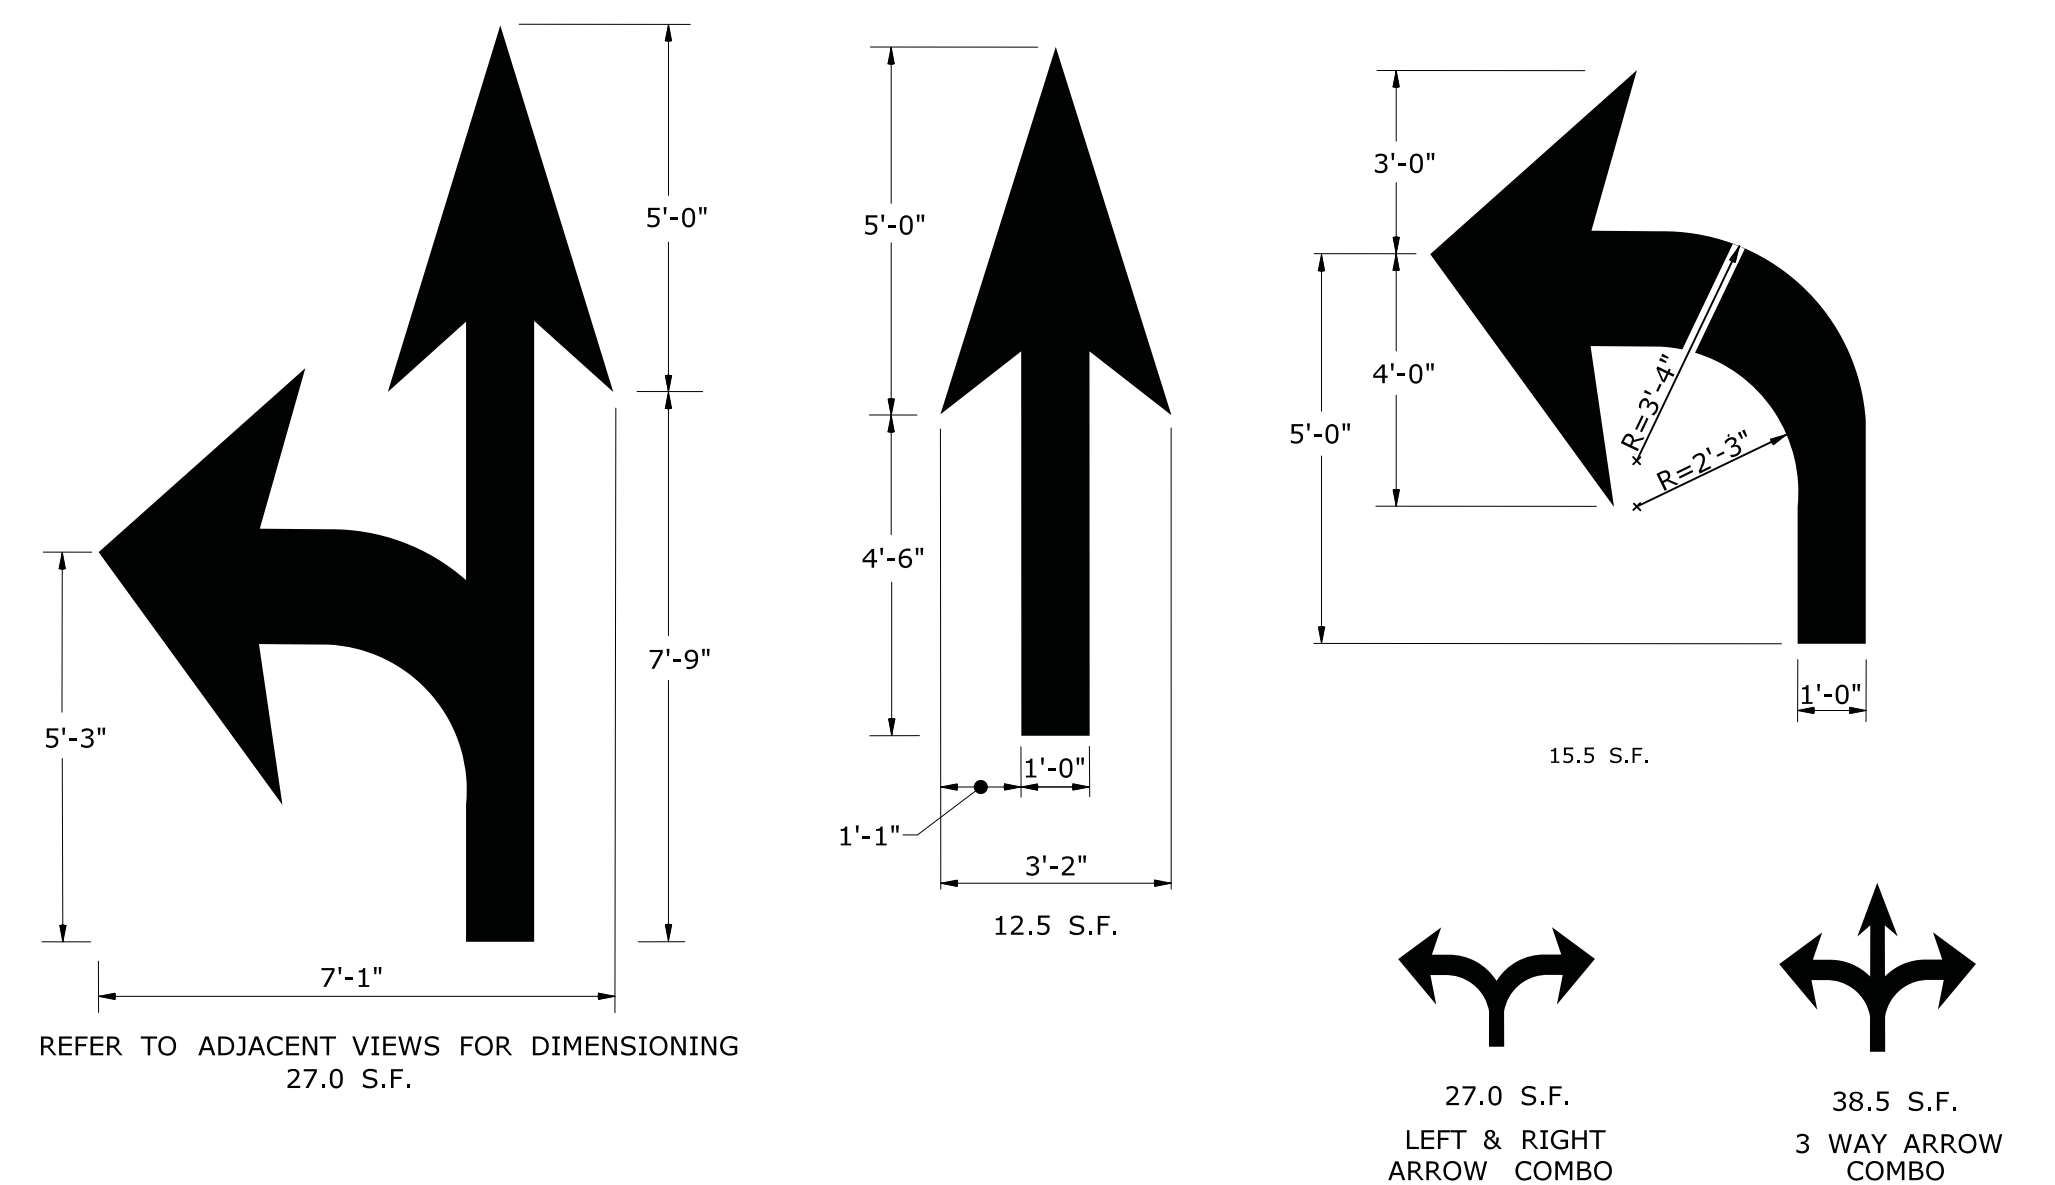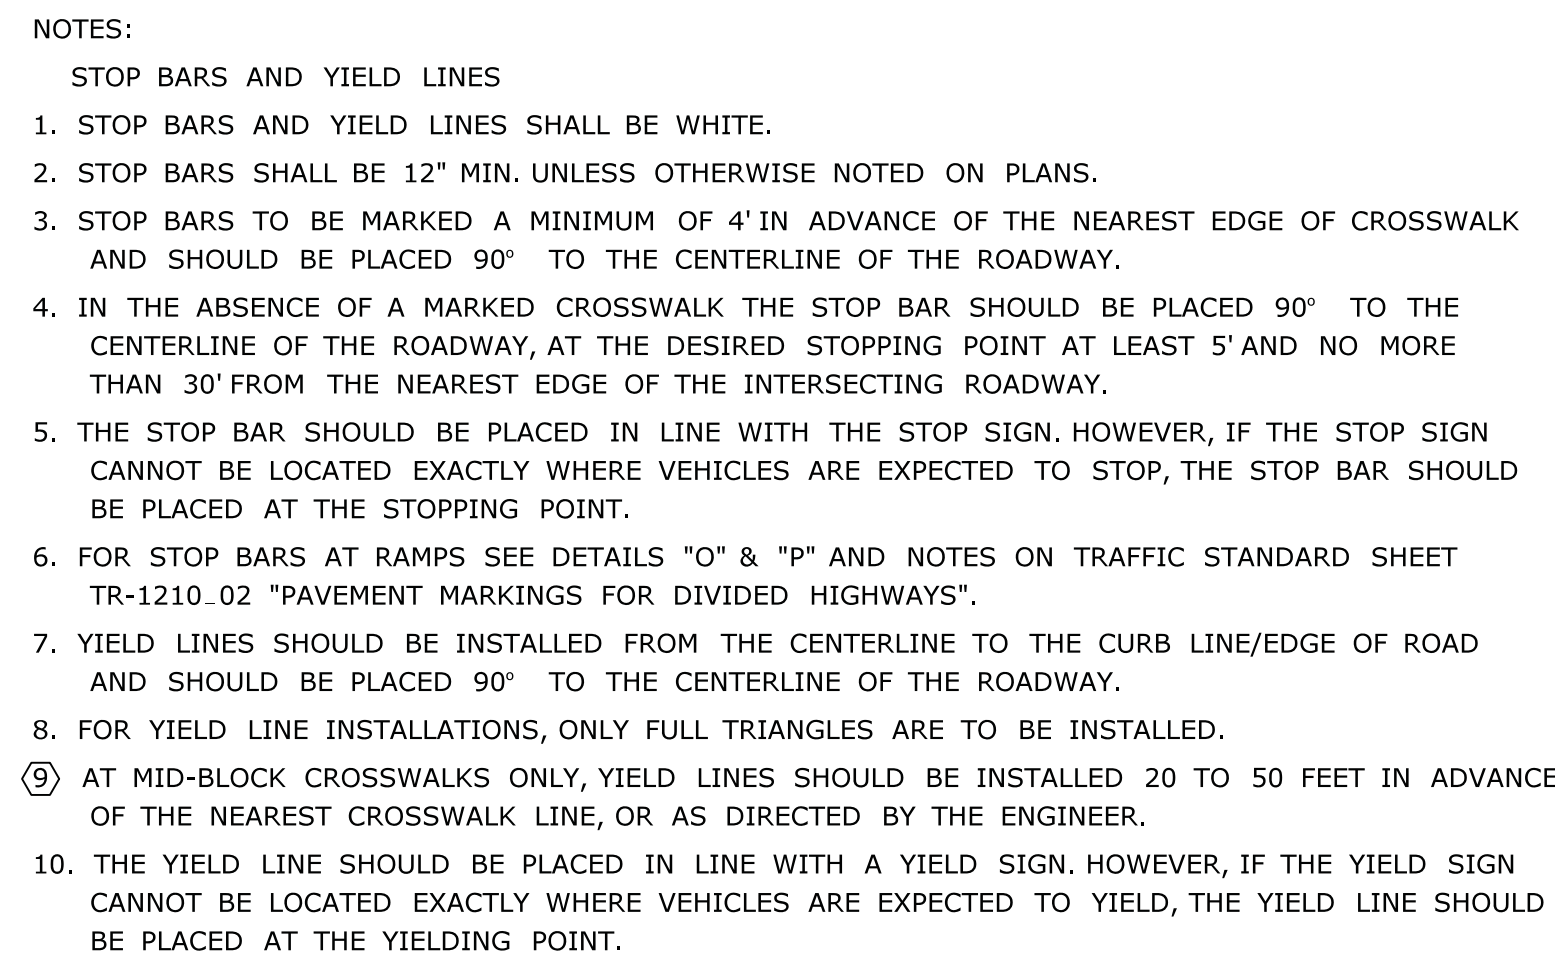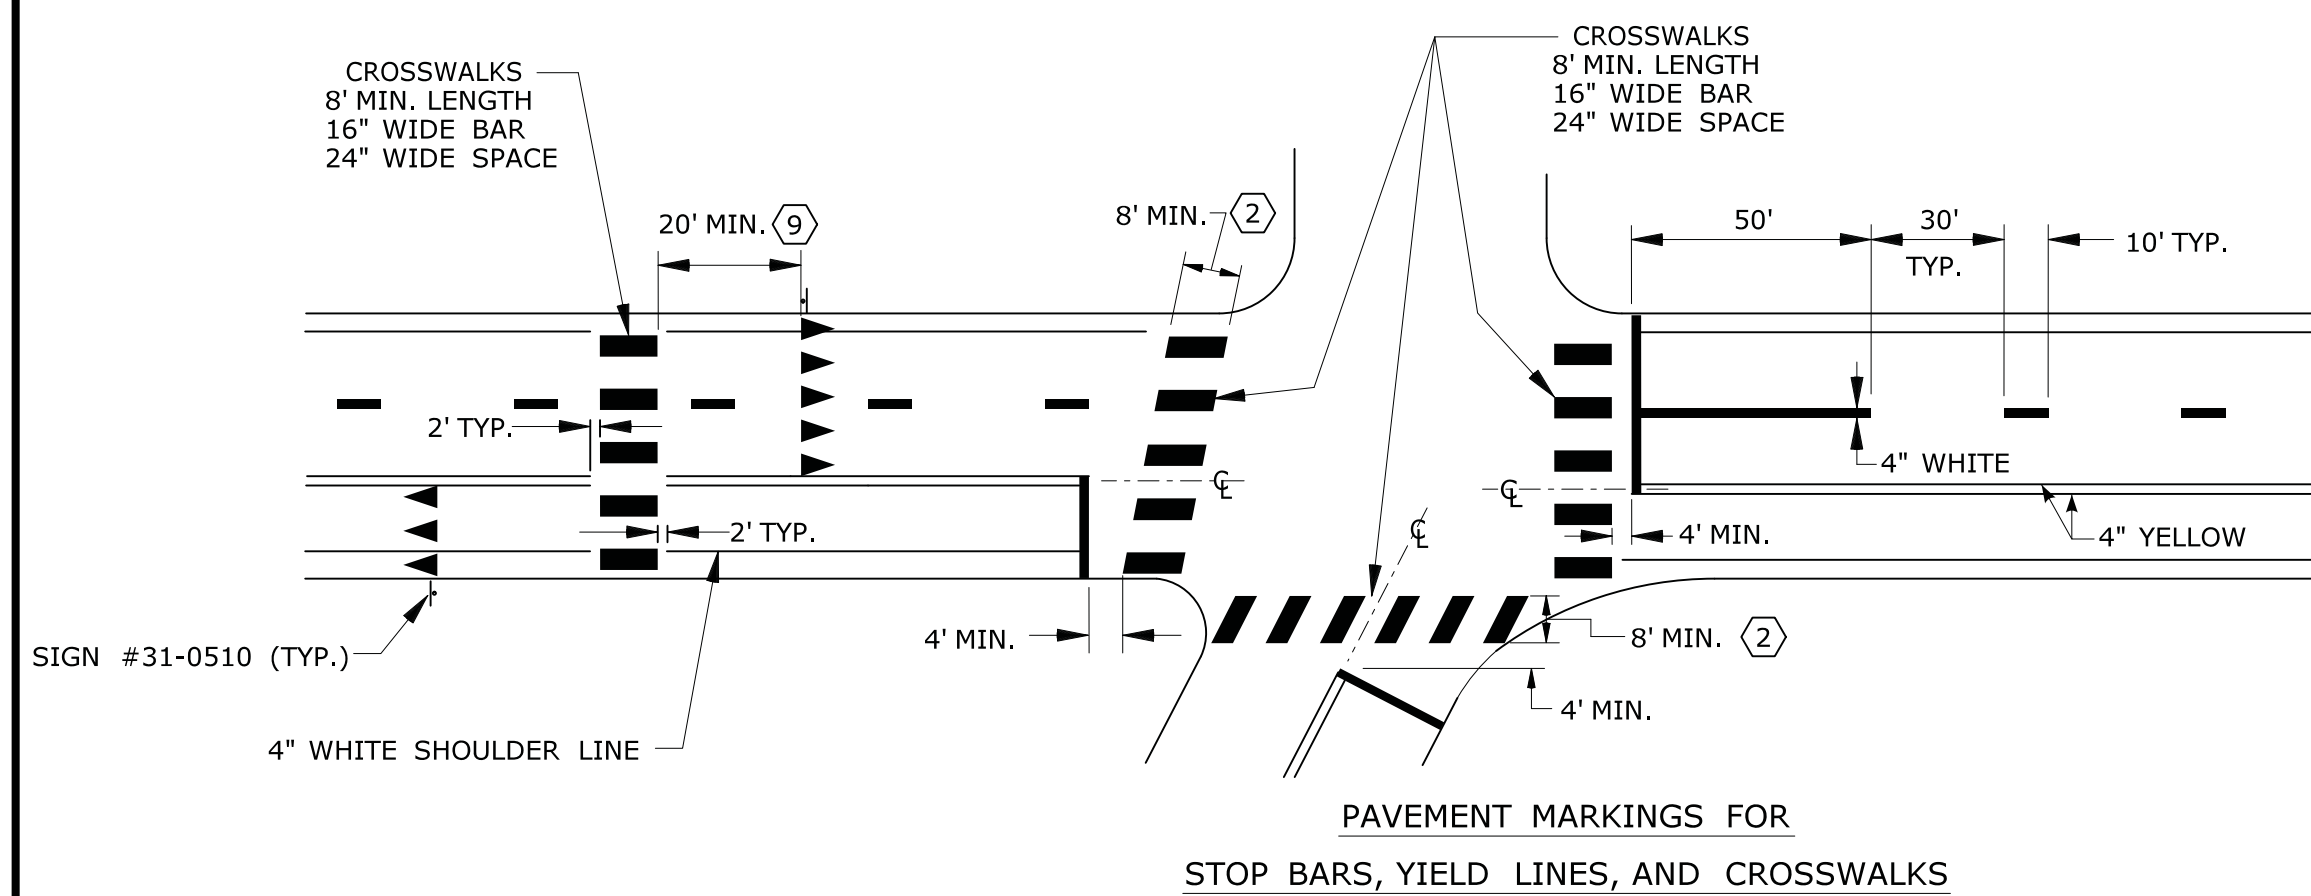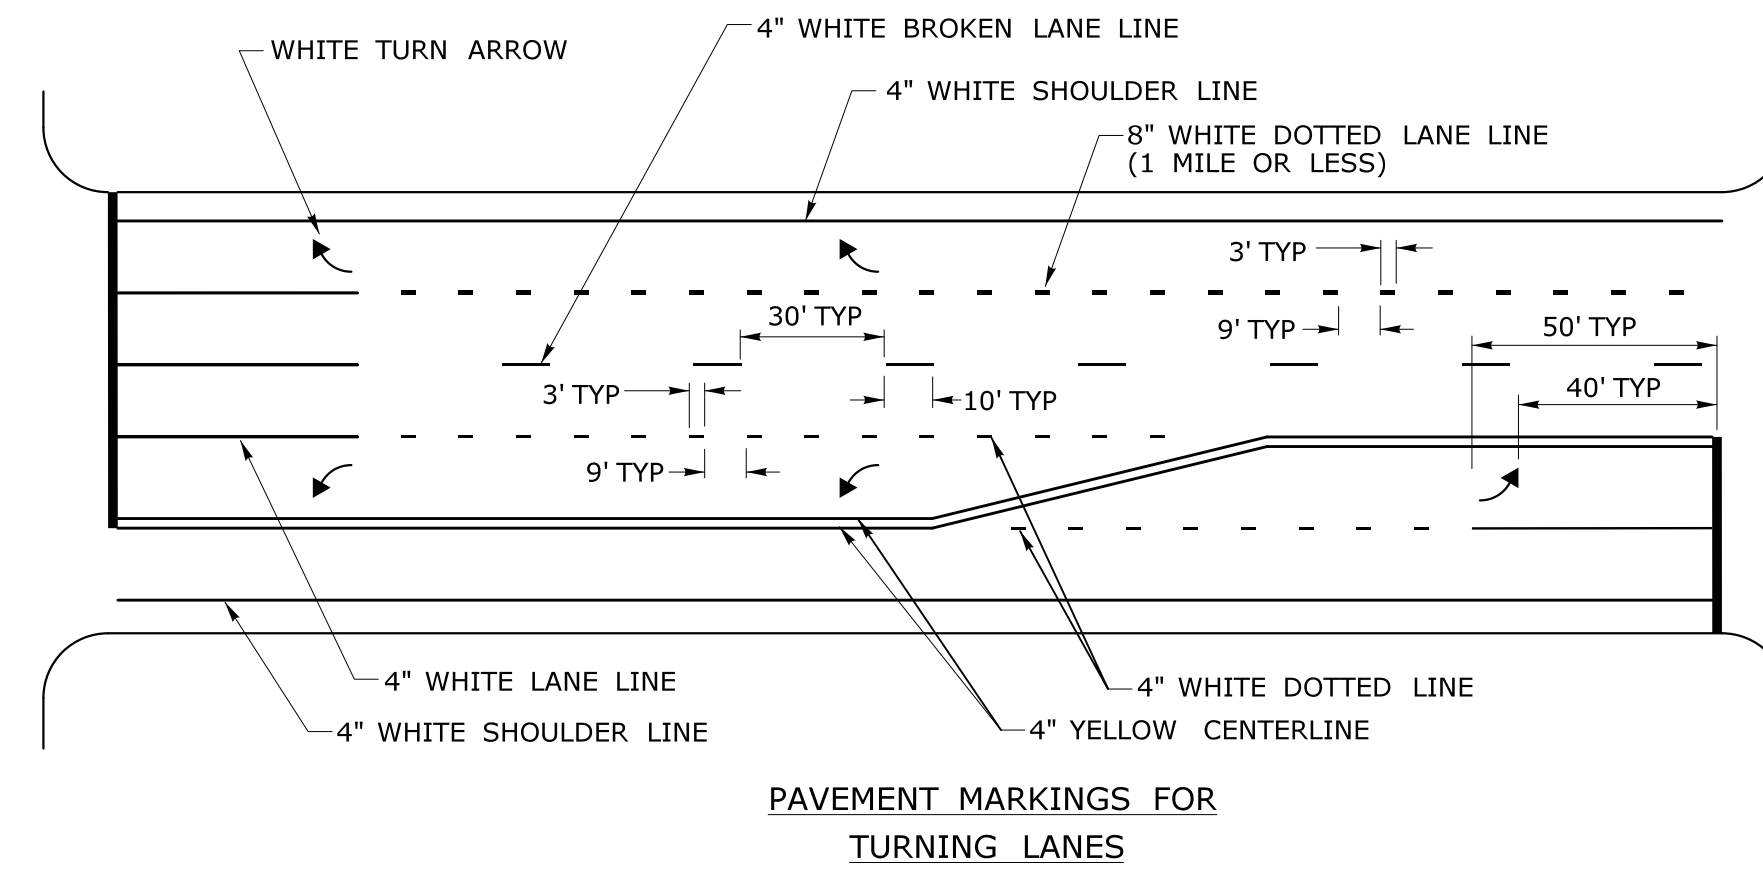

POSTED OR 85 PERCENTILE SPEED M.P.H.	MINIMUM DISTANCE FT.
20	100
25	100
30	100
35	100
40	125
45	175
50	250
55	325
60	400
65	475

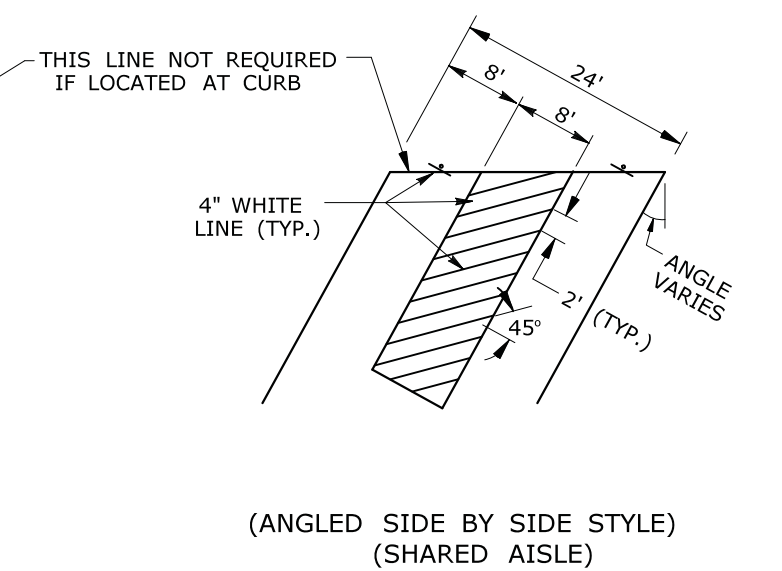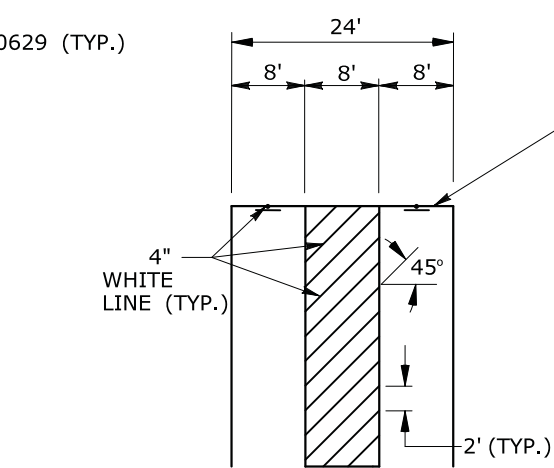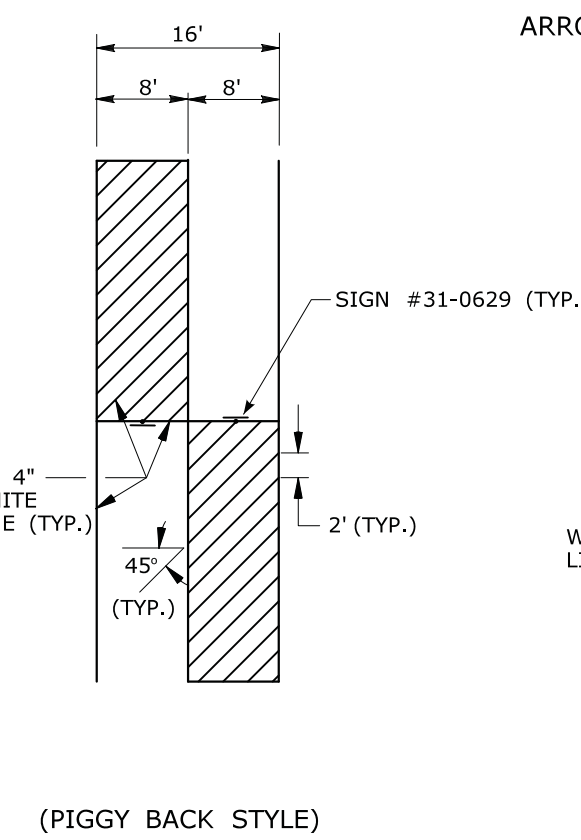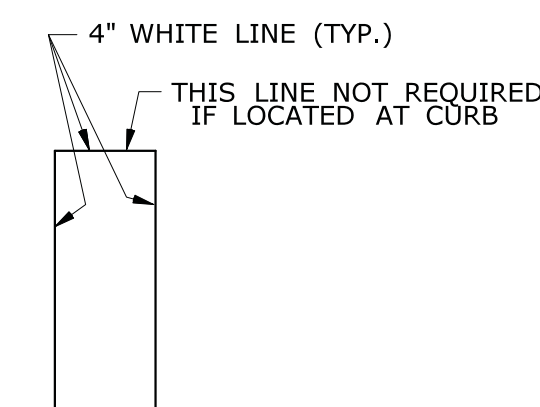


STANDARD
PARKING STALL

NOTES:

PAVEMENT MARKING

1. FOR PAVEMENT MARKINGS ON A CLIMBING LANE SEE DETAIL "L" ON TRAFFIC STANDARD SHEET TR-1210.02 "PAVEMENT MARKINGS FOR DIVIDED HIGHWAYS".
2. AREA OF PAVEMENT MARKINGS AS INDICATED IS APPROXIMATE.
3. FOR PAVEMENT MARKING LINES, STOP BARS AND ARROWS AT RAMPS SEE DETAILS "O" & "P" AND NOTES ON TRAFFIC STANDARD SHEET TR-1210.02 "PAVEMENT MARKINGS FOR DIVIDED HIGHWAYS".
4. RIGHT TURN PAVEMENT MARKINGS ARROWS ARE MIRROR IMAGE OF LEFT TURN PAVEMENT MARKING ARROWS.
5. SHARED AISLES MAY NOT BE USED WHERE CONNECTICUT BUILDING CODE GOVERNS.
6. LANE WIDTHS TO BE 11' UNLESS OTHERWISE NOTED.

3	10-2014	ADDED YIELD LINE DETAIL AND NOTES. REVISED NOTES FOR STOP BARS AND CROSSWALKS. REVISED MARKINGS FOR STOP BARS AND CROSSWALKS. REVISED STANDARD LANE WIDTH. REVISED MARKINGS FOR GRADE CROSSINGS AND TABLE A.	<div>THE INFORMATION, INCLUDING ESTIMATED QUANTITIES OF WORK, SHOWN ON THESE SHEETS IS BASED ON LIMITED INVESTIGATIONS BY THE STATE AND IS IN NO WAY WARRANTED TO INDICATE THE CONDITIONS OF ACTUAL QUANTITIES OF WORK WHICH WILL BE REQUIRED.</div> <div>DIMENSIONS ARE IN ENGLISH ("")</div> <div>NOT TO SCALE</div>	<div><div>STATE OF CONNECTICUT DEPARTMENT OF TRANSPORTATION</div><div>Filename: CTDOT_TRAFFIC_STD.DGN Model: TR-1210_03</div></div>	SUBMITTED BY:	NAME/DATE/TIME:	<div>CTDOT STANDARD SHEET</div> <div>SPECIAL DETAILS AND PAVEMENT MARKINGS FOR TWO-WAY HIGHWAYS</div> <div>OFFICE OF ENGINEERING</div>	STANDARD SHEET TITLE:	STANDARD SHEET NO.:
2	12-2013	REMOVED PAVEMENT MARKING ARROWS ON RAMP'S NOTES AND ADDED NEW NOTE #3 REFERRING TO SHEET TR-1210_02.			APPROVED BY:	NAME/DATE/TIME:		TR-1210_03	
1	2-2011	ADDED PAVEMENT MARKINGS FOR TURNING LANES.							
REV.	DATE	REVISION DESCRIPTION							



NOTES FOR PORTABLE SIGN SUPPORTS:

1. SIGNS AND THEIR PORTABLE SUPPORTS SHALL CONFORM TO THE REQUIREMENTS OF NCHRP REPORT 350 (TL-3) AND THE LATEST EDITION OF THE MUTCD.
2. MOUNTING HEIGHT OF SIGNS SHALL BE A MINIMUM OF 12" (300) AND A MAXIMUM OF 24" (600).
SIGNS SHALL BE MOUNTED HIGHER AS NEEDED TO MEET FIELD CONDITIONS OR AS DIRECTED BY THE ENGINEER.
3. THE ENGINEER RESERVES THE RIGHT TO REJECT ANY SUPPORT DEEMED UNSUITABLE FOR THE PURPOSE INTENDED.
4. PORTABLE SIGN SUPPORTS SHALL BE STABILIZED IN A MANNER THAT WILL NOT AFFECT THEIR COMPLIANCE WITH NCHRP REPORT 350 (TL-3).

* FOR EXIT SIGNS, USE MIN. 72" (1800).



NOTES:

1. TRAFFIC CONES SHALL CONFORM TO THE REQUIREMENTS OF NCHRP
REPORT 350 (TL-3) AND THE LATEST EDITION OF THE MUTCD.
2. IF RUBBER CONES ARE USED, THEY SHALL HAVE INTERIOR RIBS FOR RIGIDITY.
3. IF PLASTIC CONES ARE USED, THEY SHALL BE COLOR IMPREGNATED.
4. THE ENGINEER RESERVES THE RIGHT TO REJECT ANY CONE DEEMED
UNSUITABLE FOR THE PURPOSE INTENDED.



NOTES:

1. CONSTRUCTION BARRICADES SHALL CONFORM TO THE REQUIREMENTS OF NCHRP REPORT 350 (TL-3) AND THE LATEST EDITION OF THE MUTCD.
2. MARKINGS FOR BARRICADE RAILS SHALL BE ALTERNATE ORANGE AND WHITE STRIPES SLOPING DOWNWARD IN THE DIRECTION TRAFFIC IS TO PASS. 6" (150) WIDE STRIPES SHALL BE USED.
3. THE ENTIRE AREA OF ORANGE AND WHITE STRIPES SHALL BE RETROREFLECTIVE SHEETING AS REQUIRED IN THE SPECIFICATIONS. RAILS FOR TYPE I AND TYPE II BARRICADES SHALL BE RETROREFLECTIVE ON BOTH SIDES. WHERE TRAFFIC PASSES ONLY IN ONE DIRECTION OF TRAVEL, ONLY THE SIDE FACING TRAFFIC SHALL BE RETROREFLECTIVE.
4. THE ENGINEER RESERVES THE RIGHT TO REJECT ANY BARRICADE DEEMED UNSUITABLE FOR THE PURPOSE INTENDED.
5. CORNERS OF BARRICADE RAILS SHALL BE ROUNDED.
6. SIGNS MAY ONLY BE INSTALLED ON TYPE III BARRICADES AND SHALL BE PLACED SO AS TO COVER NO MORE THAN ONE BARRICADE RAIL.





NOTES:

SUPPORTS SHALL BE METAL SIGN POSTS AND HAVE BREAK-AWAY FEATURES.
SEE TYPICAL SHEETS:
"TYPICAL SIGN SUPPORT AND SIGN PLACEMENT DETAILS-GORE EXIT SIGN"
"TYPICAL METAL SIGN POSTS AND SIGN MOUNTING DETAILS"



NOTES:

1. TRAFFIC DRUM SHALL CONFORM TO THE REQUIREMENTS OF NCHRP
REPORT 350 (TL-3) AND THE LATEST EDITION OF THE MUTCD.
2. THE ENGINEER RESERVES THE RIGHT TO REJECT ANY DRUM DEEMED
UNSATISFACTORY FOR THE PURPOSE INTENDED.
3. THE ENTIRE AREA OF ORANGE AND WHITE STRIPES SHALL BE RETROREFLECTIVE
SHEETING AS REQUIRED IN THE SPECIFICATIONS.
4. THE SECTIONS OF DRUMS NOT COVERED WITH RETROREFLECTIVE STRIPES
SHALL BE ORANGE.

				THE INFORMATION, INCLUDING ESTIMATED QUANTITIES OF WORK, SHOWN ON THESE SHEETS IS BASED ON LIMITED INVESTIGATIONS BY THE STATE AND IS IN NO WAY WARRANTED TO INDICATE THE CONDITIONS OF ACTUAL QUANTITIES OF WORK WHICH WILL BE REQUIRED.		DIMENSIONS ARE IN ENGLISH ("") & METRIC UNITS (mm). METRIC DIMENSIONS ARE ROUNDED: - OVER 1" TO NEAREST 5 mm. - UNDER 1" TO NEAREST 1 mm.		 STATE OF CONNECTICUT DEPARTMENT OF TRANSPORTATION				SUBMITTED BY: _____ NAME/DATE/TIME: _____ APPROVED BY: _____ NAME/DATE/TIME: _____		CTDOT STANDARD SHEET		STANDARD SHEET TITLE: CONSTRUCTION SIGN SUPPORTS AND CHANNELIZING DEVICES		STANDARD SHEET NO.: TR-1220_02	
1		2-2011		MINOR REVISIONS.		NOT TO SCALE		Plotted Date: 2/16/2011		Filename: CTDOT_TRAFFIC_STD.dgn Model: TR-1220_02		OFFICE OF ENGINEERING							
REV.		DATE		REVISION DESCRIPTION															



SAFETY CONSIDERATIONS

1. DIMENSION "B" IS THE SMALLER OF:
 - A. THE CLEAR DISTANCE BETWEEN THE BOTTOM OF SIGN AND THE FINISHED GRADE.
 - B. THE CLEAR DISTANCE BETWEEN THE BOTTOM OF UPPER POST AND THE FINISHED GRADE.
2. DIMENSION "B" SHALL TYPICALLY BE A MINIMUM OF 7'-0" TO CLEAR AN IMPACTING CAR OR MEDIUM SIZE TRUCK.
3. WHEN DIMENSION "A" WOULD EXCEED 12'-0", CONSIDERATION MAY BE GIVEN TO REDUCING DIMENSION "B" IN ACCORDANCE WITH PROVISIONS OF NOTE 4.
4. DIMENSION "B" MAY BE LESS THAN 7'-0":
 - A. IF THE POST IS OUT OF THE CLEAR ZONE.
 - B. IF THE POST IS WITHIN THE CLEAR ZONE BUT SHIELDED BY AN APPROPRIATE BARRIER SYSTEM.
 - C. IN NO CASE SHALL DIMENSION "B" BE LESS THAN 2'-6".
5. IF FIELD CONDITIONS EXCEED THESE REQUIREMENTS, CONTACT THE ENGINEER FOR DIRECTION.

1. THE HINGE BETWEEN THE UPPER AND LOWER POSTS SHALL BE AT LEAST 7 FT. ABOVE THE GROUND.
2. NO SUPPLEMENTARY SIGNS SHALL BE ATTACHED BELOW THE HINGES.
3. THE POST SPACING SHALL BE 3/5 W EXCEPT AS NOTED BELOW:

<u>UNIT WEIGHT OF POST</u>	<u>POST SPACING REQUIREMENTS</u>
LESS THAN 18 PLF	NO RESTRICTIONS ON POST SPACING **
FROM 18 PLF TO 45 PLF	PROVIDE AT LEAST 7 FT. CLEAR DISTANCE BETWEEN POSTS ***
EXCEEDS 45 PLF	RELOCATE SIGN OUTSIDE OF CLEAR ZONE OR SHIELD SIGN FROM VEHICULAR IMPACT AS DIRECTED BY THE ENGINEER
<p>** IF THE TOTAL COMBINED WEIGHT OF ONE LOWER POST AND TWO BRACKETS EXCEEDS 600 LBS OR THE COMBINED WEIGHT OF TWO POSTS AND FOUR BRACKETS LOCATED WITHIN A CLEAR DISTANCE OF 7 FT OF EACH OTHER EXCEEDS 600 LBS, THE SIGN SHALL BE RELOCATED OUTSIDE OF THE CLEAR ZONE OR SHALL BE PROPERLY SHIELDED FROM VEHICULAR IMPACT AS DIRECTED BY THE ENGINEER. SEE "TABLE 1 - BRACKET DATA" ON BSM-5 FOR BRACKET WEIGHT.</p>	
<p>*** IF THE REQUIRED CLEAR DISTANCE CANNOT BE ATTAINED, THE ENGINEER MAY DIRECT THAT THE SIGN BE RELOCATED OUTSIDE THE CLEAR ZONE OR THAT IT BE PROPERLY SHIELDED FROM VEHICULAR IMPACT.</p>	

1. DETERMINE THE REQUIRED SIGN DIMENSIONS AND POST HEIGHTS
(SEE "TYPICAL POST MOUNTED SIGN" DETAIL, THIS SHEET).

- W = SIGN WIDTH (HORIZONTAL DIMENSION)
H = SIGN HEIGHT (VERTICAL DIMENSION) (ADD CROWN HEIGHT WHEN APPLICABLE)
L = POST HEIGHT (THE DISTANCE BETWEEN THE TOP OF THE FOUNDATION
AND THE BOTTOM OF THE SIGN MEASURED AT THE TALLER POST)

2. ENTER "POST SELECTION TABLE 1 AND 2" ON DWG BSM-2 AND BSM-3 WITH THE DESIRED VALUES OF W, H, AND L. ROUND UP TO THE NEAREST VALUES IN THE TABLE. READ THE CORRESPONDING POST SIZE AND BRACKET NUMBER. REFER TO DWG BSM-5 FOR BRACKET TYPE AND BSM-6 FOR TYPICAL HINGE REQUIREMENTS.

EXAMPLE: $W = 8'$, $L = 10'$, $H = 14'$

ENTER "POST SELECTION TABLE 1" ON DWG BSM-2 SINCE TABLE 1 IS APPLICABLE FOR
SIGN WIDTH $\leq 15'$. LOCATE THE FOLLOWING CELL:

IF "S" APPEARS
HINGE SHIM IS REQUIRED
(SEE DWG BSM-6)

POST SIZE

W6 x 20 #1S

BRACKET NUMBER
(SEE DWG BSM-5)

1. UPPER SIGN POSTS SHALL EXTEND TO THE TOP OF FULL WIDTH SIGN PANEL OR THE TOP OF CROWN,WHICHEVER IS HIGHER.
2. FOR SIGN OR CROWN PANEL RETROFIT,THE EXISTING SIGN POSTS SHALL BE REPLACED WITH NEW POSTS OR EXTENDED WITH ADDITIONAL SECTIONS USING HINGE ASSEMBLIES. REFER TO TRAFFIC TYPICAL SHEETS "EXTRUDED SIGN PANEL - RETROFIT DETAIL".


FOR METRIC PROJECTS:

1. DETERMINE US CUSTOMARY POST SIZE FROM THE POST SELECTION TABLE.
2. CALCULATE THE WEIGHT OF POSTS IN US CUSTOMARY UNITS (CWT) THEN USE THE FOLLOWING CONVERSION FACTOR TO CONVERT CWT TO KILOGRAMS.

1 CWT = 45.36 KG

EXAMPLE: 120 CWT x 45.36 KG/CWT = 5443 KG

TABLE OF CONTENT	
DWG. NO.	DESCRIPTION
BSM-1	GENERAL NOTES
BSM-2	POST SELECTION TABLE 1 ($W \leq 15$ FT.)
BSM-3	POST SELECTION TABLE 2 ($W > 15$ FT.)
BSM-4	FOUNDATION DETAILS
BSM-5	BRACKET DETAILS
BSM-6	HINGE DETAILS

	-	-	-	-	-	THE INFORMATION, INCLUDING ESTIMATED QUANTITIES OF WORK, SHOWN ON THESE SHEETS IS BASED ON LIMITED INVESTIGATIONS BY THE STATE AND IS IN NO WAY WARRANTED TO INDICATE THE CONDITIONS OR ACTUAL QUANTITIES OF WORK WHICH WILL BE REQUIRED.	DESIGNER/DRAFTER: BKC	 STATE OF CONNECTICUT DEPARTMENT OF TRANSPORTATION	SIGNATURE/ BLOCK:	OFFICE OF ENGINEERING	PROJECT TITLE: <
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POST SELECTION TABLE 1

W	L	H (Sign Height + Crown Height)																			
		4 ft	5 ft	6 ft	7 ft	8 ft	9 ft	10 ft	11 ft	12 ft	13 ft	14 ft	15 ft	16 ft	17 ft	18 ft	19 ft	20 ft	21 ft	22 ft	
8 ft	7 ft	W6 x 9 #3	W6 x 9 #3	W6 x 9 #2	W6 x 9 #2	W6 x 9 #2	W6 x 12 #2	W6 x 12 #2	W6 x 12 #2	W6 x 15 #2	W6 x 15 #1	W6 x 15 #1S	W6 x 16 #1S	W8 x 18 #2S	W8 x 21 #1S	W10 x 22 #2	W10 x 22 #2	W10 x 26 #2	W10 x 26 #1S	W10 x 26 #1S	
	8 ft	W6 x 9 #2	W6 x 9 #2	W6 x 9 #2	W6 x 9 #2	W6 x 9 #2	W6 x 12 #2	W6 x 12 #2	W6 x 12 #2	W6 x 15 #1	W6 x 15 #1	W6 x 15 #1	W8 x 18 #1	W8 x 21 #1S	W8 x 21 #1S	W10 x 22 #2	W10 x 26 #1	W10 x 26 #1	W10 x 26 #1S	W10 x 30 #1S	
	9 ft	W6 x 9 #2	W6 x 9 #2	W6 x 9 #2	W6 x 12 #2	W6 x 9 #2	W6 x 12 #2	W6 x 12 #2	W6 x 15 #1	W6 x 15 #1	W6 x 15 #1	W6 x 15 #1	W8 x 18 #1	W6 x 20 #1S	W8 x 21 #1S	W10 x 26 #1	W10 x 26 #1	W10 x 26 #1	W10 x 30 #1S	W12 x 30 #1	
	10 ft	W6 x 9 #2	W6 x 9 #2	W6 x 12 #2	W6 x 12 #2	W6 x 12 #1	W6 x 12 #1	W6 x 15 #1	W6 x 15 #1	W6 x 15 #1	W6 x 15 #1	W6 x 15 #1	W8 x 18 #1	W6 x 20 #1	W6 x 20 #1S	W8 x 21 #1	-	-	-	-	
	11 ft	W6 x 9 #2	W6 x 9 #2	W6 x 9 #2	W6 x 12 #1	W6 x 12 #1	W6 x 12 #1	W6 x 15 #1	W6 x 15 #1	W6 x 15 #1	W6 x 15 #1	W6 x 15 #1	W8 x 18 #1	W6 x 20 #1	W6 x 20 #1S	-	-	-	-	-	
	12 ft	W6 x 9 #2	W6 x 12 #1	W6 x 12 #1	W6 x 12 #1	W6 x 15 #1	W6 x 15 #1	W6 x 15 #1	W6 x 15 #1	W6 x 15 #1	W6 x 15 #1	W6 x 20 #1	W6 x 20 #1	W6 x 20 #1	W6 x 20 #1S	-	-	-	-	-	
	13 ft	W6 x 12 #1	W6 x 12 #1	W6 x 12 #1	W6 x 12 #1	W6 x 15 #1	W6 x 15 #1	W6 x 15 #1	W6 x 15 #1	W8 x 18 #1	W8 x 18 #1	W6 x 20 #1	W6 x 20 #1	W6 x 20 #1	-	-	-	-	-	-	
	14 ft	W6 x 12 #1	W6 x 12 #1	W6 x 15 #1	W6 x 15 #1	W6 x 15 #1	W6 x 15 #1	W6 x 15 #1	W6 x 16 #1	W8 x 18 #1	W6 x 20 #1	W6 x 20 #1	W6 x 20 #1	-	-	-	-	-	-	-	
	15 ft	W6 x 12 #1	W6 x 15 #1	W6 x 15 #1	W6 x 15 #1	W6 x 15 #1	W6 x 15 #1	W6 x 15 #1	W6 x 15 #1	W8 x 18 #1	-	-	-	-	-	-	-	-	-	-	
9 ft	16 ft	W6 x 12 #1	W6 x 15 #1	W6 x 15 #1	W6 x 15 #1	W6 x 15 #1	-	-	-	-	-	-	-	-	-	-	-	-	-	-	
	7 ft	W6 x 9 #3	W6 x 9 #3	W6 x 9 #2	W6 x 9 #2	W6 x 9 #2	W8 x 10 #2	W6 x 12 #2	W6 x 12 #2	W6 x 15 #2	W6 x 15 #2	W6 x 15 #1S	W6 x 16 #1S	W8 x 18 #2S	W8 x 21 #2S	W10 x 22 #2	W10 x 22 #2	W10 x 26 #2	W10 x 26 #1S	W10 x 26 #2S	
	8 ft	W6 x 9 #2	W6 x 9 #2	W6 x 9 #2	W6 x 9 #2	W6 x 9 #2	W8 x 10 #2	W6 x 12 #2	W6 x 12 #2	W6 x 15 #2	W6 x 15 #2	W6 x 15 #1	W6 x 15 #1S	W8 x 18 #2	W8 x 21 #2S	W10 x 22 #2	W10 x 26 #2	W10 x 26 #2	W10 x 26 #1	W10 x 30 #2S	
	9 ft	W6 x 9 #2	W6 x 9 #2	W6 x 9 #2	W6 x 9 #2	W6 x 9 #2	W6 x 12 #2	W6 x 12 #2	W6 x 12 #2	W6 x 15 #1	W6 x 15 #1	W6 x 15 #1	W8 x 18 #2	W6 x 20 #1S	W8 x 21 #1S	W10 x 26 #2	W10 x 26 #2	W10 x 26 #1	W10 x 30 #1S	W12 x 30 #2	
	10 ft	W6 x 9 #2	W6 x 9 #2	W6 x 9 #2	W6 x 12 #2	W6 x 9 #2	W6 x 12 #2	W6 x 12 #2	W6 x 15 #1	W6 x 15 #1	W6 x 15 #1	W6 x 15 #1	W8 x 18 #1	W6 x 20 #1S	W8 x 21 #1S	W10 x 26 #1	W10 x 26 #1	W10 x 26 #1	W10 x 30 #1S	W12 x 30 #2	
	11 ft	W6 x 9 #2	W6 x 12 #2	W6 x 12 #1	W6 x 12 #1	W6 x 12 #1	W6 x 15 #1	W6 x 15 #1	W6 x 15 #1	W6 x 15 #1	W6 x 15 #1	W6 x 15 #1	W8 x 18 #1	W6 x 20 #1	W6 x 20 #1S	W8 x 21 #1	-	-	-	-	
	12 ft	W6 x 9 #2	W6 x 12 #1	W6 x 12 #1	W6 x 12 #1	W6 x 15 #1	W6 x 15 #1	W6 x 15 #1	W6 x 15 #1	W8 x 18 #1	W8 x 18 #1	W6 x 20 #1	W6 x 20 #1	W6 x 20 #1	W6 x 20 #1S	-	-	-	-	-	
	13 ft	W6 x 12 #1	W6 x 12 #1	W6 x 15 #1	W6 x 15 #1	W6 x 15 #1	W6 x 15 #1	W6 x 15 #1	W6 x 16 #1	W8 x 18 #1	W6 x 20 #1	W6 x 20 #1	W6 x 20 #1	W6 x 20 #1	-	-	-	-	-	-	
	14 ft	W6 x 12 #1	W6 x 12 #1	W6 x 15 #1	W6 x 15 #1	W6 x 15 #1	W6 x 15 #1	W6 x 15 #1	W8 x 18 #1	W6 x 20 #1	W6 x 20 #1	W6 x 20 #1	W6 x 20 #1	-	-	-	-	-	-	-	
10 ft	15 ft	W6 x 12 #1	W6 x 15 #1	W6 x 15 #1	W6 x 15 #1	W6 x 15 #1	W6 x 15 #1	W6 x 15 #1	W8 x 18 #1	-	-	-	-	-	-	-	-	-	-	-	
	16 ft	W6 x 15 #1	W6 x 15 #1	W6 x 15 #1	-	-	-	-	-	-	-	-	-	-	-	-	-	-	-	-	
	7 ft	W6 x 9 #3	W6 x 9 #3	W6 x 9 #2	W6 x 9 #2	W6 x 9 #2	W6 x 12 #2	W6 x 12 #2	W6 x 12 #2	W6 x 15 #2	W6 x 15 #2	W6 x 15 #1S	W6 x 16 #1S	W8 x 18 #2	W8 x 18 #2S	W10 x 22 #2	W10 x 22 #2	W10 x 26 #2	W10 x 26 #2S	W12 x 30 #2S	
	8 ft	W6 x 9 #2	W6 x 9 #2	W6 x 9 #2	W6 x 12 #2	W6 x 9 #2	W6 x 12 #2	W6 x 12 #2	W6 x 15 #2	W6 x 15 #2	W6 x 15 #1	W6 x 15 #1	W8 x 18 #2	W6 x 20 #1S	W8 x 21 #1S	W10 x 26 #2	W10 x 26 #2	W10 x 26 #1	W10 x 30 #2	W14 x 30 #2	
	9 ft	W6 x 9 #2	W6 x 9 #2	W6 x 9 #2	W6 x 12 #2	W6 x 9 #2	W6 x 12 #2	W6 x 12 #2	W6 x 15 #1	W6 x 15 #1	W6 x 15 #1	W6 x 15 #1	W8 x 18 #2	W6 x 20 #1S	W8 x 21 #1S	W10 x 26 #2	W10 x 26 #2	W10 x 26 #1	W10 x 30 #1S	W12 x 30 #2	
	10 ft	W6 x 9 #2	W6 x 12 #2	W6 x 12 #1	W6 x 12 #1	W6 x 12 #1	W6 x 15 #1	W6 x 15 #1	W6 x 15 #1	W6 x 16 #1	W8 x 18 #1	W6 x 20 #1	W6 x 20 #1	W6 x 20 #1	W6 x 20 #1S	W8 x 24 #1S	-	-	-	-	
	11 ft	W6 x 9 #2	W6 x 12 #2	W6 x 12 #1	W6 x 12 #1	W6 x 12 #1	W6 x 15 #1	W6 x 15 #1	W6 x 15 #1	W6 x 15 #1	W8 x 18 #1	W6 x 20 #1	W6 x 20 #1	W6 x 20 #1	W8 x 24 #1S	-	-	-	-	-	
	12 ft	W6 x 12 #1	W6 x 12 #1	W6 x 15 #1	W6 x 15 #1	W6 x 15 #1	W6 x 15 #1	W6 x 15 #1	W6 x 15 #1	W8 x 18 #1	W6 x 20 #1	W6 x 20 #1	W6 x 20 #1	W8 x 21 #1	-	-	-	-	-	-	
	13 ft	W6 x 12 #1	W6 x 15 #1	W6 x 15 #1	W6 x 15 #1	W6 x 15 #1	W6 x 15 #1	W6 x 15 #1	W8 x 18 #1	W6 x 20 #1	W6 x 20 #1	W6 x 20 #1	W6 x 20 #1	-	-	-	-	-	-	-	
11 ft	14 ft	W6 x 12 #1	W6 x 15 #1	W6 x 15 #1	W6 x 15 #1	W6 x 15 #1	W6 x 15 #1	W6 x 15 #1	W8 x 18 #1	W6 x 20 #1	W6 x 20 #1	W6 x 20 #1	W6 x 20 #1	-	-	-	-	-	-	-	
	15 ft	W6 x 12 #1	W6 x 15 #1	W6 x 15 #1	W6 x 15 #1	W6 x 16 #1	W8 x 18 #1	-	-	-	-	-	-	-	-	-	-	-	-	-	
	16 ft	W6 x 15 #1	W6 x 15 #1	W6 x 15 #1	-	-	-	-	-	-	-	-	-	-	-	-	-	-	-	-	
	7 ft	W6 x 9 #3	W6 x 9 #3	W6 x 9 #2	W8 x 10 #3	W6 x 9 #2	W6 x 12 #2	W6 x 12 #2	W6 x 15 #2	W6 x 15 #2	W6 x 15 #2	W6 x 15 #1S	W6 x 16 #1S	W8 x 18 #2S	W8 x 21 #2S	W10 x 22 #2	W10 x 22 #2	W10 x 26 #2	W10 x 26 #2S	W12 x 30 #2S	
	8 ft	W6 x 9 #2	W6 x 9 #2	W6 x 9 #2	W6 x 12 #2	W6 x 9 #2	W6 x 12 #2	W6 x 12 #2	W6 x 15 #2	W6 x 15 #2	W6 x 15 #1	W6 x 15 #1	W8 x 18 #2	W6 x 20 #1S	W8 x 21 #1S	W10 x 26 #2	W10 x 26 #2	W10 x 26 #1	W10 x 30 #2	W14 x 30 #2	
	9 ft	W6 x 9 #2	W6 x 9 #2	W6 x 9 #2	W6 x 12 #2	W6 x 9 #2	W6 x 12 #2	W6 x 12 #2	W6 x 15 #1	W6 x 15 #1	W6 x 15 #1	W6 x 15 #1	W8 x 18 #2	W6 x 20 #1S	W8 x 21 #1S	W10 x 26 #2	W10 x 26 #2	W10 x 26 #1	W10 x 30 #1S	W12 x 30 #2	
	10 ft	W6 x 9 #2	W6 x 12 #2	W6 x 12 #1	W6 x 12 #1	W6 x 12 #1	W6 x 15 #1	W6 x 15 #1	W6 x 15 #1	W6 x 16 #1	W8 x 18 #1	W6 x 20 #1	W6 x 20 #1	W6 x 20 #1	W8 x 21 #1	-	-	-	-	-	
	11 ft	W6 x 9 #2	W6 x 12 #2	W6 x 12 #1	W6 x 12 #1	W6 x 12 #1	W6 x 15 #1	W6 x 15 #1	W6 x 15 #1	W6 x 15 #1	W8 x 18 #1	W6 x 20 #1	W6 x 20 #1	W6 x 20 #1	W8 x 21 #1	-	-	-	-	-	
	12 ft	W6 x 12 #1	W6 x 12 #1	W6 x 15 #1	W6 x 15 #1	W6 x 15 #1	W6 x 15 #1	W6 x 15 #1	W8 x 18 #1	W6 x 20 #1	W6 x 20 #1	W6 x 20 #1	W6 x 20 #1	W8 x 21 #1	-	-	-	-	-	-	
12 ft	13 ft	W6 x 12 #1	W6 x 15 #1	W6 x 15 #1	W6 x 15 #1	W6 x 15 #1	W6 x 15 #1	W6 x 15 #1	W8 x 18 #1	W6 x 20 #1	W6 x 20 #1	W6 x 20 #1	W6 x 20 #1	-	-	-	-	-	-	-	
	14 ft	W6 x 12 #1	W6 x 15 #1	W6 x 15 #1	W6 x 15 #1	W6 x 15 #1	W6 x 15 #1	W6 x 15 #1	W8 x 18 #1	W6 x 20 #1	W6 x 20 #1	W6 x 20 #1	W6 x 20 #1	-	-	-	-	-	-	-	
	15 ft	W6 x 15 #1	W6 x 15 #1	W6 x 16 #1	W8 x 18 #1	-	-	-	-	-	-	-	-	-	-	-	-	-	-	-	
	16 ft	W6 x 15 #1	W6 x 15 #1	-	-	-	-	-	-	-	-	-	-	-	-	-	-	-	-	-	
	7 ft	W6 x 9 #3	W6 x 9 #3	W6 x 9 #2	W6 x 12 #2	W6 x 9 #2	W6 x 12 #2	W6 x 12 #2	W6 x 15 #2	W6 x 15 #2	W6 x 15 #2	W6 x 15 #1S	W6 x 16 #1S	W8 x 18 #2S	W8 x 21 #2S	W10 x 22 #2	W10 x 22 #2	W10 x 26 #2	W10 x 26 #2S	W12 x 30 #2S	
	8 ft	W6 x 9 #2	W6 x 9 #2	W6 x 12 #2	W6 x 12 #2	W6 x 12 #2	W6 x 12 #2	W6 x 15 #2	W6 x 15 #2	W6 x 15 #2	W6 x 15 #1	W6 x 15 #1	W8 x 18 #2	W6 x 20 #1S	W8 x 21 #1S	W10 x 26 #2	W10 x 26 #2	W10 x 26 #1	W10 x 30 #2	W14 x 30 #2	
	9 ft	W6 x 9 #2	W6 x 9 #2	W6 x 12 #2	W6 x 12 #2	W6 x 12 #2	W6 x 15 #2	W6 x 15 #2	W6 x 15 #2	W6 x 15 #1	W6 x 15 #1	W6 x 15 #1	W8 x 18 #2	W6 x 20 #1S	W8 x 21 #1S	W10 x 26 #2	W10 x 26 #2	W10 x 26 #1	W10 x 30 #1S	W12 x 30 #2	
	10 ft	W6 x 9 #2	W6 x 12 #2	W6 x 12 #1	W6 x 12 #1	W6 x 12 #1	W6 x 15 #1	W6 x 15 #1	W6 x 15 #1	W6 x 16 #1	W8 x 18 #1	W6 x 20 #1	W6 x 20 #1	W6 x 20 #1	W8 x 21 #1	-	-	-	-	-	
	11 ft	W6 x 9 #2	W6 x 12 #2	W6 x 12 #1	W6 x 12 #1	W6 x 12 #1	W6 x 15 #1	W6 x 15 #1	W6 x 15 #1	W6 x 15 #1	W8 x 18 #1	W6 x 20 #1	W6 x 20 #1	W6 x 20 #1	W8 x 21 #1	-	-	-	-	-	
13 ft	12 ft	W6 x 12 #1	W6 x 15 #1	W6 x 15 #1	W6 x 15 #1	W6 x 15 #1	W6 x 15 #1	W6 x 15 #1	W8 x 18 #1	W6 x 20 #1	W6 x 20 #1	W6 x 20 #1	W6 x 20 #1	-	-	-	-	-	-	-	
	13 ft	W6 x 12 #1	W6 x 15 #1	W6 x 15 #1	W6 x 15 #1	W6 x 16 #1	W8 x 18 #1	W6 x 20 #1	W6 x 20 #1	W8 x 21 #1	W10 x 26 #1	W10 x 26 #1	W10 x 26 #1	W10 x 30 #1	W12 x 30 #1	W14 x 34 #1	W16 x 36 #2	W18 x 40 #2	-	-	
	14 ft	W6 x 15 #1	W6 x 15 #1	W6 x 15 #1	W8 x 18 #1	W6 x 20 #1	W6 x 20 #1	W6 x 20 #1	W8 x 24 #1	W10 x 26 #1	W10 x 26 #1	W10 x 26 #1	W10 x 30 #1	W12 x 30 #1	W14 x 34 #1	W16 x 40 #2	-	-	-	-	
	15 ft	W6 x 15 #1	W6 x 15 #1	W6 x 18 #1	W6 x 20 #1	W6 x 20 #1	W6 x 20 #1	W8 x 24 #1	W10 x 26 #1	W10 x 26 #1	W10 x 26 #1	W10 x 30 #1	W12 x 30 #1	W14 x 34 #1	W16 x 40 #2	-	-	-	-	-	
	16 ft	W6 x 15 #1	W6 x 16 #1	W8 x 18 #1	W6 x 20 #1	W6 x 20 #1	W8 x 24 #1	W10 x 26 #1	W10 x 30 #1	W10 x 30 #1	W10 x 30 #1	W14 x 34 #1	W14 x 34 #1	-	-	-	-	-	-	-	
	7 ft	W6 x 9 #3	W6 x 9 #2	W8 x 10 #3	W6 x 12 #2	W6 x 12 #2	W6 x 15 #2	W6 x 15 #2	W6 x 15 #2S	W6 x 15 #2S	W8 x 18 #2S	W8 x 21 #2S	W8 x 21 #2S	W10 x 22 #2	W10 x 22 #2	W10 x 26 #2	W10 x 26 #2	W10 x 26 #2	W10 x 26 #2S	W12 x 30 #2S	
	8 ft	W6 x 9 #2	W6 x 9 #2	W6 x 12 #2	W6 x 12 #2	W6 x 12 #2	W6 x 15 #2	W6 x 15 #2	W6 x 15 #2	W6 x 15 #1	W8 x 18 #2S	W8 x 21 #2S	W8 x 21 #2S	W10 x 22 #2	W10 x 22 #2	W10 x 26 #2	W12 x 26 #2	W12 x 30 #2	W14 x 30 #2	W18 x 35 #2	
	9 ft	W6 x 9 #2	W6 x 12 #2	W6 x 12 #2	W6 x 15 #2	W6 x 15 #2	W6 x 15 #2	W6 x 15 #1	W8 x 18 #2	W6 x 18 #2	W8 x 21 #2S	W10 x 22 #2	W10 x 22 #2	W10 x 26 #2	W10 x 26 #2	W12 x 30 #2	W14 x 30 #2	W16 x 36 #2	W18 x 40 #2	W21 x 44 #3	
	10 ft	W6 x 12 #2	W6 x 12 #2	W6 x 15 #2	W6 x 15 #2	W6 x 15 #2	W6 x 15 #1	W8 x 18 #2	W6 x 20 #1S	W8 x 21 #1S	W10 x 26 #2	W10 x 26 #2	W10 x 26 #2	W10 x 26 #2	W10 x 26 #1	W12 x 30 #2	W14 x 30 #2	W16 x 36 #2	W18 x 40 #2	W21 x 44 #3	
14 ft	11 ft	W6 x 12 #2	W6 x 12 #2	W6 x 15 #1	W6 x																

[illegible]












-	-	-	-	-	THE INFORMATION, INCLUDING ESTIMATED QUANTITIES OF WORK, SHOWN ON THESE SHEETS IS BASED ON LIMITED INVESTIGATIONS BY THE STATE AND IS IN NO WAY WARRANTED TO INDICATE THE CONDITIONS OF ACTUAL QUANTITIES OF WORK WHICH WILL BE REQUIRED.	DESIGNER/DRAFTER: BKC	 STATE OF CONNECTICUT DEPARTMENT OF TRANSPORTATION 	SIGNATURE/ BLOCK:	PROJECT TITLE:	TOWN:	PROJECT NO.
-	-	-	-	-	CHECKED BY: JRH	OFFICE OF ENGINEERING APPROVED BY: DATE:		DRAWING TITLE: BREAKAWAY SIGN SUPPORTS FOUNDATION DETAILS		DRAWING NO. BSM-4	
-	-	-	-	-	SCALE AS NOTED			Filename: ...\\SB_Breakaway_Signpost_BSM4_FoundationDet.dgn		SHEET NO.	
REV.	DATE	REVISION	DESCRIPTION	SHEET NO.	Plotted Date: 12/4/2013						

TABLE 1 - BRACKET DATA													
POST SIZE	BRACKET TYPE	BRACKET WEIGHT (LBS)	DIMENSIONS (IN.)			HOLE DIAMETERS (IN.)			DIMENSIONS (IN.)			F	G
									E				
			BRACKET NO.										
						1	2	3					
W6, W8	B525	7 ⁵ / ₈	5 ¹ / ₄	1 ¹ / ₈	1 ¹ / ₂	17 ¹⁷ / ₃₂	7 ⁷ / ₁₆	1 ¹ / ₂ " -13 UNC 1A	0.100	0.150	0.200	1 ⁷ / ₈	1 ¹ / ₂
ALL OTHERS	B650	9 1 ¹ / ₂	6 1 ¹ / ₂	1 ¹ / ₈	2	21 ²¹ / ₃₂	17 ¹⁷ / ₃₂	5 ⁵ / ₈ " -11 UNC 1A	0.100	0.150	0.200	2 ⁷ / ₈	1 ¹ / ₂

POST SIZE	BRACKET TYPE	BOLT AND CAP SCREW DIAMETER	BOLT LENGTH			CAP SCREW LENGTH	THREAD DESIGNATION (U.S. CUSTOMARY UNITS)	
			TOP	MIDDLE	BOTTOM		BOLT	CAP SCREW
W6, W8	B525	$\frac{1}{2}$	$2\frac{1}{2}$	$2\frac{3}{4}$	3	$1\frac{1}{4}$	13 UNC	13 UNC
ALL OTHERS	B650	$\frac{5}{8}$	$2\frac{3}{4}$	3	$3\frac{1}{4}$	$1\frac{1}{4}$	11 UNC	11 UNC

SHIM AS REQUIRED WITH MANUFACTURER
SUPPLIED SHIMS (4 LOCATIONS).
NO MORE THAN TWO SHIMS UNDERNEATH
ANY ONE COUPLING AND NO MORE THAN
THREE SHIMS UNDERNEATH ANY TWO
COUPLINGS.

[illegible]

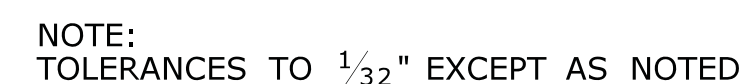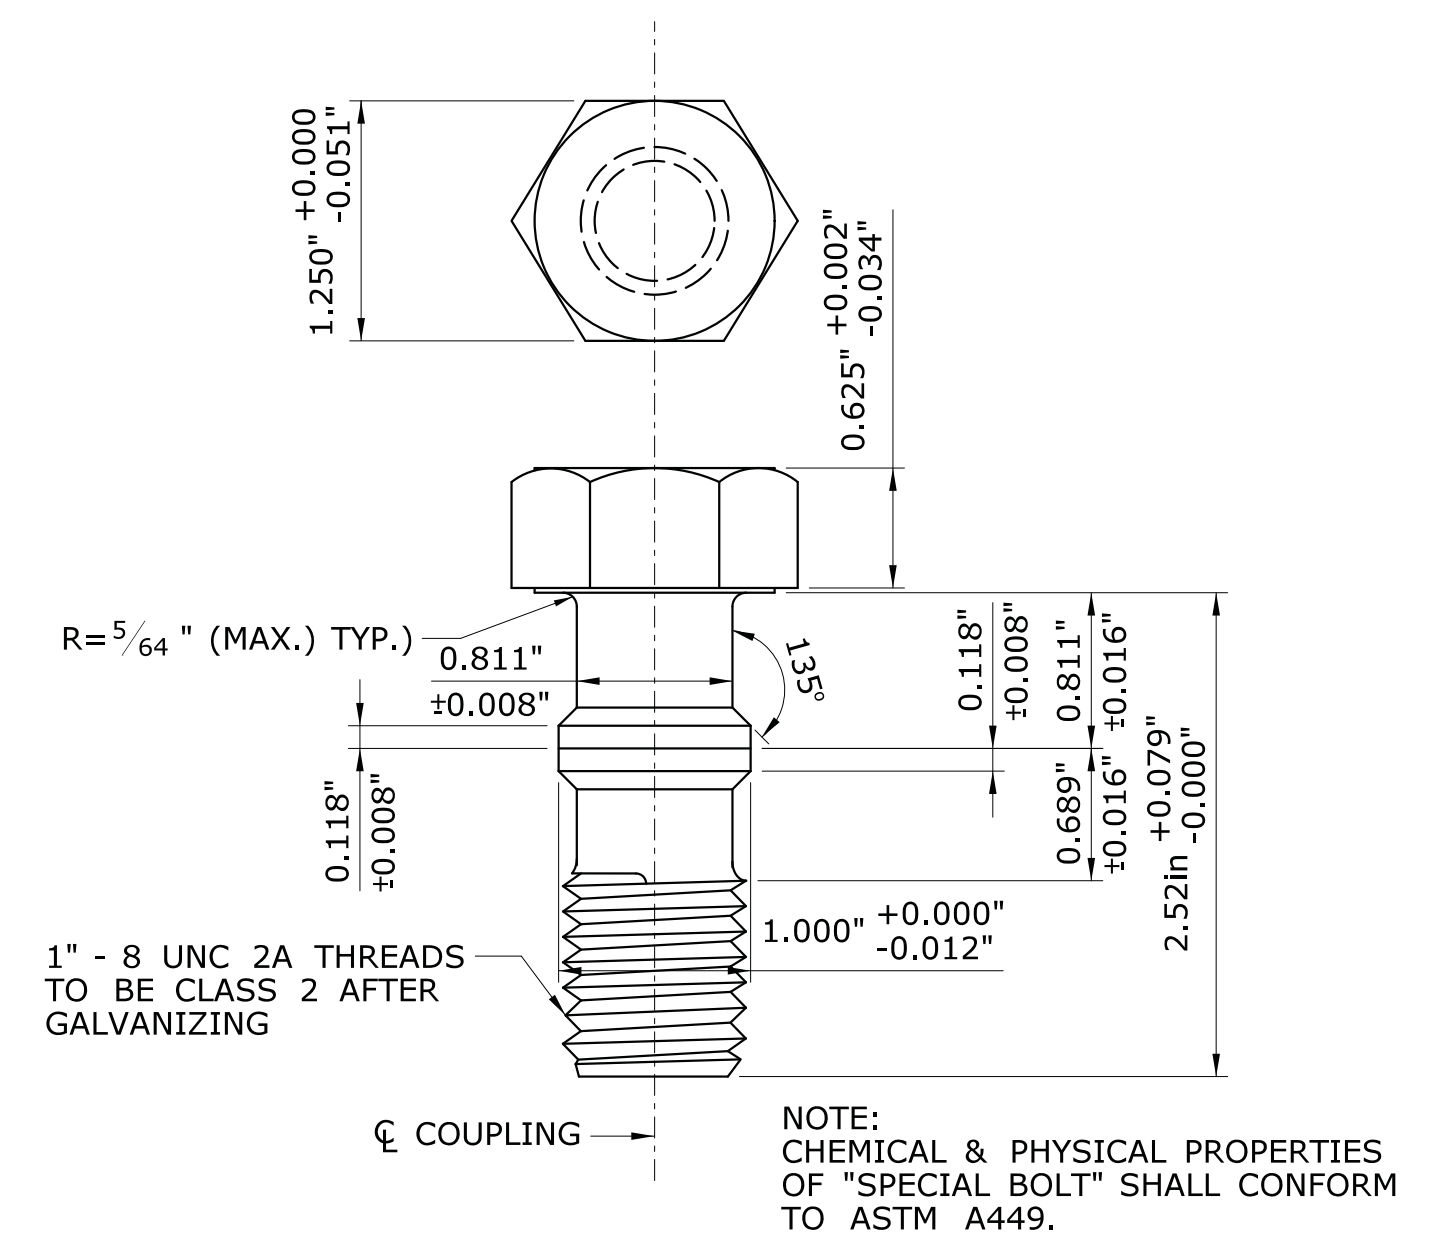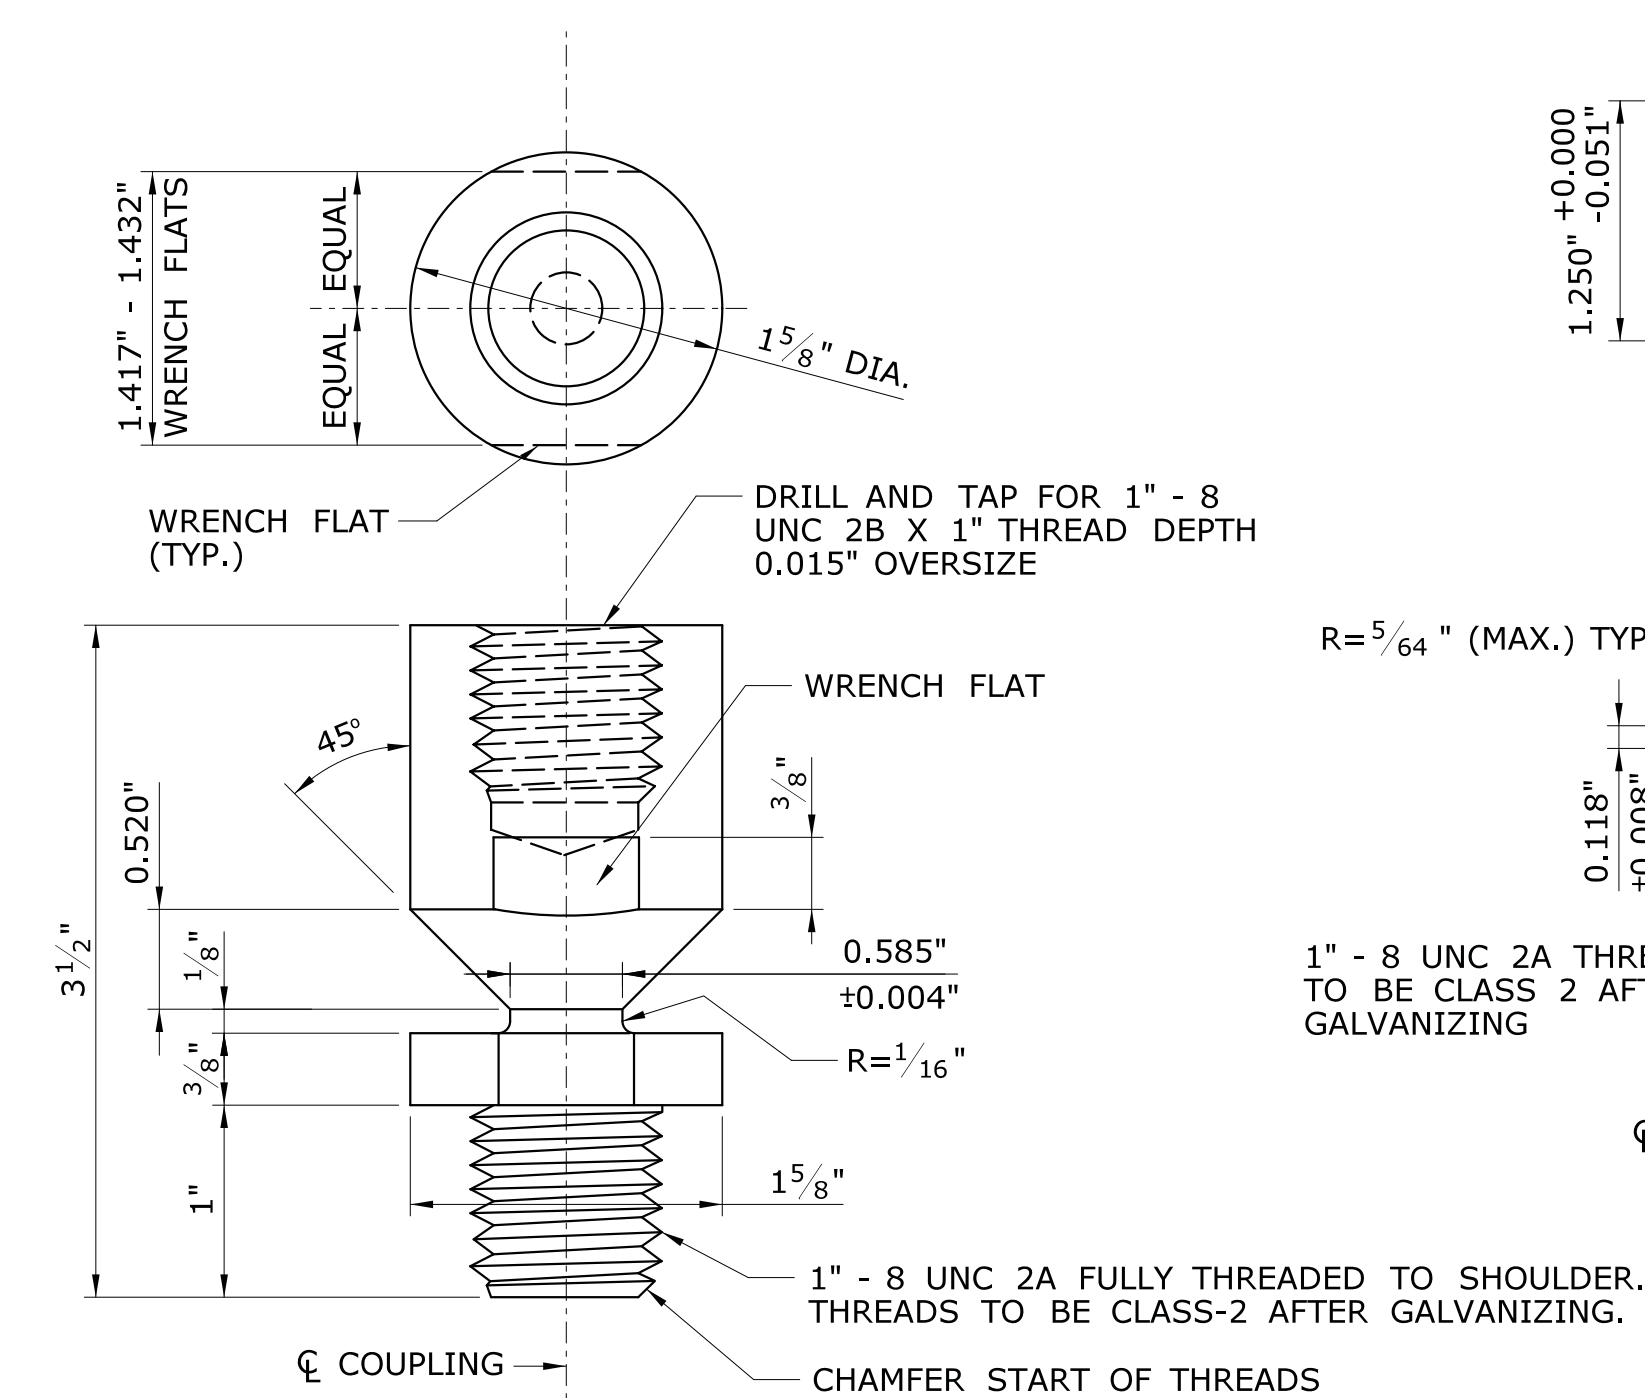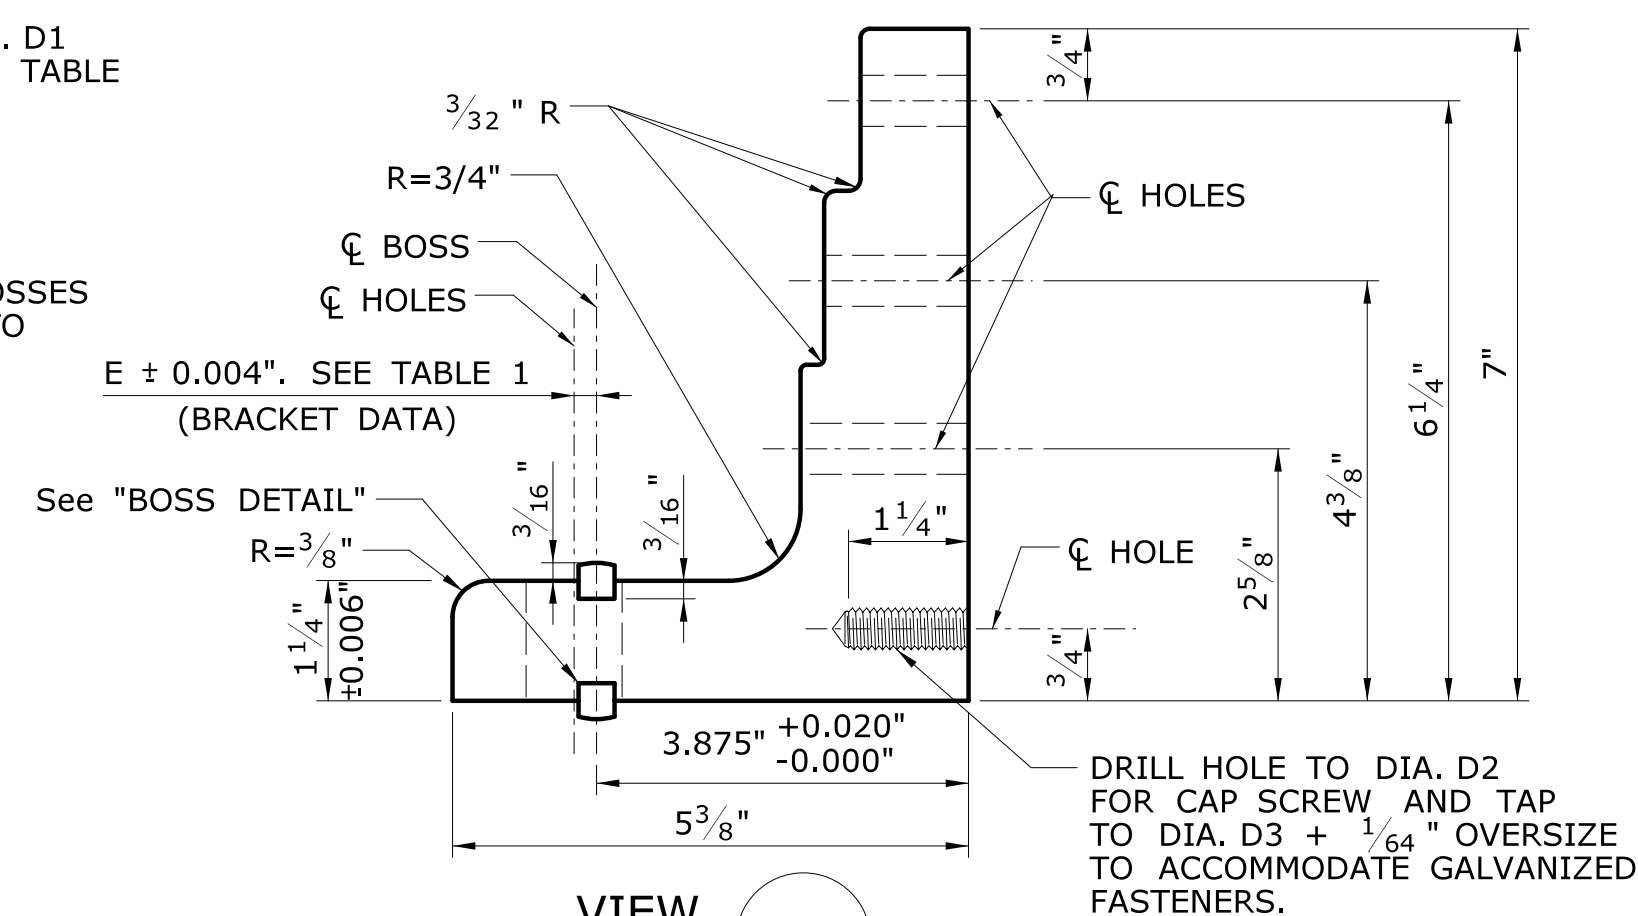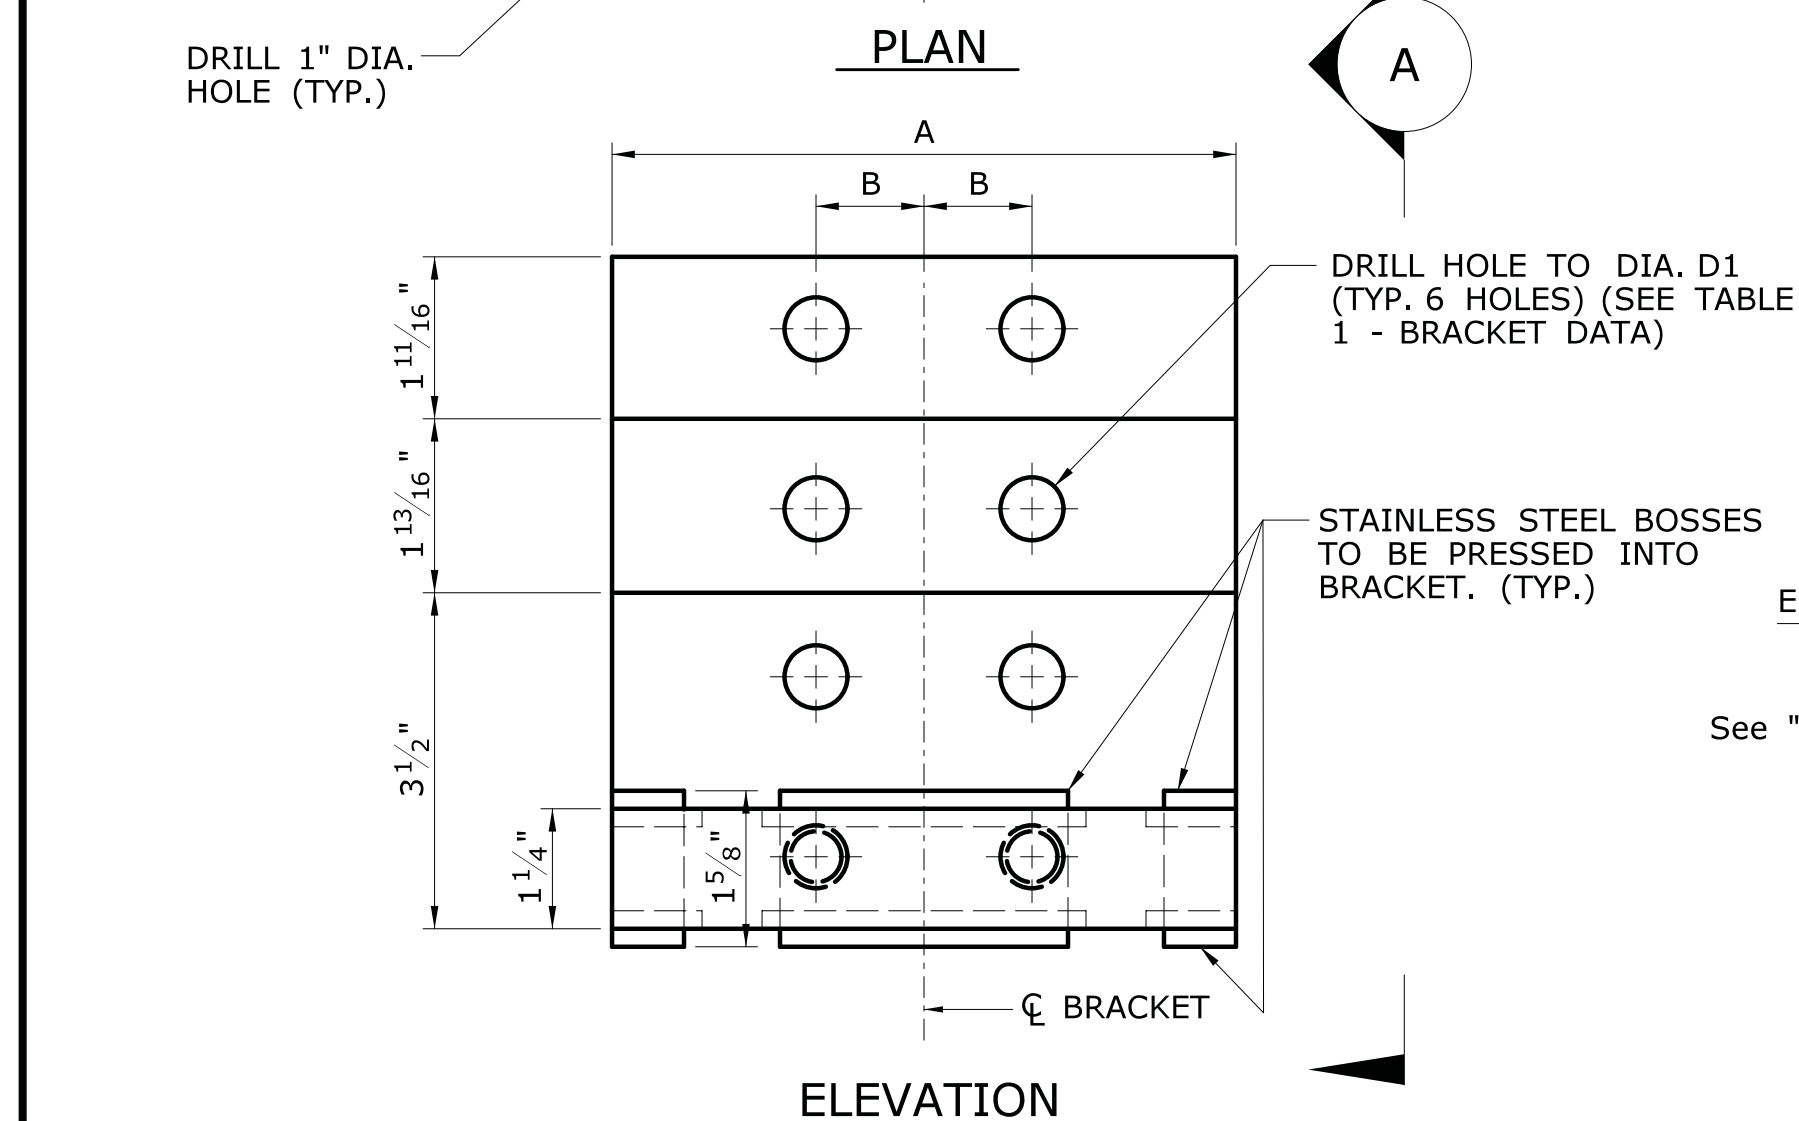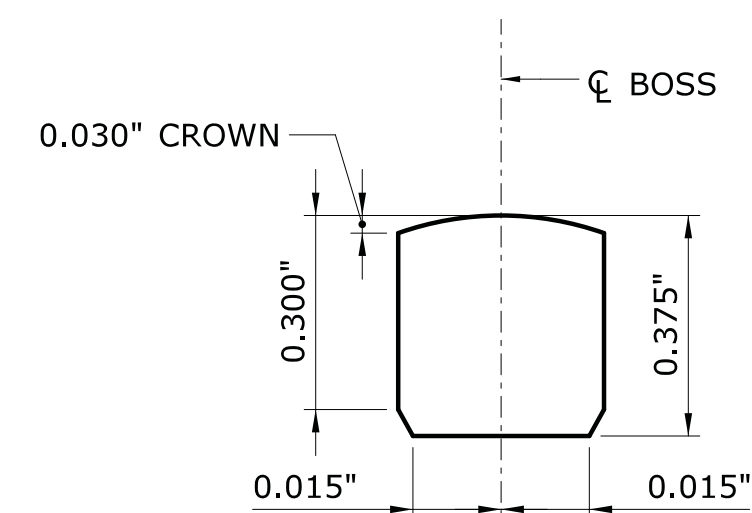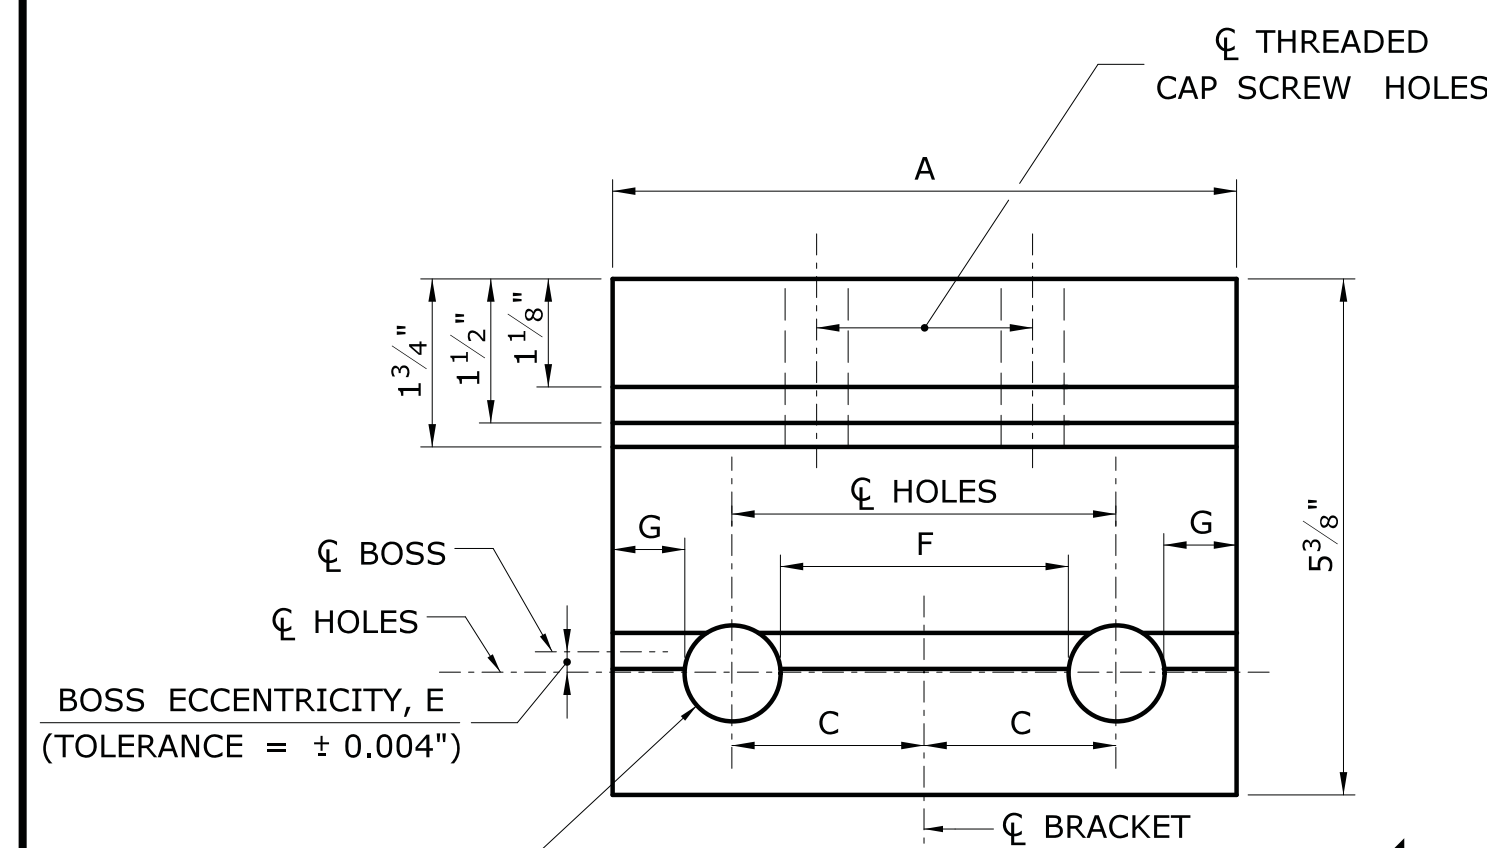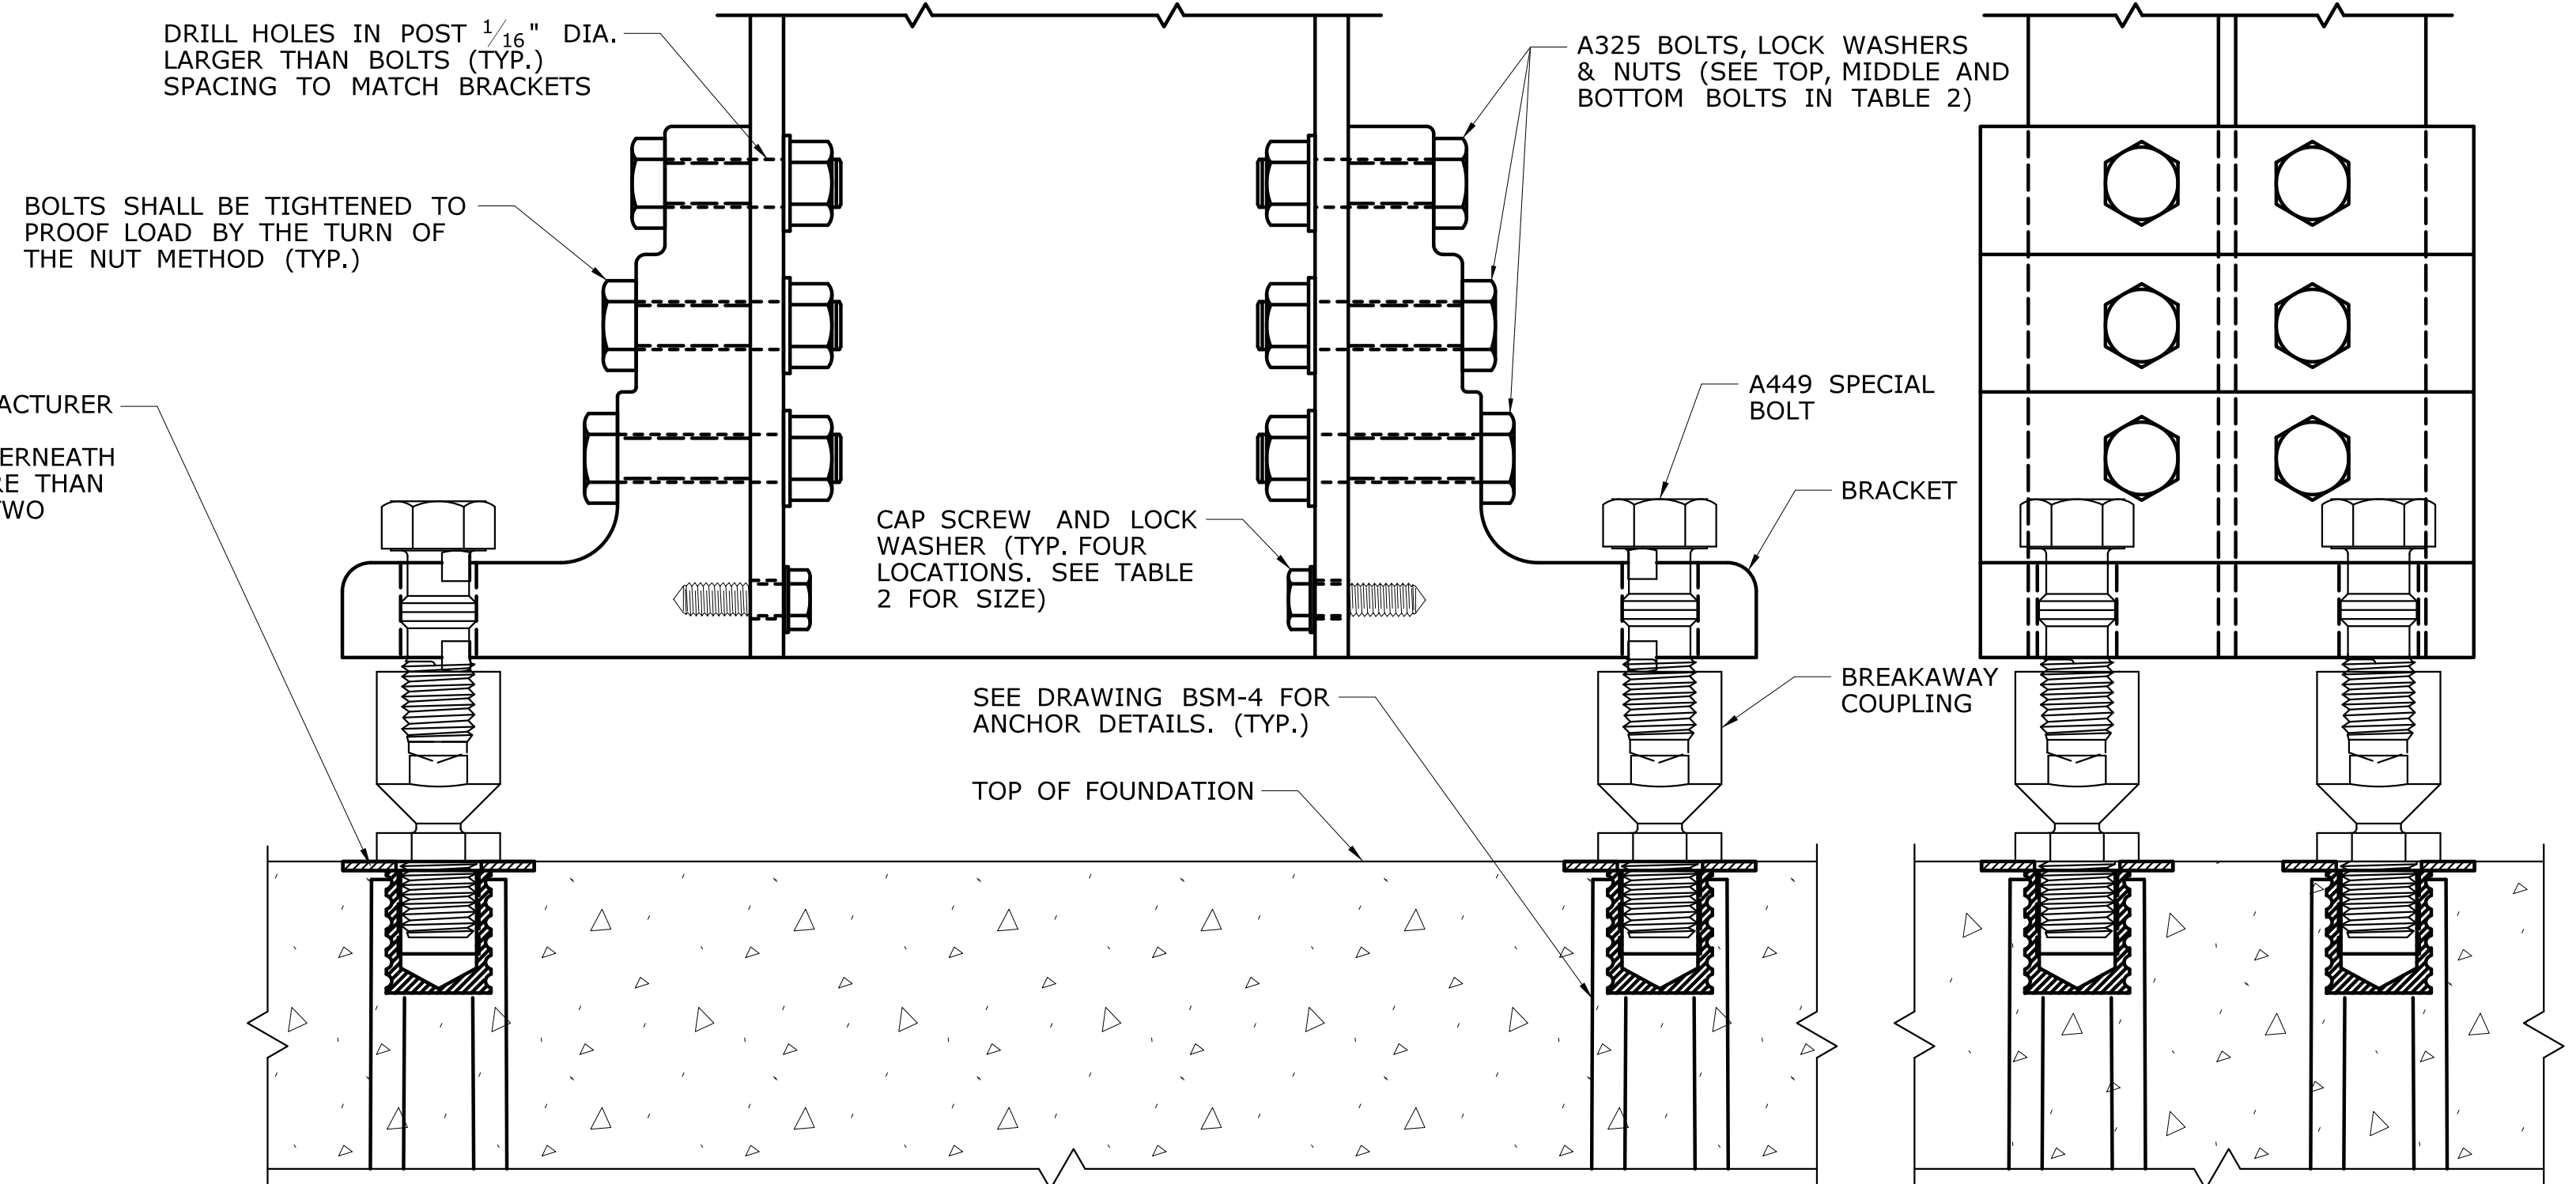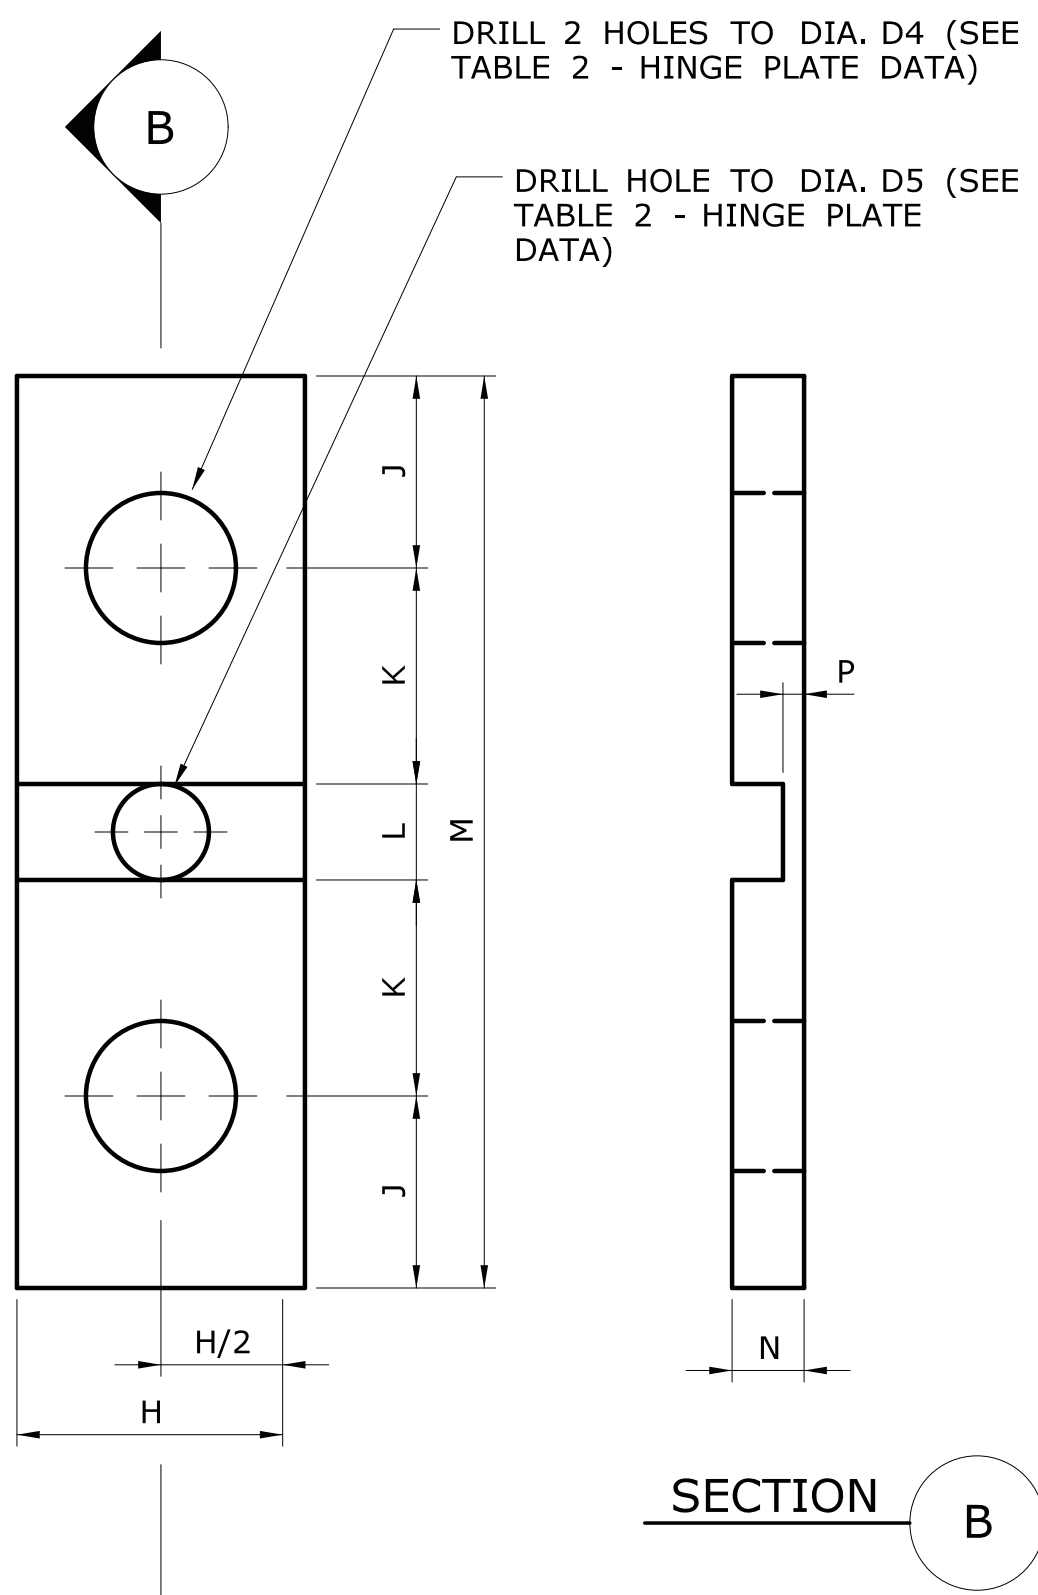

SPECIFICATIONS: CONNECTICUT DEPARTMENT OF TRANSPORTATION FORM 816 (2004),
SUPPLEMENTAL SPECIFICATION DATED JANUARY 2011, AND SPECIAL PROVISIONS.
DESIGN SPECIFICATIONS: AASHTO STANDARD SPECIFICATIONS FOR HIGHWAY BRIDGES
17TH EDITION DATED 2002, AND AASHTO STANDARD SPECIFICATIONS FOR STRUCTURAL
SUPPORTS FOR HIGHWAY SIGNS, LUMINAIRES AND TRAFFIC SIGNALS (2009) WITH
THE 2011 SUPPLEMENTAL SPECIFICATIONS.
DESIGN LOADS: THE DESIGN WIND SPEED IS 100 MPH, BASED ON A 10-YEAR MEAN
RECURRENT INTERVAL.
MATERIALS:

FOUNDATIONS: CONCRETE FOR FOUNDATIONS SHALL BE CLASS "A" CONCRETE.

REINFORCEMENT; REINFORCING STEEL SHALL CONFORM TO THE REQUIREMENTS OF ASTM A615, GRADE 60.
SIGN POSTS: STEEL FOR SIGN POSTS SHALL CONFORM TO THE REQUIREMENTS OF ASTM A709, GRADE 36, AND SHALL BE HOT DIP GALVANIZED AFTER FABRICATION IN ACCORDANCE WITH ASTM A123. THE POST SHALL BE PERMANENTLY LABELED WITH THE POST SIZE ON THE WEB AT THE BOTTOM OF THE LOWER POST.
ANCHORS: THREADED FERRULES SHALL BE FABRICATED FROM TYPE 304 STAINLESS STEEL. RODS SHALL BE FABRICATED FROM STEEL CONFORMING TO AISI 1038. STEEL COILS SHALL CONFORM TO THE REQUIREMENTS OF AISI 1008. MINIMUM TENSILE STRENGTH OF 60,000 LBS.
SHIMS: 1" HORSESHOE SHIMS SHALL BE FABRICATED FROM 14 OR 18 GAUGE SHEET STEEL.

BREAKAWAY COUPLINGS BREAKAWAY COUPLINGS SHALL BE MADE FROM ALLOY STEEL CONFORMING TO AMS 6378D WITH EXCEPTIONS TO DECARBURIZATION AND MACROSTRUCTURE CLAUSES OR AN EQUIVALENT MATERIAL, AND SHALL HAVE A MINIMUM TENSILE YIELD STRENGTH OF 130,000 PSI, THE COUPLING SHALL HAVE A MINIMUM TENSILE YIELD STRENGTH OF 140,000 PSI, ROCKWELL C HARDNESS SHALL BE C32 MINIMUM, COUPLINGS SHALL BE HOT DIP GALVANIZED IN ACCORDANCE WITH ASTM A153, CLEANED AND PHOSPHATED PER FEDERAL SPECIFICATION TT-C-490C, COATED, 0.002" - 0.004" THICK, USING MORTON POWDER COATINGS' 20-7037 BLACK POLYESTER POWDER OR EQUIVALENT.

COUPLING AREAS OF THE COUPLER SURFACE SHALL BE REPAIRED. ALL THREADED SURFACES, AFTER COATING, SHALL BE CLEANED TO ALLOW THEM TO FUNCTION PROPERLY.

BRACKETS: BRACKETS SHALL BE MADE FROM ALUMINUM ALLOY 6061-T6 OR AN EQUIVALENT MATERIAL. THE LOAD CONCENTRATING MEMBER (BOSS) SHALL BE MADE FROM STAINLESS STEEL CONFORMING TO ASTM A582, TYPE 416 WITH ROCKWELL HARDNESS OF C33 - C45. LOCATION HOLES FOR THE BREAKAWAY COUPLING SHALL BE ACCURATELY POSITIONED RELATIVE TO THE LOAD CONCENTRATING MEMBER AND BRACKETS SHALL BE PERMANENTLY LABELED WITH THE BRACKET NUMBER TO REFLECT THE HOLE POSITIONING. SEE DWG. NO. BSM-5 FOR IDENTIFICATION OF BRACKETS BY NUMBER.

HINGE PLATES: HINGE PLATES SHALL BE MADE FROM ALLOY STEEL CONFORMING TO A121 4130 OR AN EQUIVALENT MATERIAL AND SHALL BE GALVANIZED AFTER FABRICATION IN ACCORDANCE WITH ASTM A123. THE HINGE PLATE SHALL HAVE A MINIMUM TENSILE YIELD STRENGTH OF 90,000 PSI AND MINIMUM TENSILE ULTIMATE STRENGTH AS FOLLOWS:

HI-1	7,100 LBS
HI-2	11,300 LBS
HI-3	17,000 LBS

BOLTS, NUTS AND WASHERS: UNLESS NOTED OTHERWISE, ALL BOLTS SHALL CONFORM TO THE REQUIREMENTS OF ASTM A325. SPECIAL BOLTS SHALL CONFORM TO ASTM A449. NUTS SHALL CONFORM TO THE REQUIREMENTS OF ASTM A563, GRADE DH. LOCKWASHERS SHALL CONFORM TO THE REQUIREMENTS OF ANSI B18-21.1. BOLTS, NUTS AND WASHERS SHALL BE GALVANIZED IN ACCORDANCE WITH THE REQUIREMENTS OF ASTM A153. SPECIAL BOLTS MAY BE MECHANICALLY GALVANIZED IN ACCORDANCE WITH THE REQUIREMENTS OF ASTM B695, CLASS 50.

CAP SCREWS: CAP SCREWS ATTACHING BRACKETS TO POSTS SHALL CONFORM TO THE REQUIREMENTS OF ASTM A307 AND SHALL BE HOT DIP GALVANIZED IN ACCORDANCE WITH ASTM A153.

BREAKAWAY HARDWARE: BREAKAWAY HARDWARE SHALL BE SUPPLIED AS COMPONENTS OF A CRASH-TESTED SYSTEM COMPLYING WITH THE GUIDELINES OF NCHRP REPORT 350 (RECOMMENDED PROCEDURES FOR THE SAFETY PERFORMANCE EVALUATION OF HIGHWAY FEATURES). THE MANUFACTURER SHALL SUBMIT TEST REPORTS TO FHWA FOR APPROVAL.

CERTIFICATION: THE CONTRACTOR SHALL PROVIDE A MATERIALS CERTIFICATE TO CERTIFY THAT THE MATERIAL AND COMPONENTS CONFORM TO THOSE SHOWN ON THE PLANS AND SPECIFICATIONS.


CHANGES: NO CHANGE IN DESIGN MATERIALS OR DETAIL ALTERATIONS WILL BE PERMITTED WITHOUT PRIOR APPROVAL BY THE ENGINEER.

INSTALLATION: INSTALLATION OF THE BREAKAWAY ASSEMBLY SHALL BE IN ACCORDANCE WITH THE RECOMMENDED PRACTICES OF THE SUPPLIER.

BASES OF PAYMENT; THE COST OF FURNISHING AND INSTALLING THE BREAKAWAY HINGE PLATE ASSEMBLY WILL BE INCLUDED IN THE PAY ITEM "STRUCTURAL STEEL SIGN SUPPORTS." THE COST OF FURNISHING AND INSTALLING THE BREAKAWAY COUPLING SYSTEM, CONSISTING OF BRACKET, BREAKAWAY COUPLINGS, SPECIAL BOLTS, AND SHIMS WILL BE INCLUDED IN THE PAY ITEM "SIDE MOUNTED SIGN FOUNDATION." THE COST OF FURNISHING AND INSTALLING FOUNDATIONS, INCLUDING EXCAVATING, CLASS "A" CONCRETE, REINFORCING STEEL AND ANCHOR FERRULES, WILL BE INCLUDED IN THE PAY ITEM "SIDE MOUNTED SIGN FOUNDATION."

TABLE 1 - HINGE BOLTS			
POST SIZE	HINGE ASSEMBLY		THREAD DESIGNATION (U.S. CUSTOMARY UNITS)
	BOLT DIAMETER	BOLT LENGTH	
W6 x 9	1/2	1 1/2	13 UNC
ALL OTHERS	3/4	2 1/4	10 UNC

SCALE: FULL

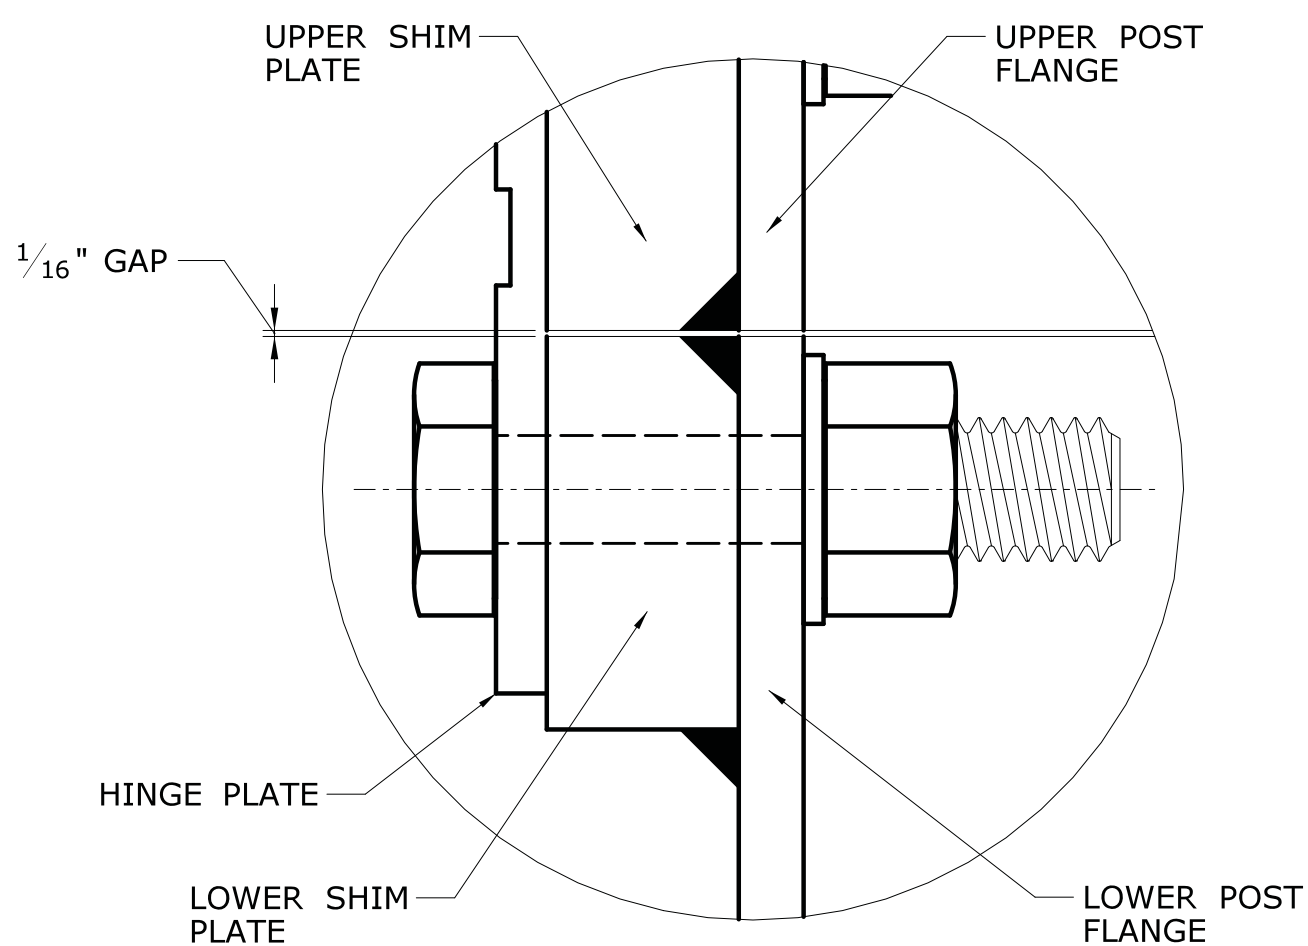


SHIM PLATE ATTACHMENT DETAILS

TABLE 2 - HINGE PLATE DATA


POST SIZE	PLATE NO.	DIMENSIONS (IN.)							HOLE DIA. (IN.)	
		H	J	K	L	M	N	P	D4	D5
W6 X 9	1	1	$\frac{3}{4}$	$\frac{7}{8}$	1	$\frac{3}{4}$	$1\frac{15}{64}$	0.071 ± 0.004	$\frac{17}{32}$	NONE
W6* AND W8	2	$1\frac{1}{2}$	1	$1\frac{1}{8}$	$\frac{1}{2}$	$4\frac{3}{4}$	$\frac{3}{8}$	0.113 ± 0.004	$\frac{25}{32}$	$\frac{1}{2}$
ALL OTHERS	3	$1\frac{1}{2}$	1	$1\frac{1}{8}$	$\frac{1}{2}$	$4\frac{3}{4}$	$\frac{3}{8}$	0.113 ± 0.004	$\frac{25}{32}$	NONE

* EXCLUDING W6 X 9

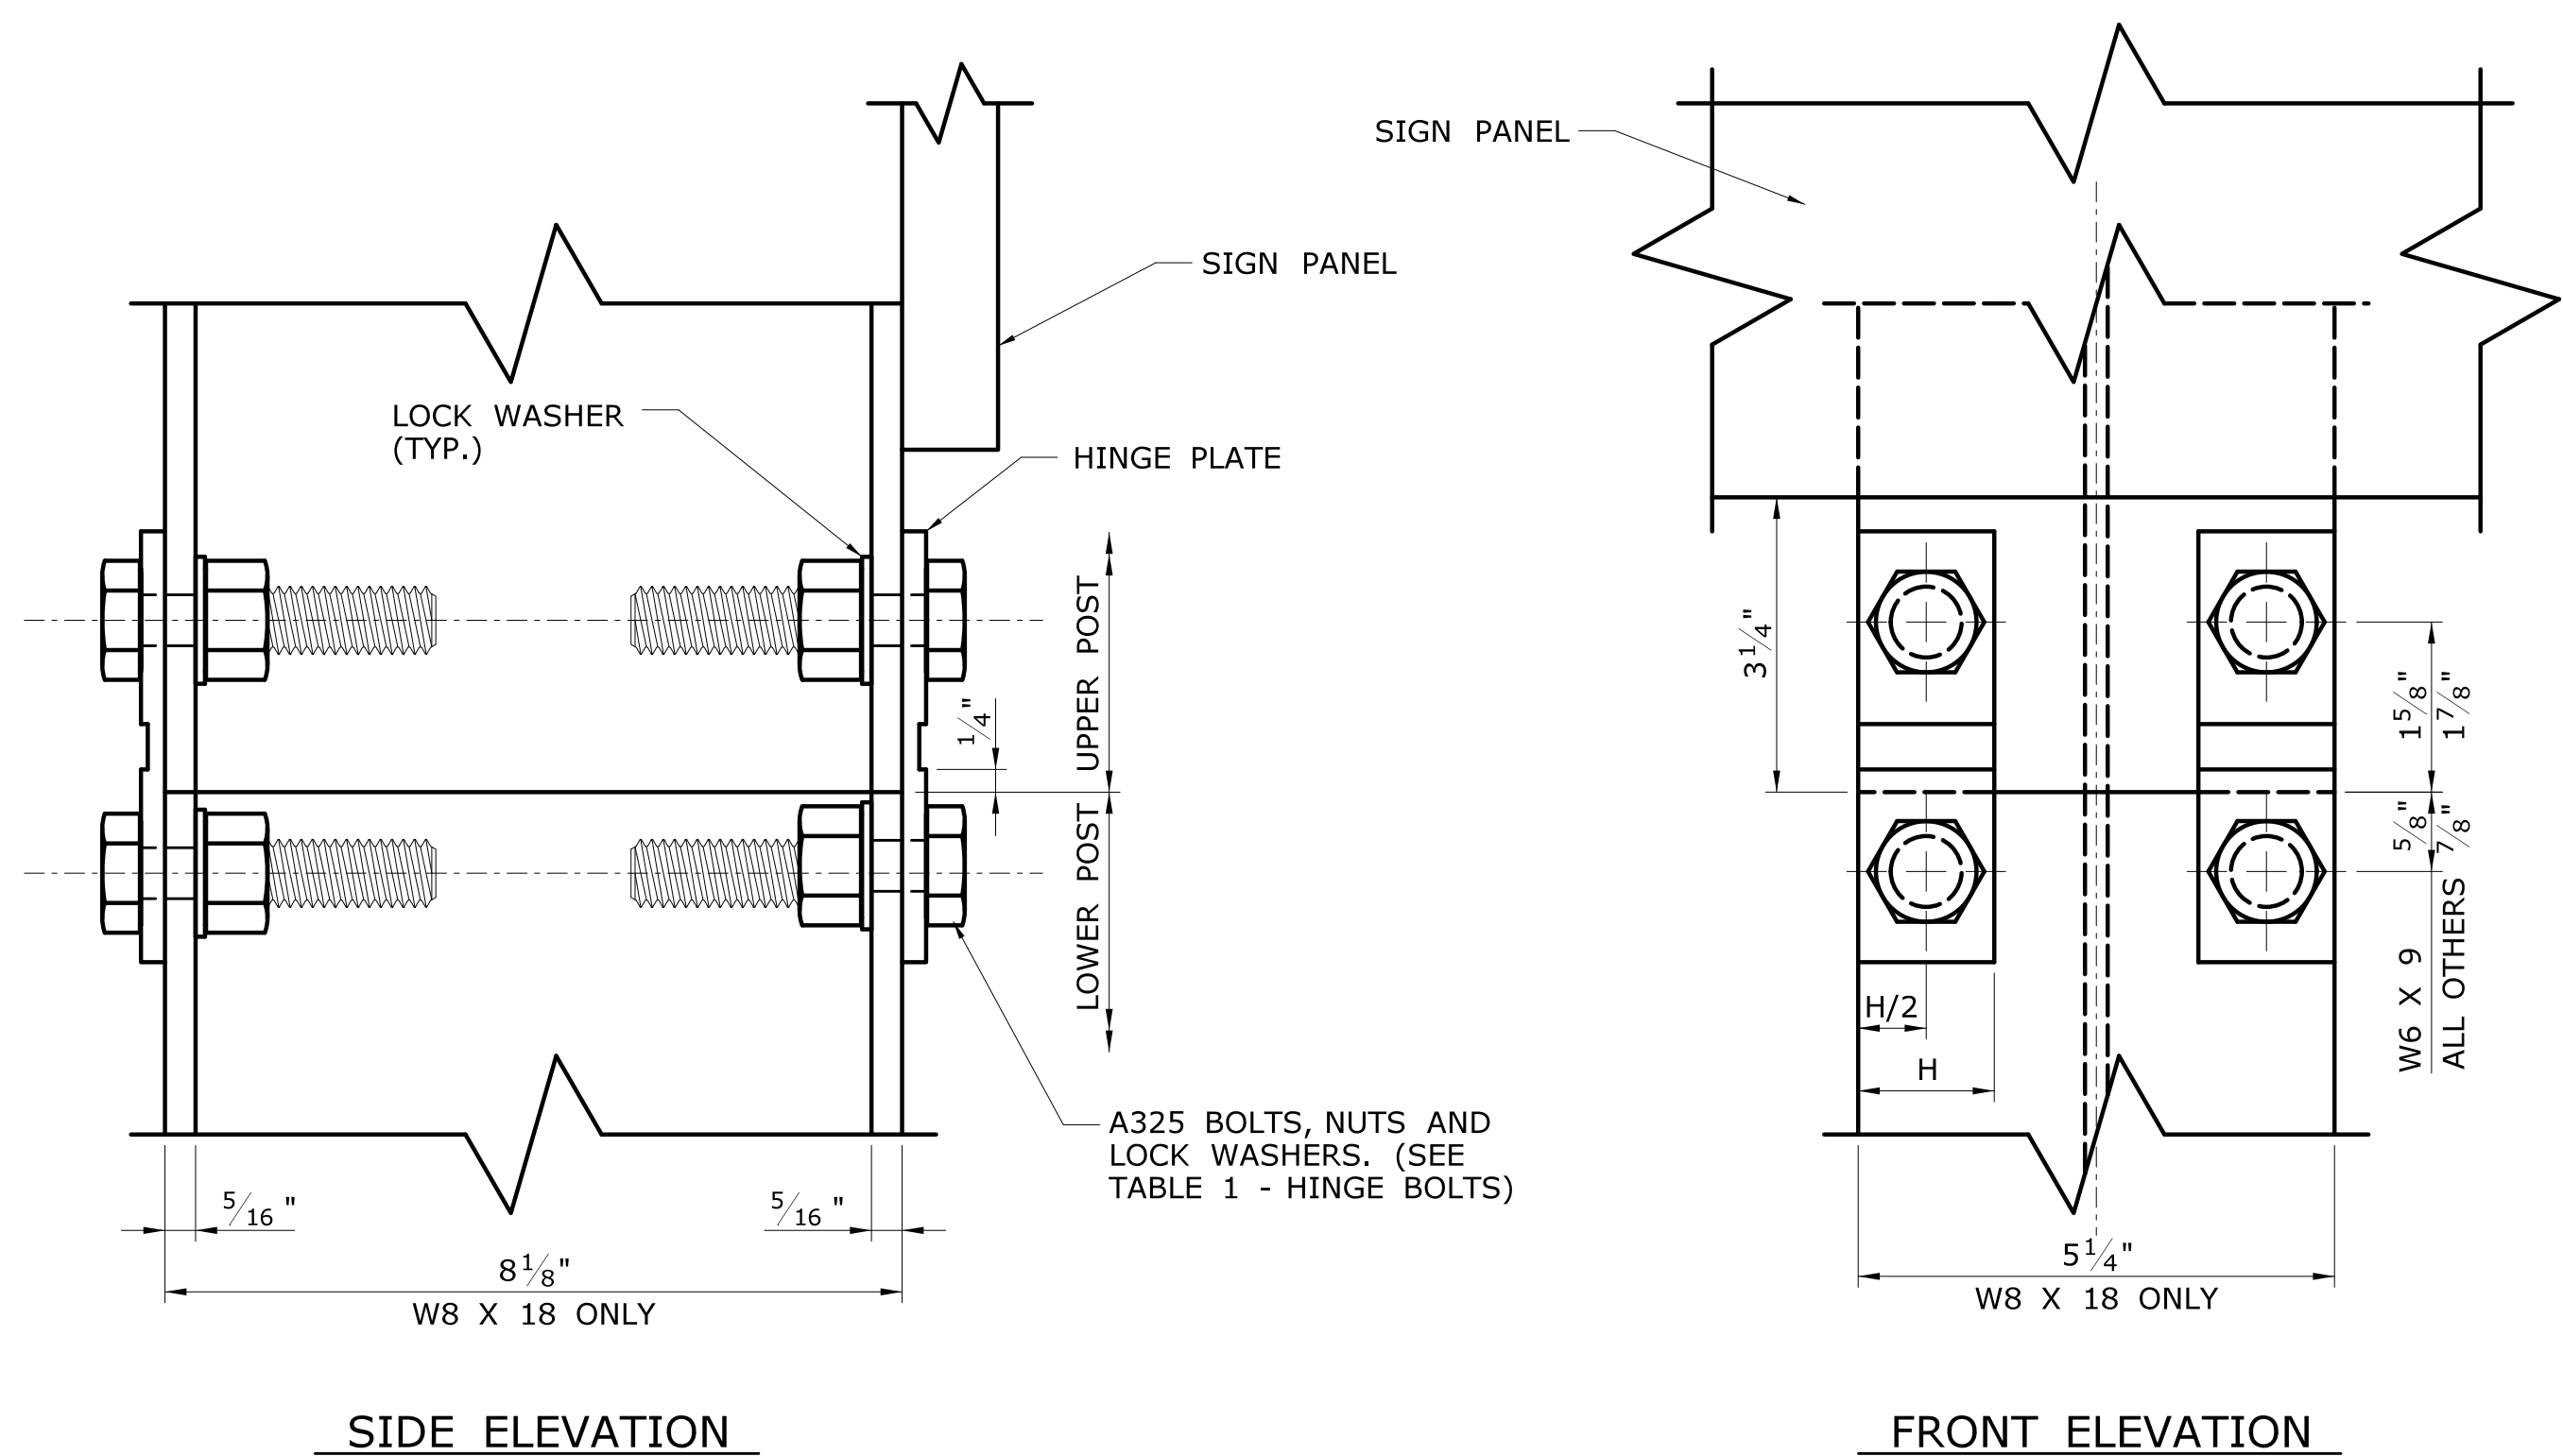


SCALE: $\frac{1}{2}$ (W8 X 18)


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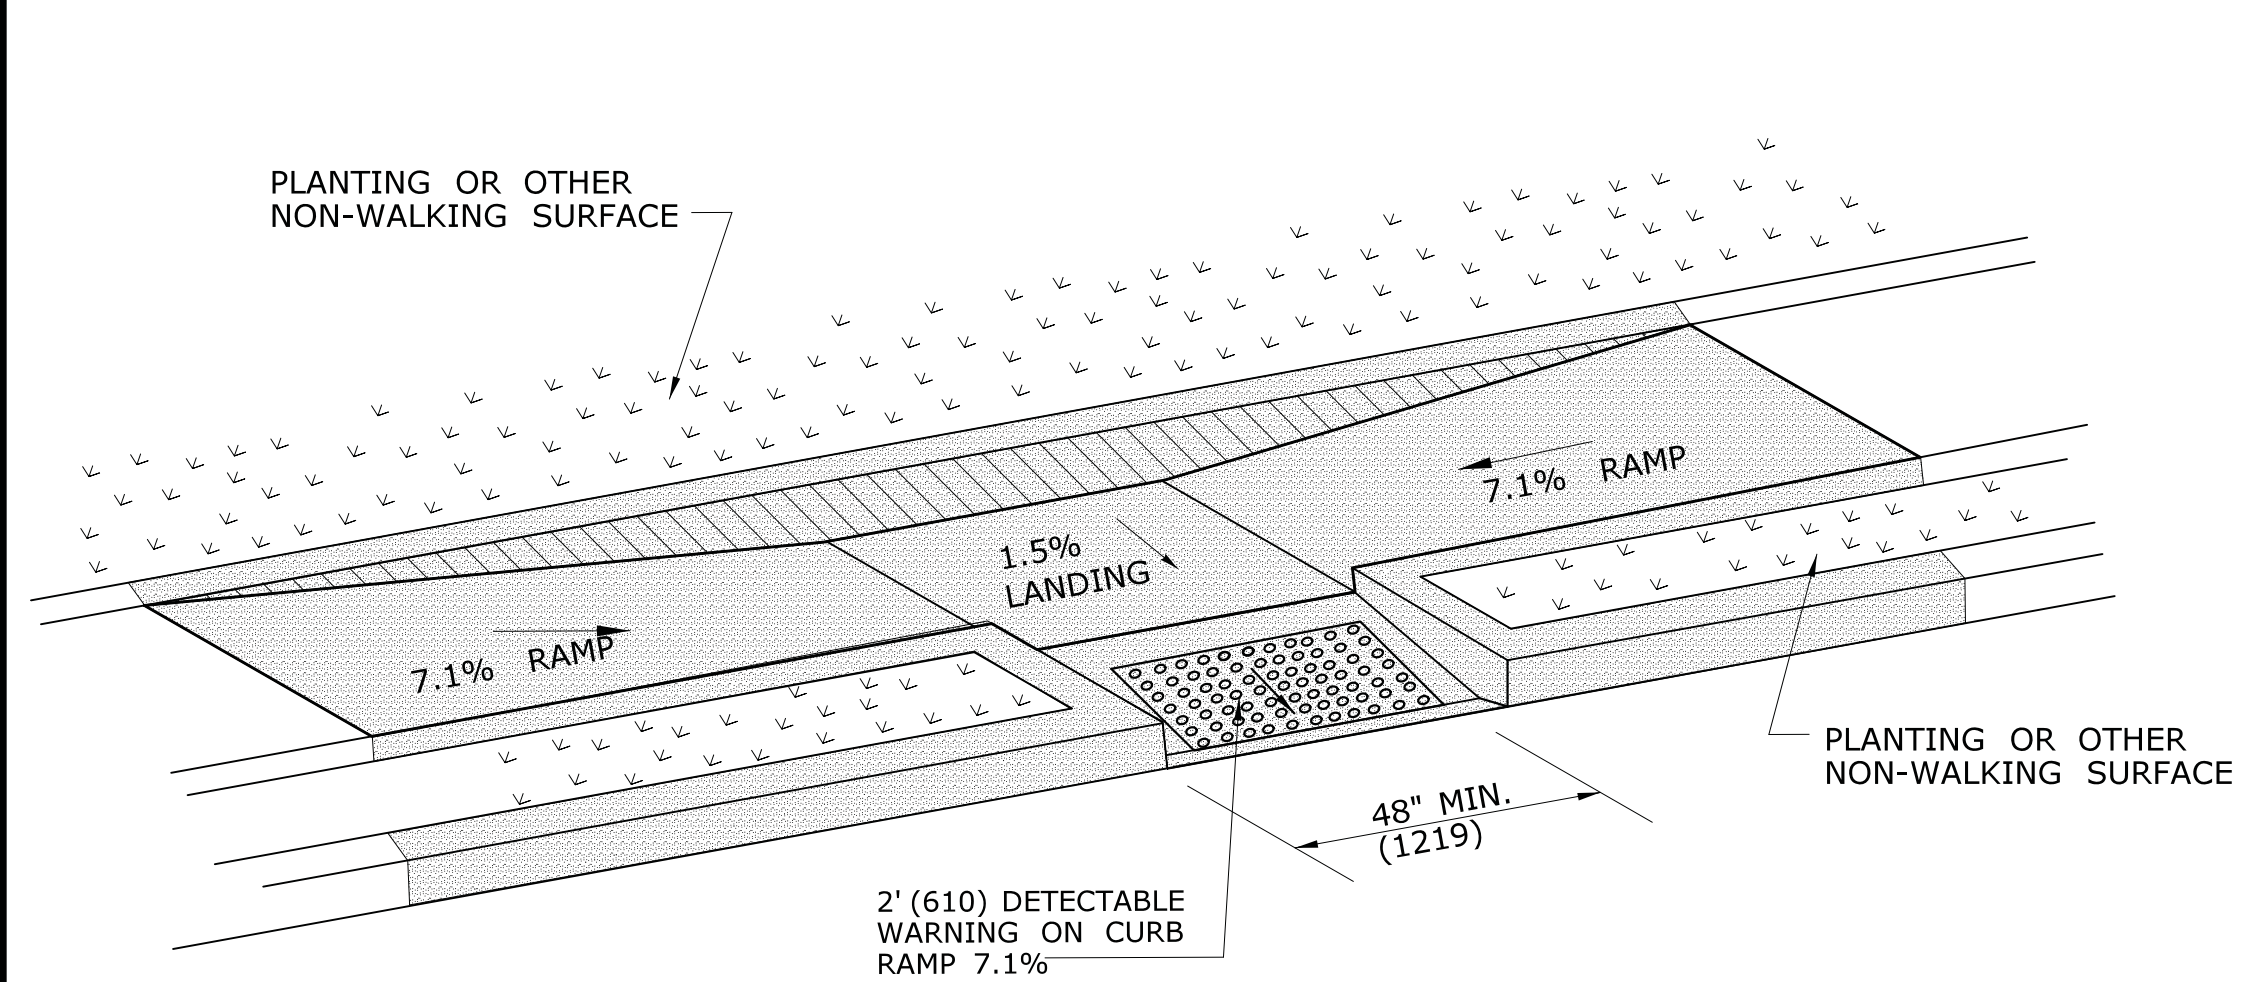
PARALLEL SIDEWALK RAMP (TYPE 1) NO UTILITY STRIP

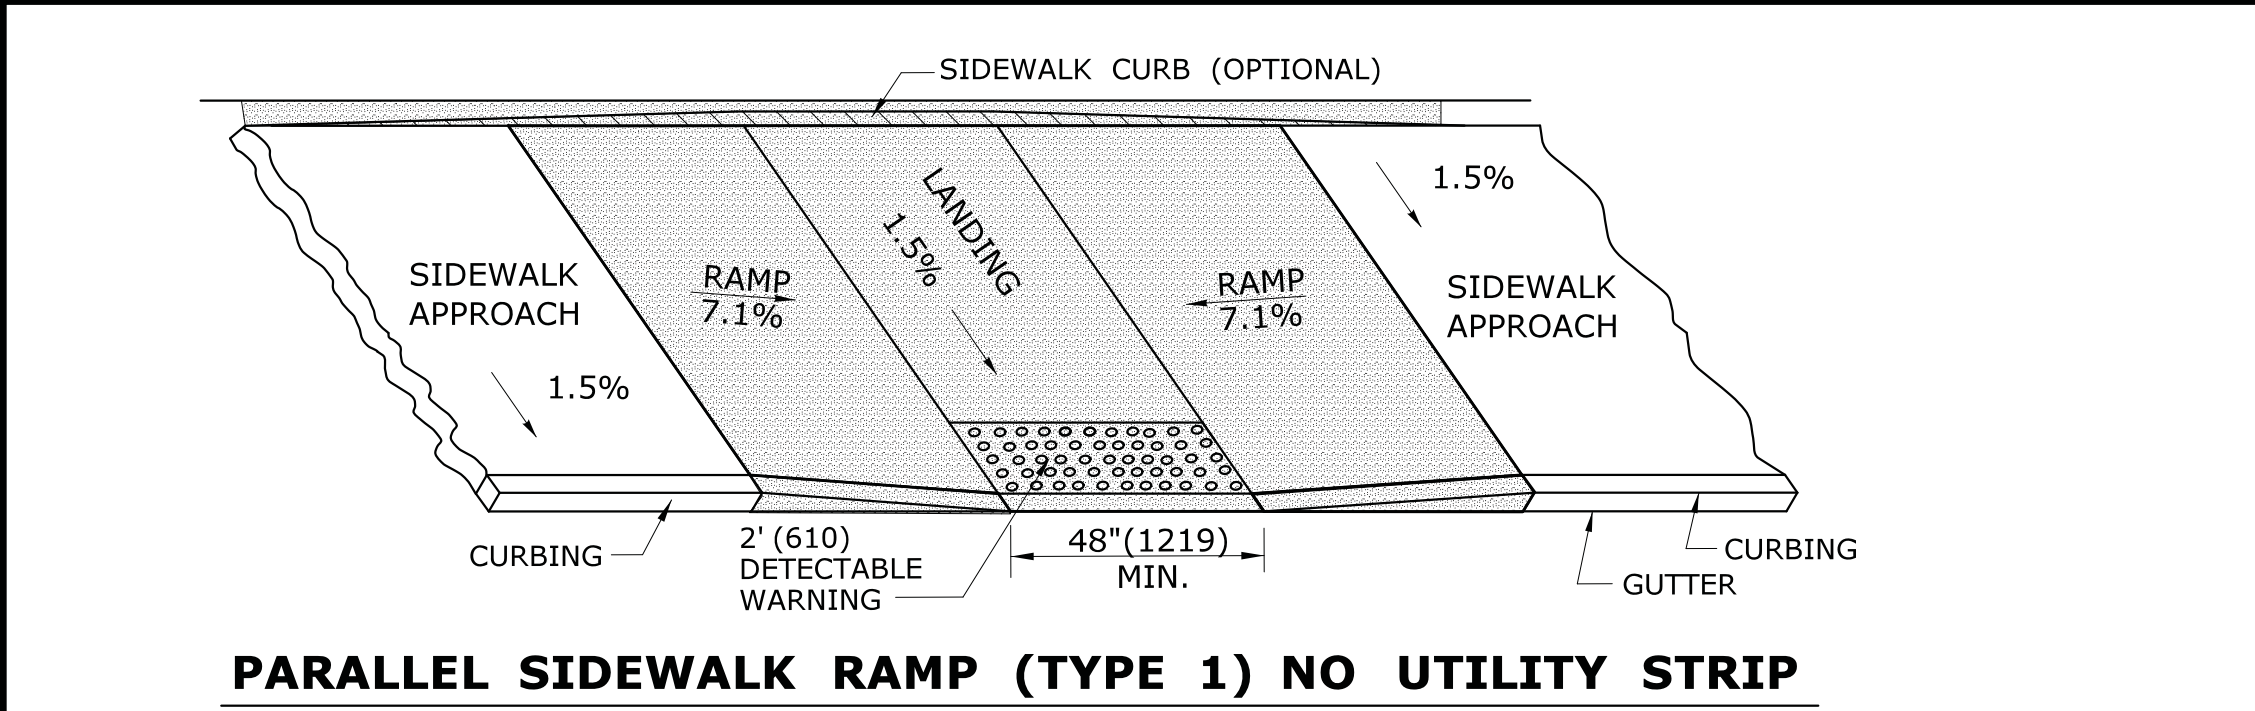


PARALLEL SIDEWALK RAMP (TYPE 1a)
WITH UTILITY / GRASS STRIP

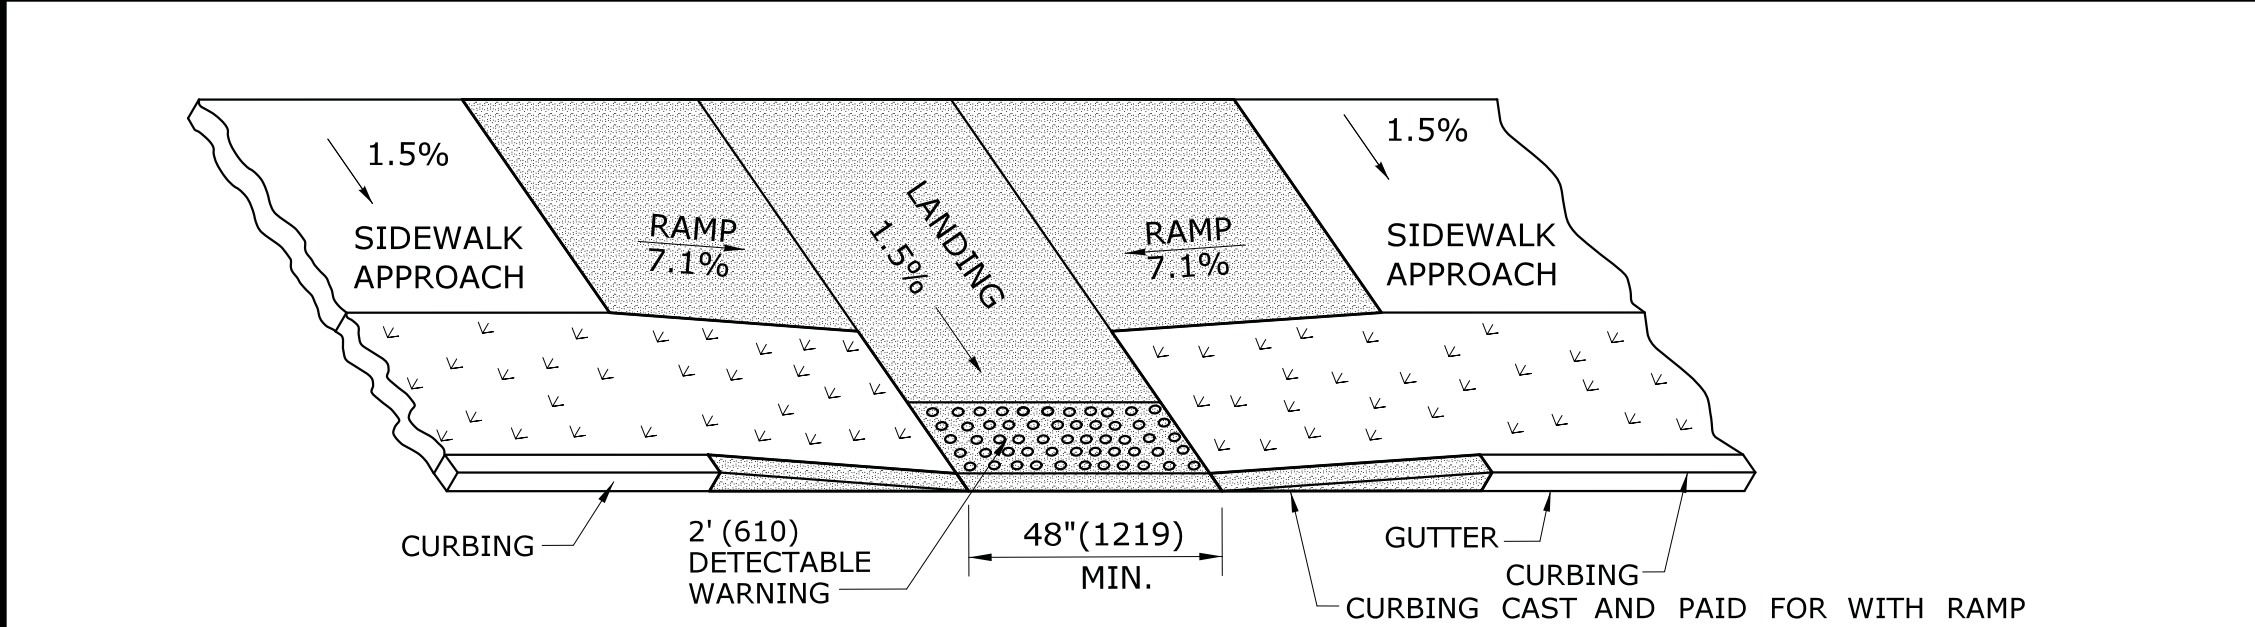


PARALLEL/PERPENDICULAR SIDEWALK RAMP
NO UTILITY/GRASS STRIP (TYPE 1b)

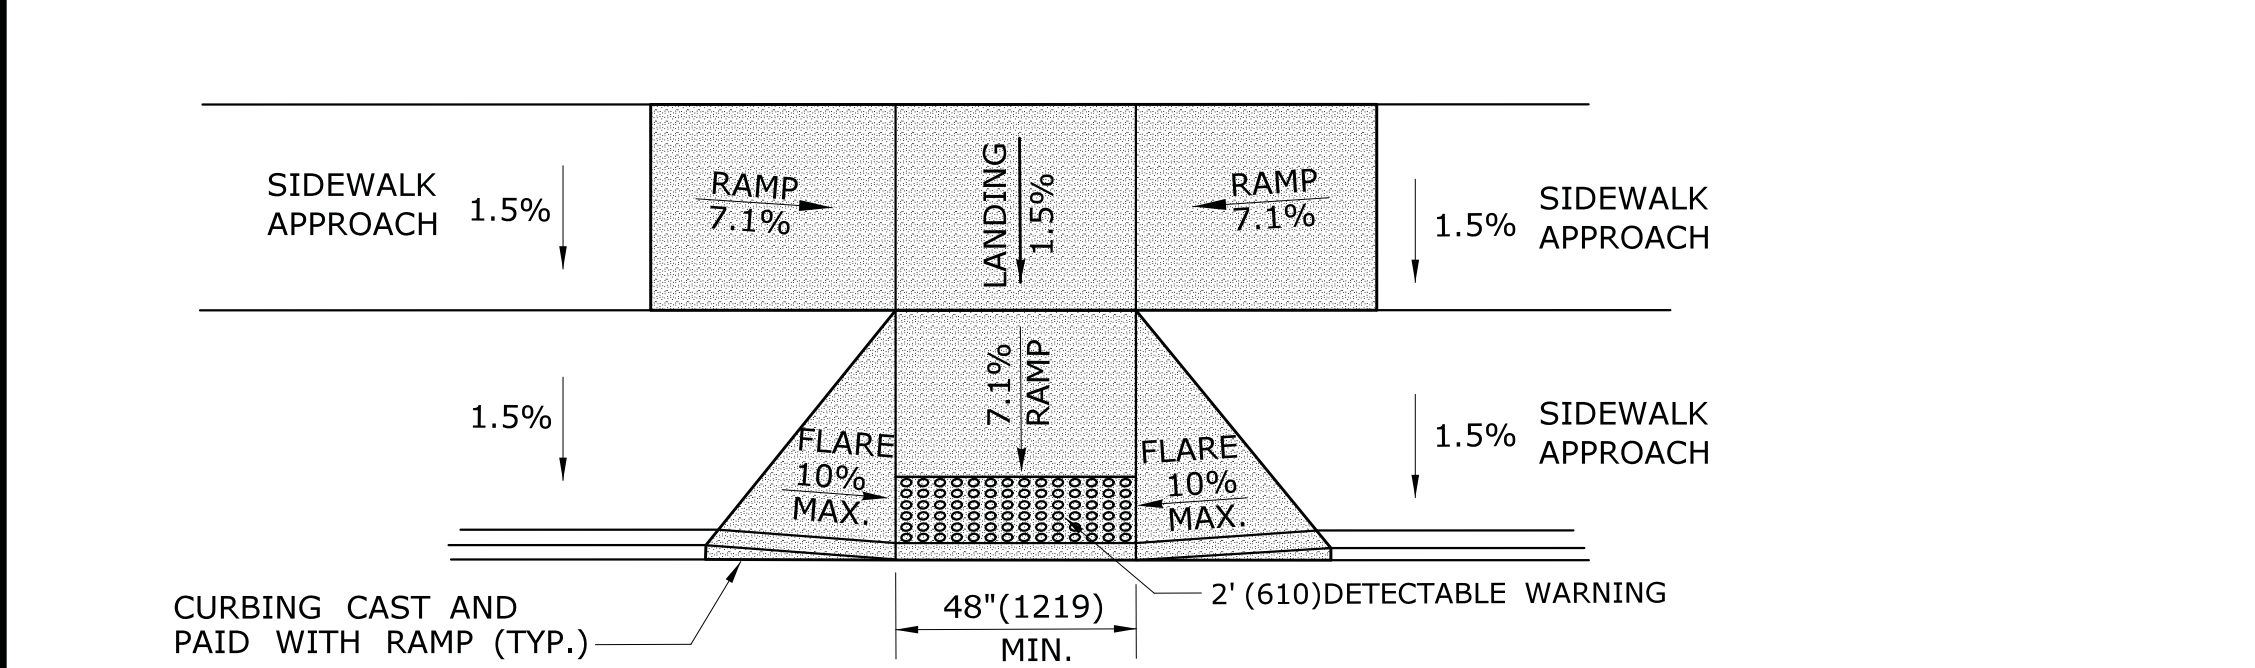

PARALLEL SIDEWALK RAMP (TYPE 1c)
WITH UTILITY / GRASS STRIP

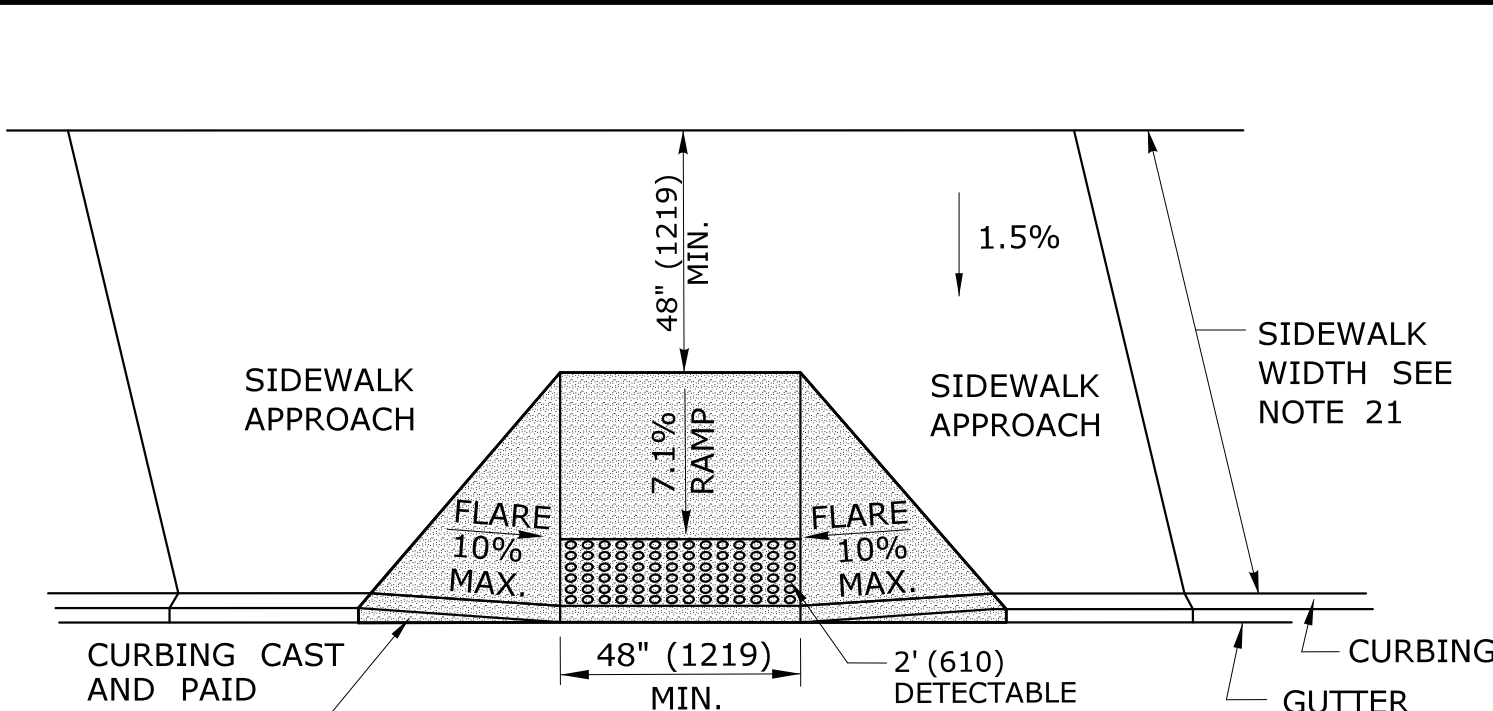


PERPENDICULAR SIDEWALK RAMP
W/ 48" (1219) MIN. BY PASS LANDING (TYPE 2)

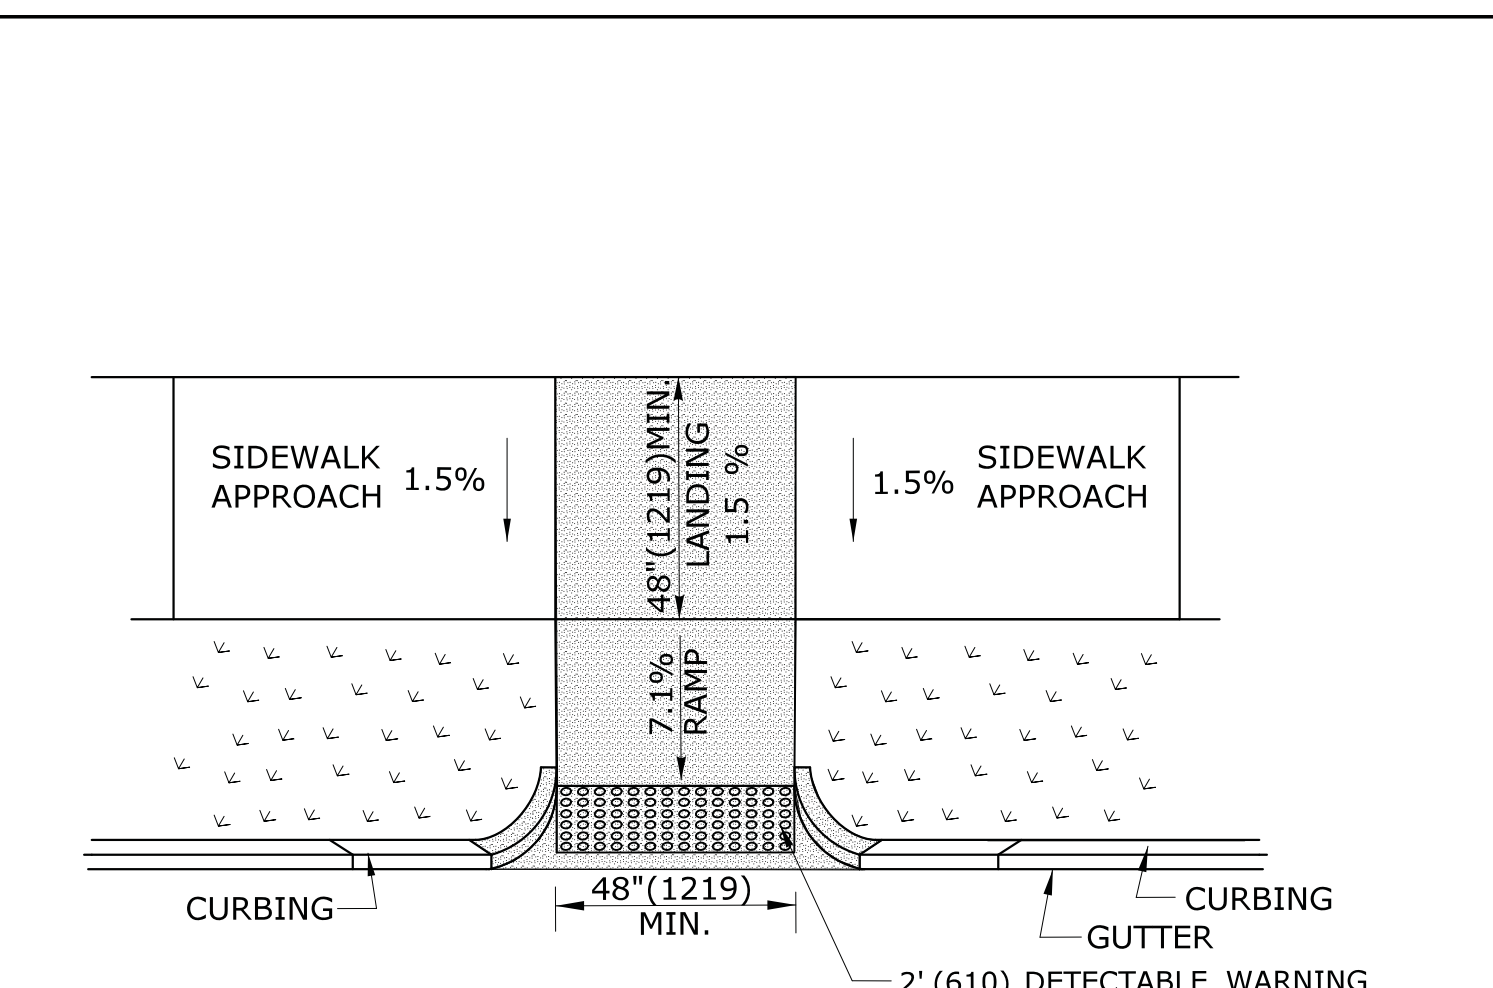

PERPENDICULAR SIDEWALK RAMP
W/CURB RETURNS / UTILITY GRASS STRIP (TYPE 2a)

* OPTIONAL FLARE ONE SIDE OF RAMP

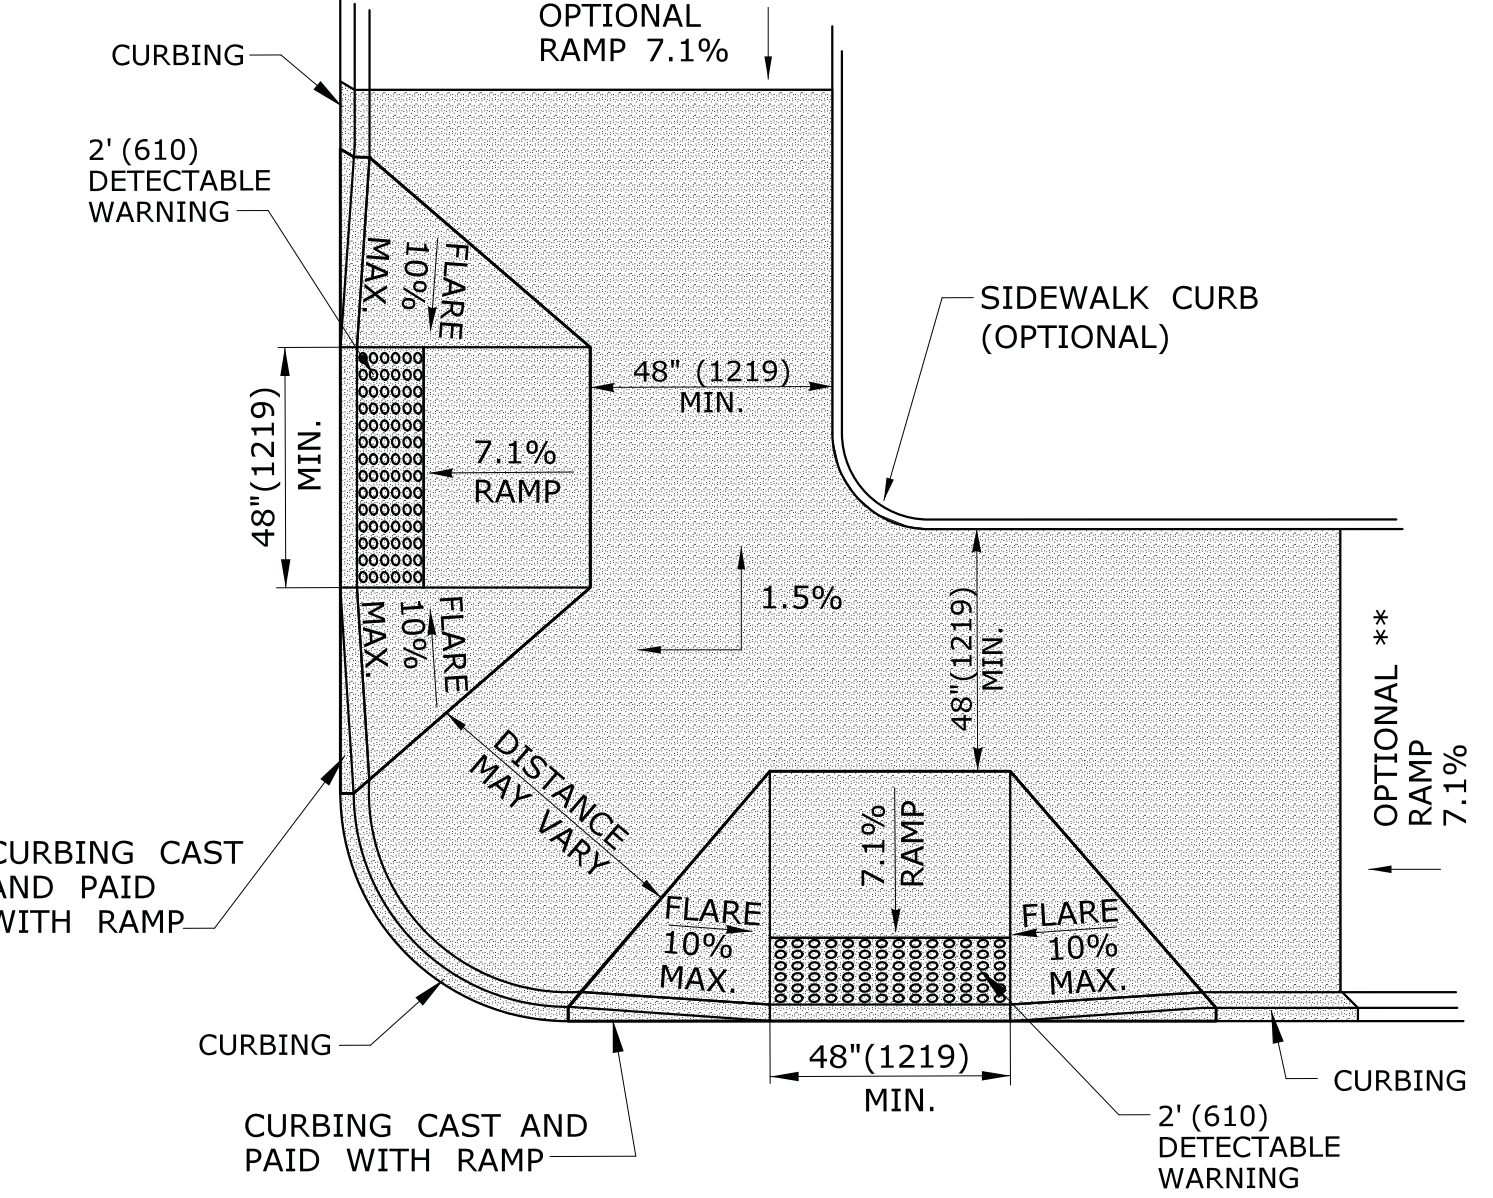


DUAL PERPENDICULAR
SIDEWALK RAMPS (TYPE 3)

SEE NOTES 19
* OPTIONAL CURB RETURN ON ONE SIDE OF RAMP
** SEE NOTE 23

GENERAL NOTES:

1. MAXIMUM SLOPES OF ADJOINING GUTTERS AND ROAD SURFACES IMMEDIATELY ADJACENT TO THE SIDEWALK RAMP SHOULD NOT EXCEED 5%. THE MAXIMUM GRADE DIFFERENCE BETWEEN THE GUTTER AND CURB RAMP SHALL NOT EXCEED 13%. SEE DETAIL 1 ON SHEET 4.
2. RAMP GRADE SHALL BE UNIFORM, FREE OF SAGS AND ABRUPT GRADE CHANGES. RUNNING SLOPES OF RAMPS SHALL NOT EXCEED 8.33% AND SHALL NOT EXCEED 15' (4.5m) WITHOUT PROVIDING A LANDING.
3. ALL RAMPS SHALL BE CONSTRUCTED OF CLASS "F" CONCRETE IN ACCORDANCE WITH CONNECTICUT STANDARD SPECIFICATIONS.
4. SIDEWALK RAMPS SHALL HAVE A COARSE BROOM FINISH TRANSVERSE TO THE SLOPE OF THE RAMP. THE SURFACE OF ALL SIDEWALK RAMPS SHALL BE STABLE, FIRM AND SLIP RESISTANT. SURFACE DISCONTINUITIES SHALL NOT EXCEED 1/2" (13) MAX. VERTICAL DISCONTINUITIES BETWEEN 1/4" (6.4) AND 1/2" (13) MAX. SHALL BE BEVELED 1:2 MINIMUM APPLIED ACROSS THE ENTIRE LEVEL CHANGE.
5. DIAGONAL SIDEWALK RAMPS AT MARKED CROSSINGS SHALL BE WHOLLY CONTAINED WITHIN THE MARKINGS, EXCLUDING ANY FLARED SIDES. DIAGONAL AND PERPENDICULAR RAMPS SHALL HAVE THE RAMP CUT PERPENDICULAR TO THE TANGENT OF THE CURB RADIUS FOR THE DESIGNATED ACCESSIBLE ROUTE. BOTH LONGITUDINAL SIDES OF THE RAMP SHOULD BE THE SAME LENGTH. SKEWED RAMPS SHOULD BE AVOIDED. FLARES ARE NOT CONSIDERED PART OF PEDESTRIAN ACCESS ROUTE. DIAGONAL RAMPS SHOULD NOT BE INSTALLED WHERE CURB RADII IS LESS THAN 20'(6096).
6. REMOVAL OF EXISTING SIDEWALK FOR NEW RAMP INSTALLATIONS SHALL BE TO THE NEAREST EXPANSION OR CONTRACTION JOINT. 8.3% MAXIMUM SLOPE MAY NOT BE ACHIEVABLE DUE TO EXISTING SIDEWALK GRADE. IN RECOGNITION OF THIS, A LIMIT OF 15' (4572) FOR REMOVAL SHALL BE USED UNLESS OTHERWISE SHOWN ON THE PLANS OR DIRECTED BY THE ENGINEER. SAW CUT REQUIRED FOR DUMMY JOINTS SHALL BE INCLUDED IN THE COST OF "CONCRETE SIDEWALK RAMP" OR "CONCRETE SIDEWALK".
7. EXPANSION JOINTS IN CONCRETE SHALL MATCH THOSE IN ADJACENT SIDEWALKS BUT IN NO CASE SHALL THE SPACING BETWEEN EXPANSION JOINTS EXCEED 12' (3658) UNLESS OTHERWISE NOTED.
8. CONCRETE SIDEWALK RAMPS, SHALL BE PAID FOR UNDER THE ITEM "CONCRETE SIDEWALK RAMP", AS DEFINED BY THE CONSTRUCTION LIMITS ON THE PLANS AND SHALL BE FIELD VERIFIED.
9. SIDEWALK RAMPS SHALL BE CONSTRUCTED WITH THE TOE AT THE GUTTER CAST INTEGRALLY WITH RAMP UNLESS DIRECTED OTHERWISE BY THE ENGINEER (SEE TYPICAL SECTION ON SHEET 3). CURB REMOVAL AND CAST IN PLACE CURBING REQUIRED FOR THE RAMP, SHALL BE INCLUDED WITH PAY ITEM "CONCRETE SIDEWALK RAMP". CURBING OUTSIDE LIMITS OF RAMP OR LANDING SHOWN ON SHEET 3 SHALL BE CONSTRUCTED AND PAID FOR IN ACCORDANCE WITH CONNECTICUT STANDARD SPECIFICATIONS.
10. PREFERRED LOCATION TO INSTALL DETECTABLE WARNING STRIP SHALL BE 6" (152) FROM THE EDGE OF ROAD ALONG THE FULL WIDTH OF THE RAMP. FOR ALTERNATE LOCATIONS, REFER TO DETECTABLE WARNING PLACEMENT DETAILS ON SHEET 4.
11. TO PERMIT WHEELCHAIR WHEELS TO ROLL BETWEEN DOMES, ALIGN DOMES ON A SQUARE GRID IN THE DIRECTION OF RUNNING SLOPE (PERPENDICULAR TO CURB OR SLOPE BREAK). THE TRANSITION FROM RAMP TO GUTTER SHALL BE FLUSH WITHOUT A LIP.
12. WHERE COMMERCIAL DRIVEWAYS ARE PROVIDED WITH TRAFFIC SIGNALS AND THE SIDEWALK IS CONTINUOUS THROUGH DRIVEWAY, DETECTABLE WARNINGS ARE REQUIRED AT THE JUNCTION BETWEEN THE PEDESTRIAN ROUTE AND DRIVEWAY.
13. CONSTRUCT A SIDEWALK CURB WHEN THERE IS INSUFFICIENT BUFFER AVAILABLE TO GRADE OR WHEN CALLED FOR IN PLANS. PAID FOR WITH SIDEWALK RAMP WHEN REQUIRED FOR RAMP.
14. THE TOP AND BOTTOM OF RAMPS SHOULD BE PROVIDED WITH A 4' x 4' (1219 x 1219) MINIMUM LEVEL LANDING AREA WITH A CROSS SLOPE LESS THAN OR EQUAL TO 2% IN ANY DIRECTION.
15. UTILITY POLES, LUMINAIRE, PEDESTRIAN OR SIGNAL POLES, GRATES, ACCESS COVERS, AND OTHER APPURTENANCES SHALL NOT BE LOCATED ON RAMPS, LANDINGS, BLENDED TRANSITIONS, AND @ GUTTERS WITHIN THE PEDESTRIAN ACCESS ROUTE.
16. APPROACH SIDEWALK WIDTHS, GRASS STRIP OR UTILITY STRIP WIDTHS MAY VARY.
17. APPROACH SIDEWALK AND LANDING CROSS SLOPE SHALL NOT EXCEED 2%.
18. THE RUNNING OR CROSS SLOPES ON LANDINGS AT MID BLOCK CROSSING MAY BE WARPED TO MEET STREET OR HIGHWAY GRADE.
19. FOR PERPENDICULAR CURB RAMPS A MIN. 4'(1.2m) x 4'(1.2m) LEVEL LANDING SHALL BE PROVIDED AT THE TOP OF CURB RAMP. WHERE THE LEVEL LANDING IS RESTRICTED AT THE BACK OF SIDEWALK THE LEVEL LANDING SHALL BE 4'(1.2m) x 5'(1.5m) WITH THE 5'(1.5m) DIMENSION PROVIDED IN THE DIRECTION OF THE RAMP RUN.
20. FOR PARALLEL CURB RAMPS, A MIN. 4'(1.2m) x 4'(1.2m) LEVEL LANDING SHALL BE PROVIDED AT THE BOTTOM OF CURB RAMP. IF THE LEVEL LANDING IS RESTRICTED ON 2 OR MORE SIDES, THE LEVEL LANDING SHALL BE 4'(1.2m) x 5'(1.5m) WITH THE 5'(1.5m) DIMENSION PROVIDED IN THE DIRECTION OF THE PEDESTRIAN STREET CROSSING.
21. WHEN WIDTH OF SIDEWALK IS ≥48" AND A PERPENDICULAR SIDEWALK RAMP IS INSTALLED, THE FLARED SIDES SHALL BE 10% MAX. IF WIDTH OF SIDEWALK IS <48" THE FLARED SIDES MUST NOT EXCEED 8.33% (12:1).
22. SHADED AREAS ARE TYPICAL PAY LIMITS FOR CONCRETE SIDEWALK RAMP BUT, MAY VARY AS DIRECTED BY THE ENGINEER.
23. OPTIONAL RAMP, WHEN REQUIRED, SHALL BE PAID FOR AS PART OF CONCRETE SIDEWALK RAMP.

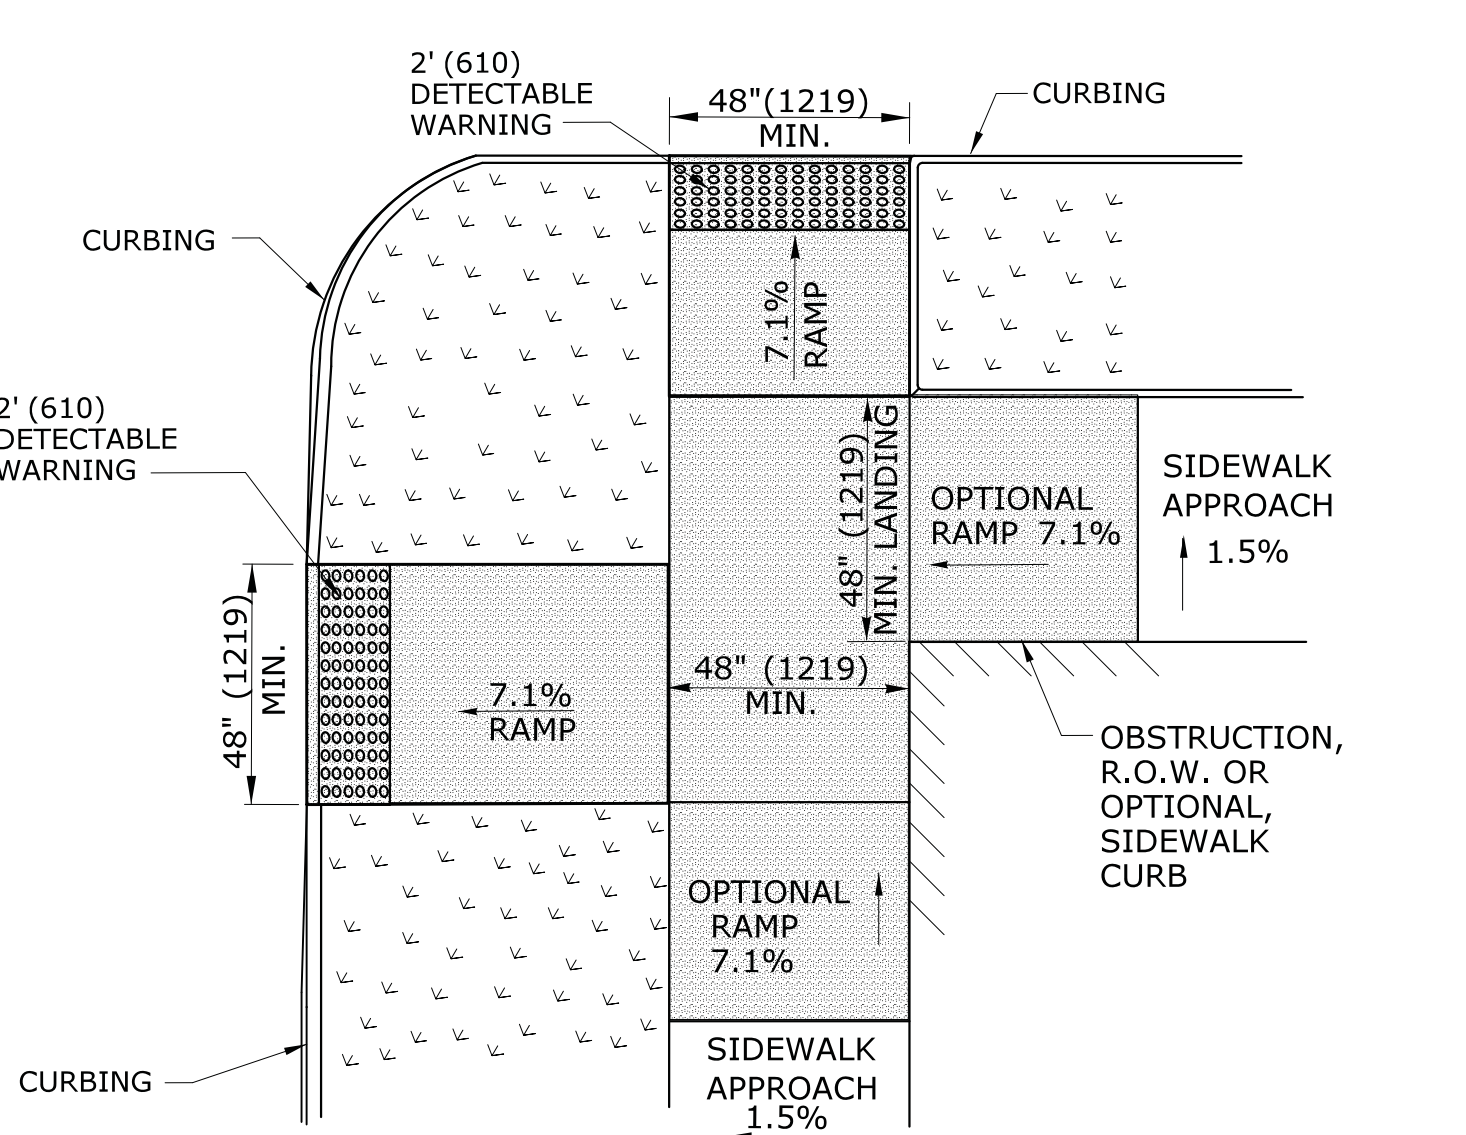

DUAL PERPENDICULAR SIDEWALK RAMPS (TYPE 3a)
WITH UTILITY / GRASS STRIP

SEE NOTE 20

ALL METRIC DIMENSIONS ARE IN MILLIMETERS (mm) UNLESS OTHERWISE NOTED.

1	7/13	Created new sheets (4 total).		
REV.	DATE	REVISION DESCRIPTION	SHEET NO.	Plotted Date: 6/17/2014

DESIGNER/DRAFTER:
MGB/EMK
CHECKED BY:
LLF

 **STATE OF CONNECTICUT**
DEPARTMENT OF TRANSPORTATION

Filename: ...SIDEWALK RAMP 1.GD.dgn

SIGNATURE/
BLOCK:
OFFICE OF ENGINEERING
APPROVED BY:

PROJECT TITLE:


TOWN:

DRAWING TITLE:
**SIDEWALK RAMPS
SHEET 1**


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DRAWING NO.


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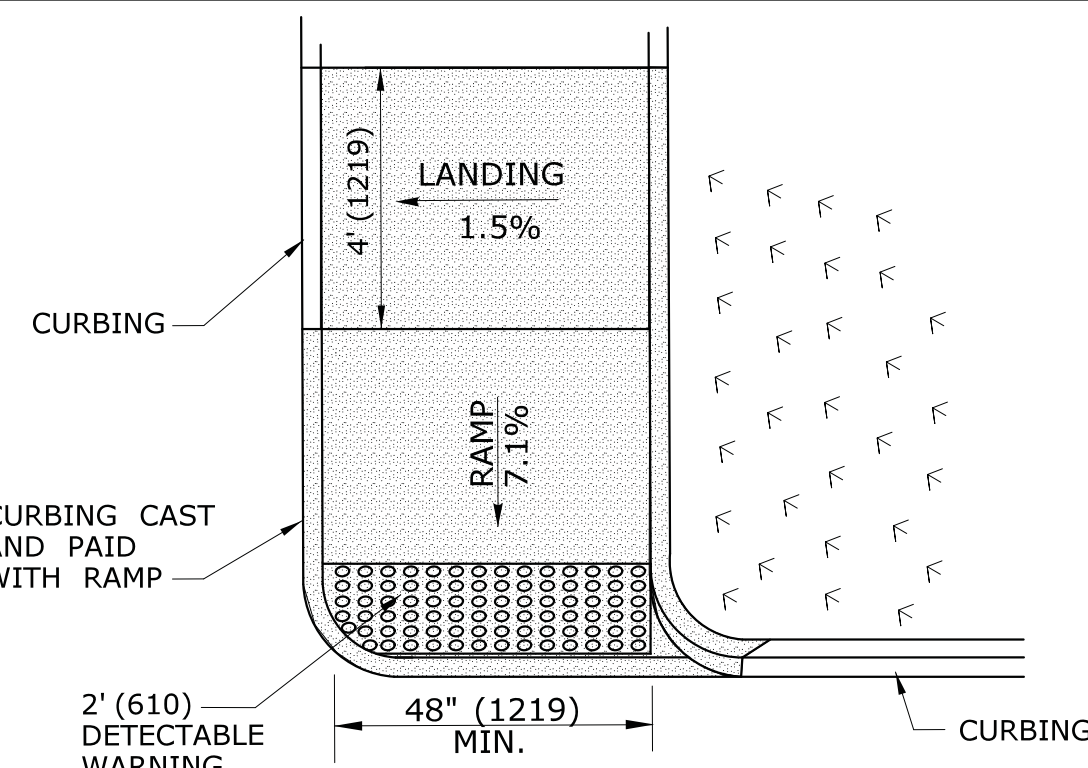
**DIAGONAL SIDEWALK RAMP (TYPE 4)
W/LANDING AT TOP**

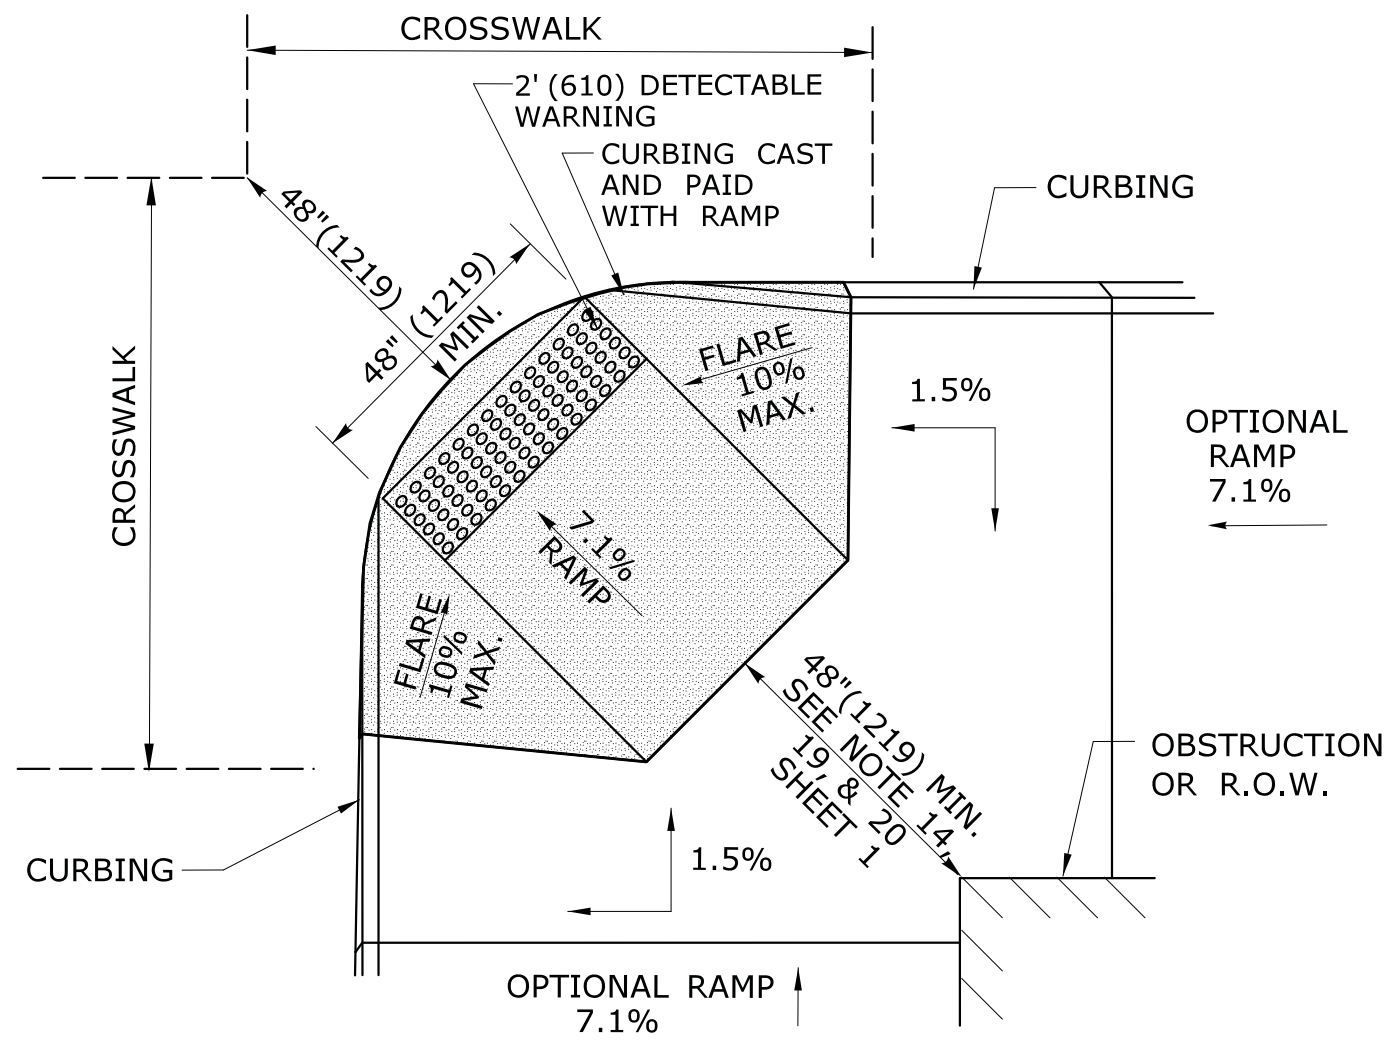


**SINGLE PARALLEL SIDEWALK RAMP
W/LANDING AT BOTTOM ON
CORNER (TYPE 4c)**
* SEE NOTE 20 SHEET 1

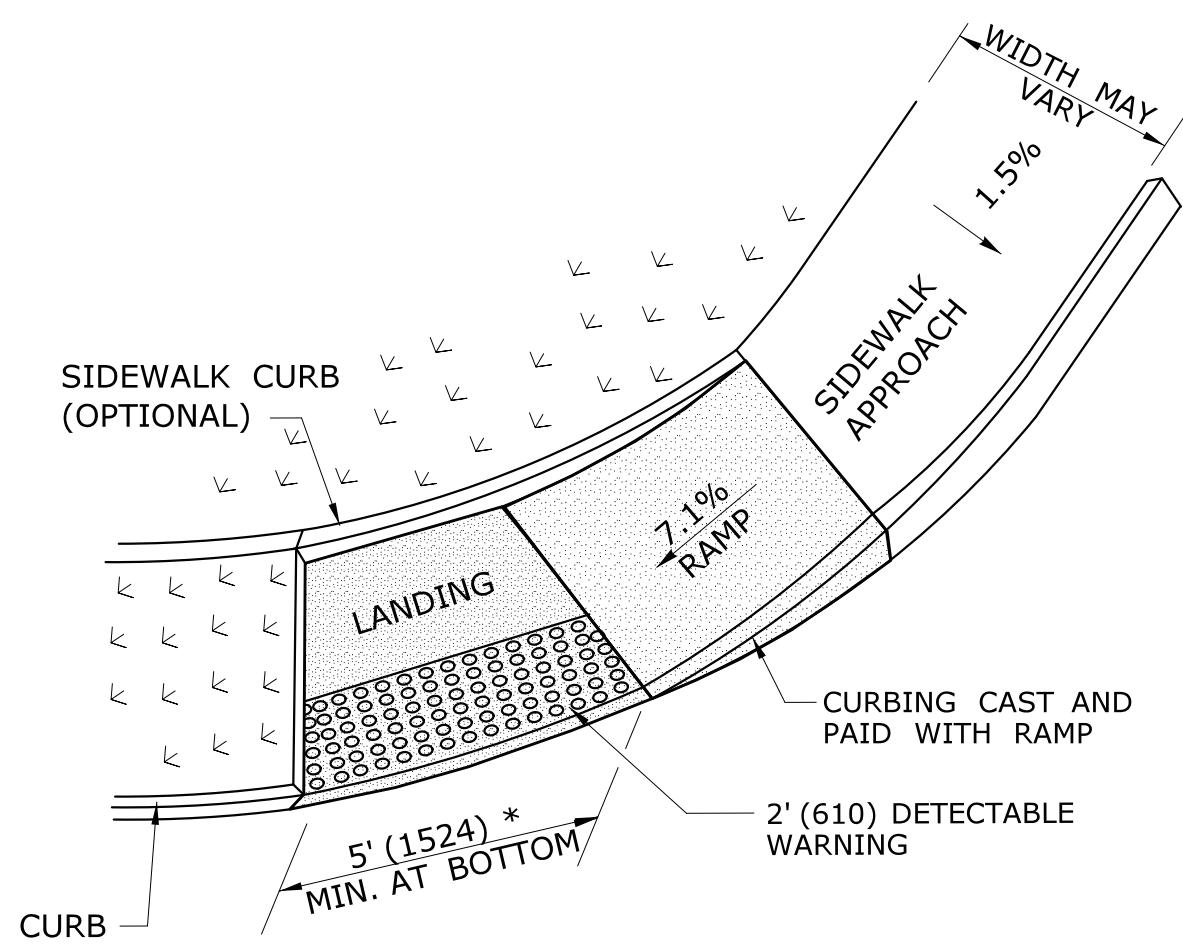


**DOUBLE PARALLEL SIDEWALK RAMP
W/LANDING AT BOTTOM ON CORNER (TYPE 4f)**
* SEE NOTE 20 SHEET 1

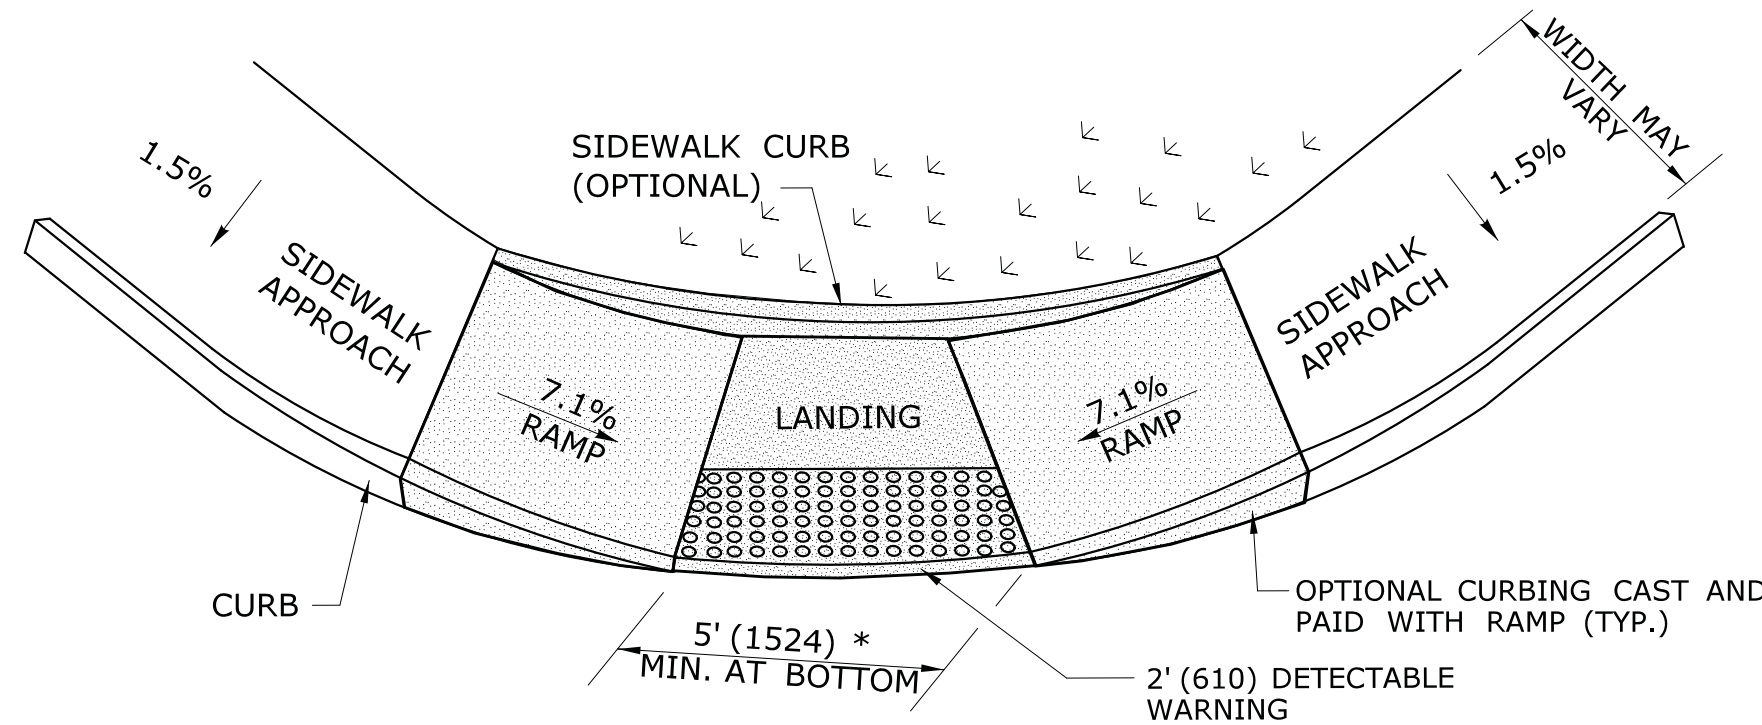


**SINGLE DIRECTION
PERPENDICULAR SIDEWALK RAMP
NO / UTILITY GRASS STRIP
(TYPE 4a)**

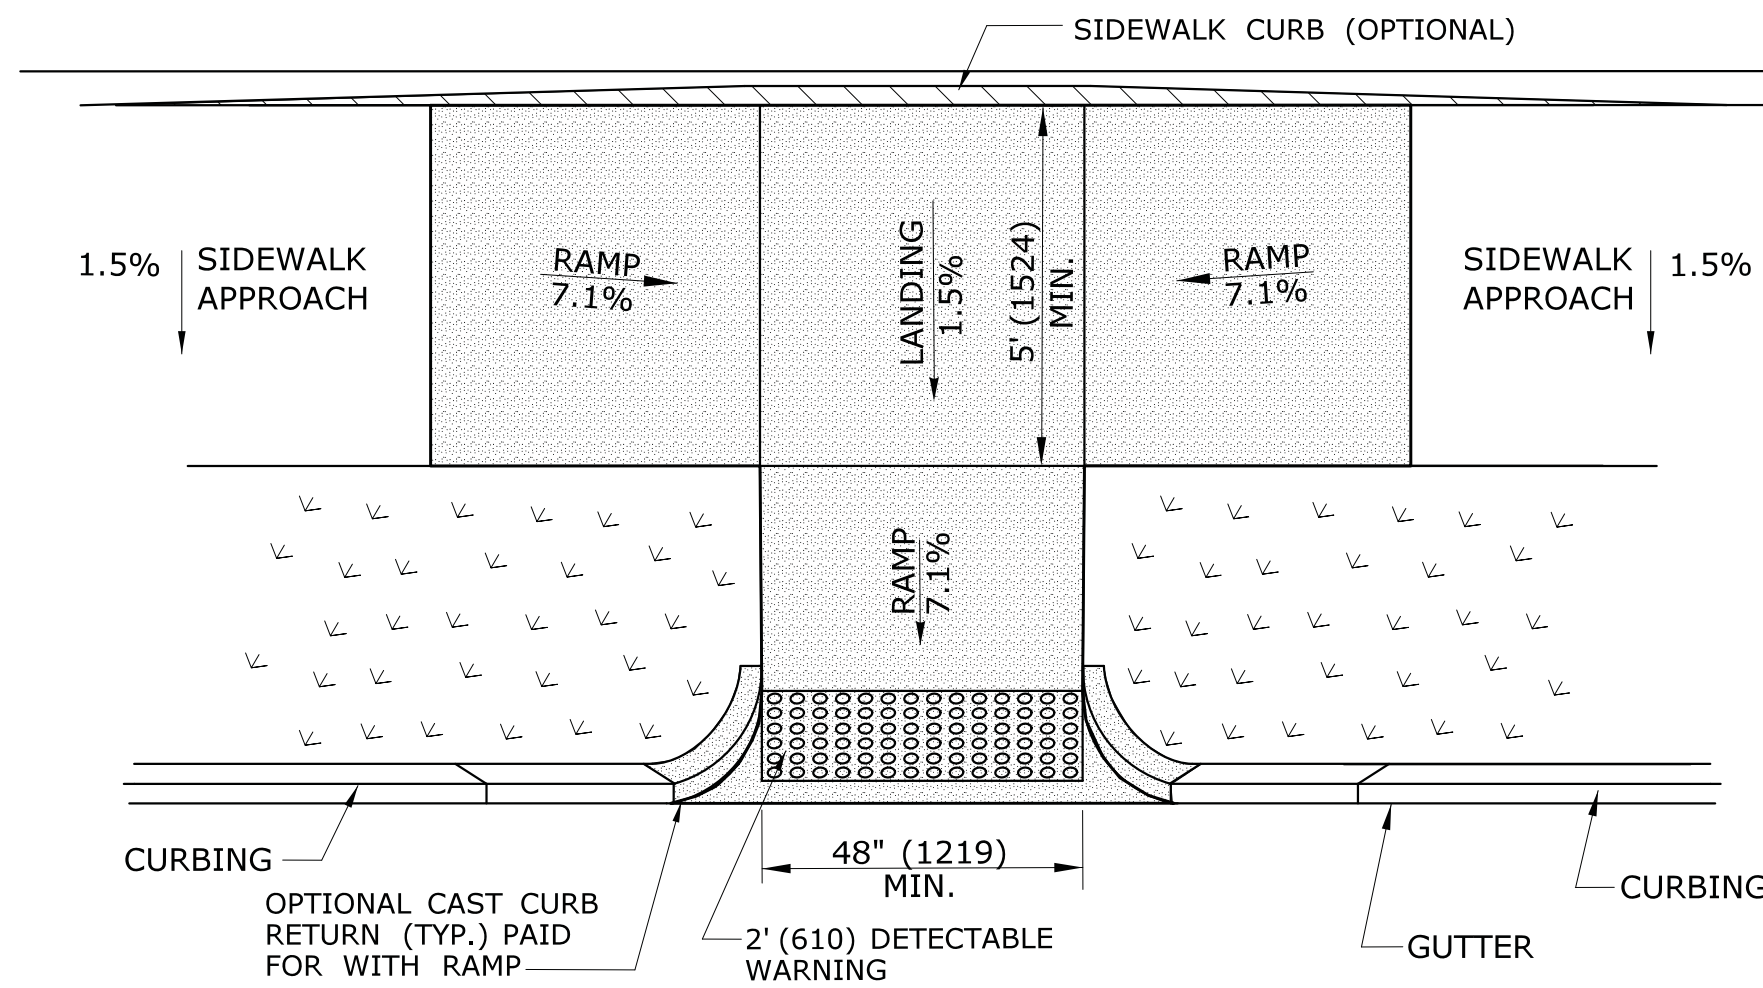


**PARALLEL/PERPENDICULAR SIDEWALK RAMP
COMBINATION W/ CURB RETURNS (TYPE 4d)**
* OPTIONAL FLARE ONE SIDE

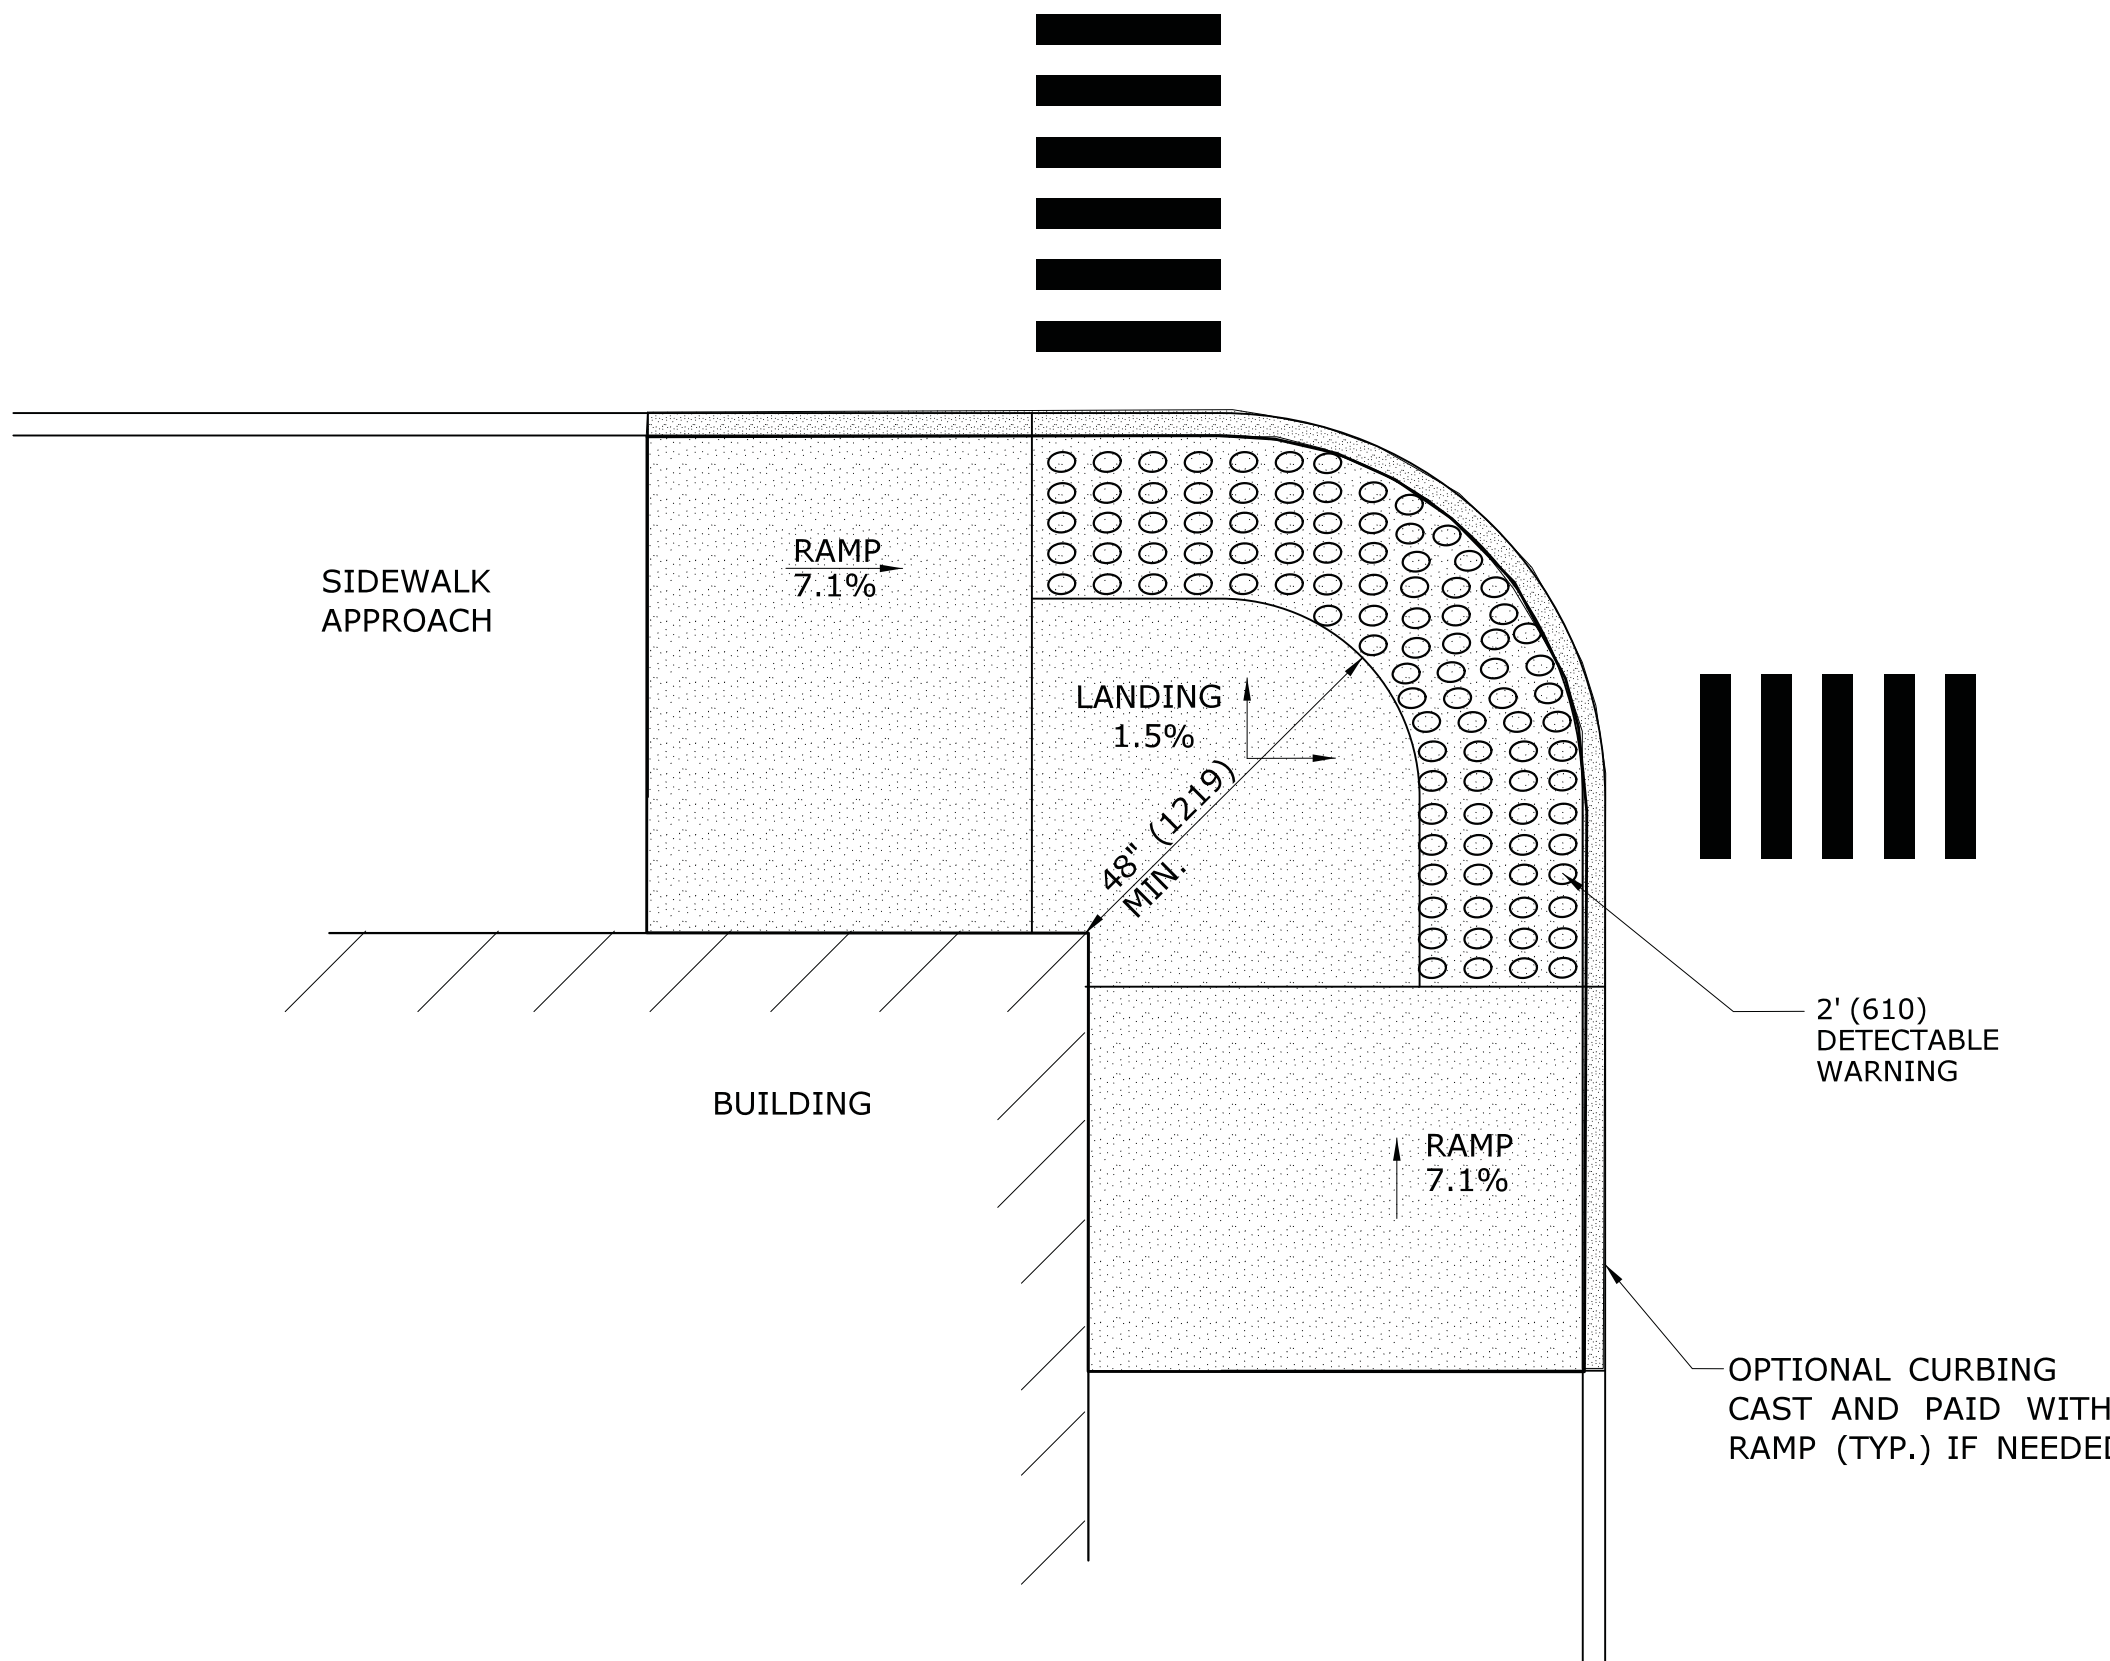

**RESTRICTED CONDITION
DIAGONAL SIDEWALK RAMP
(TYPE 4g)**

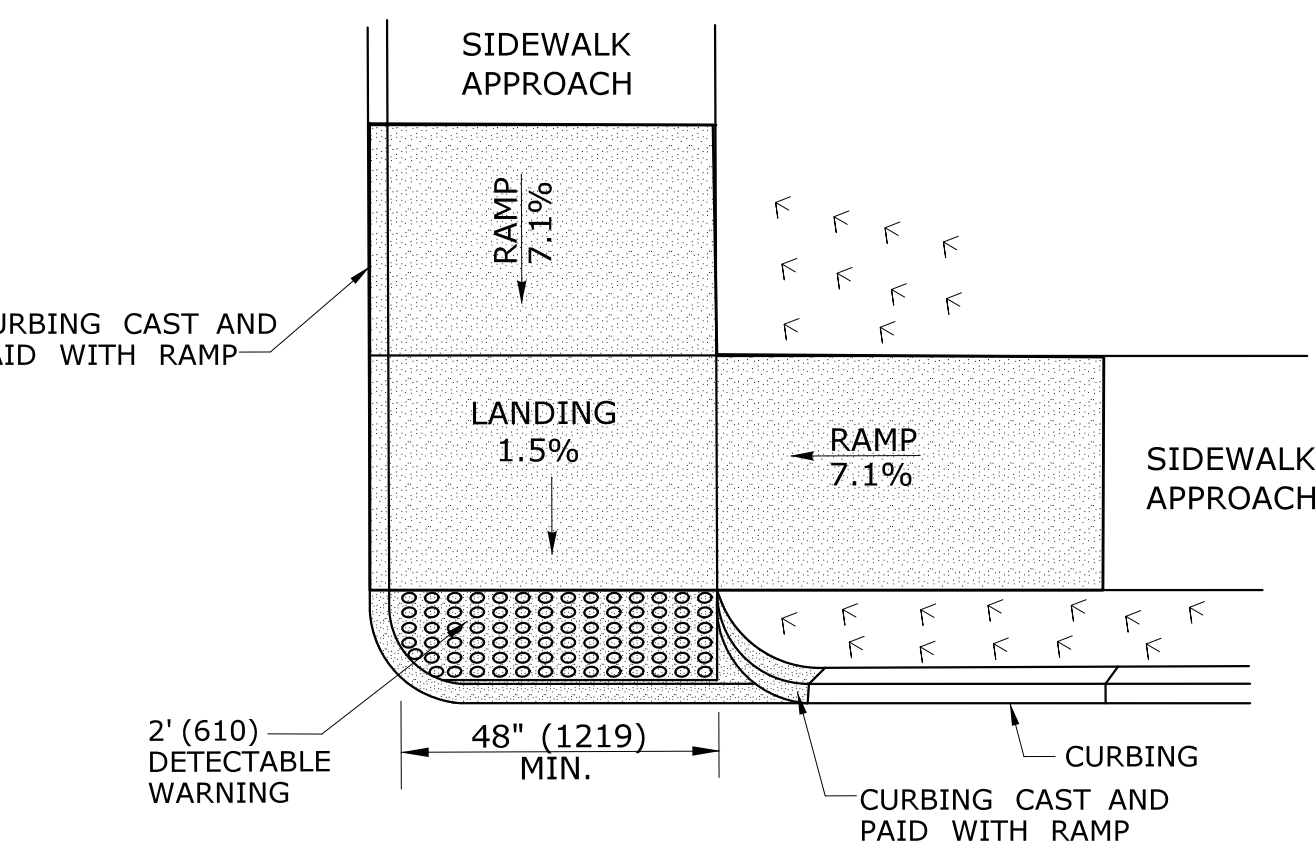

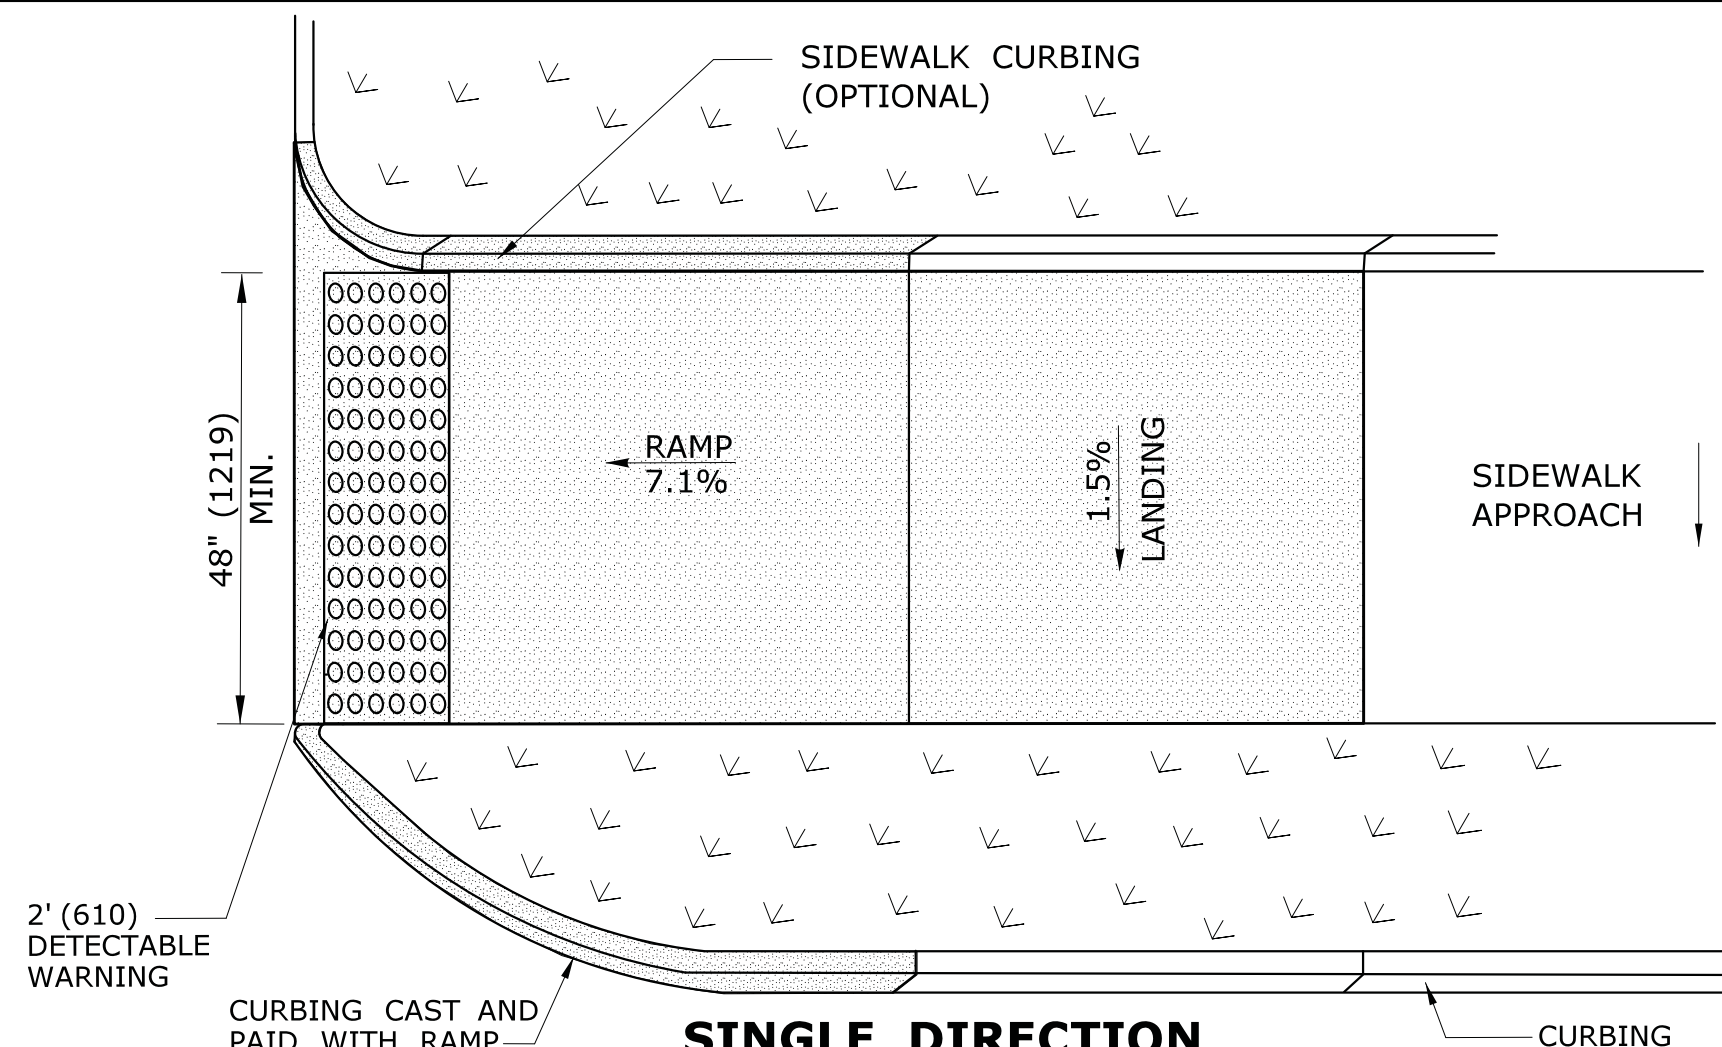










**DOUBLE DIRECTION
PARALLEL SIDEWALK RAMP
NO / UTILITY GRASS STRIP
(TYPE 4b)**
SEE NOTE 20 SHEET 1






**SINGLE DIRECTION
PERPENDICULAR SIDEWALK RAMP
W/ UTILITY GRASS STRIP (TYPE 4e)**
REFER TO DETECTABLE WARNING PLACEMENT ON SHEET 4

ALL METRIC DIMENSIONS ARE IN MILLIMETERS (mm) UNLESS OTHERWISE NOTED

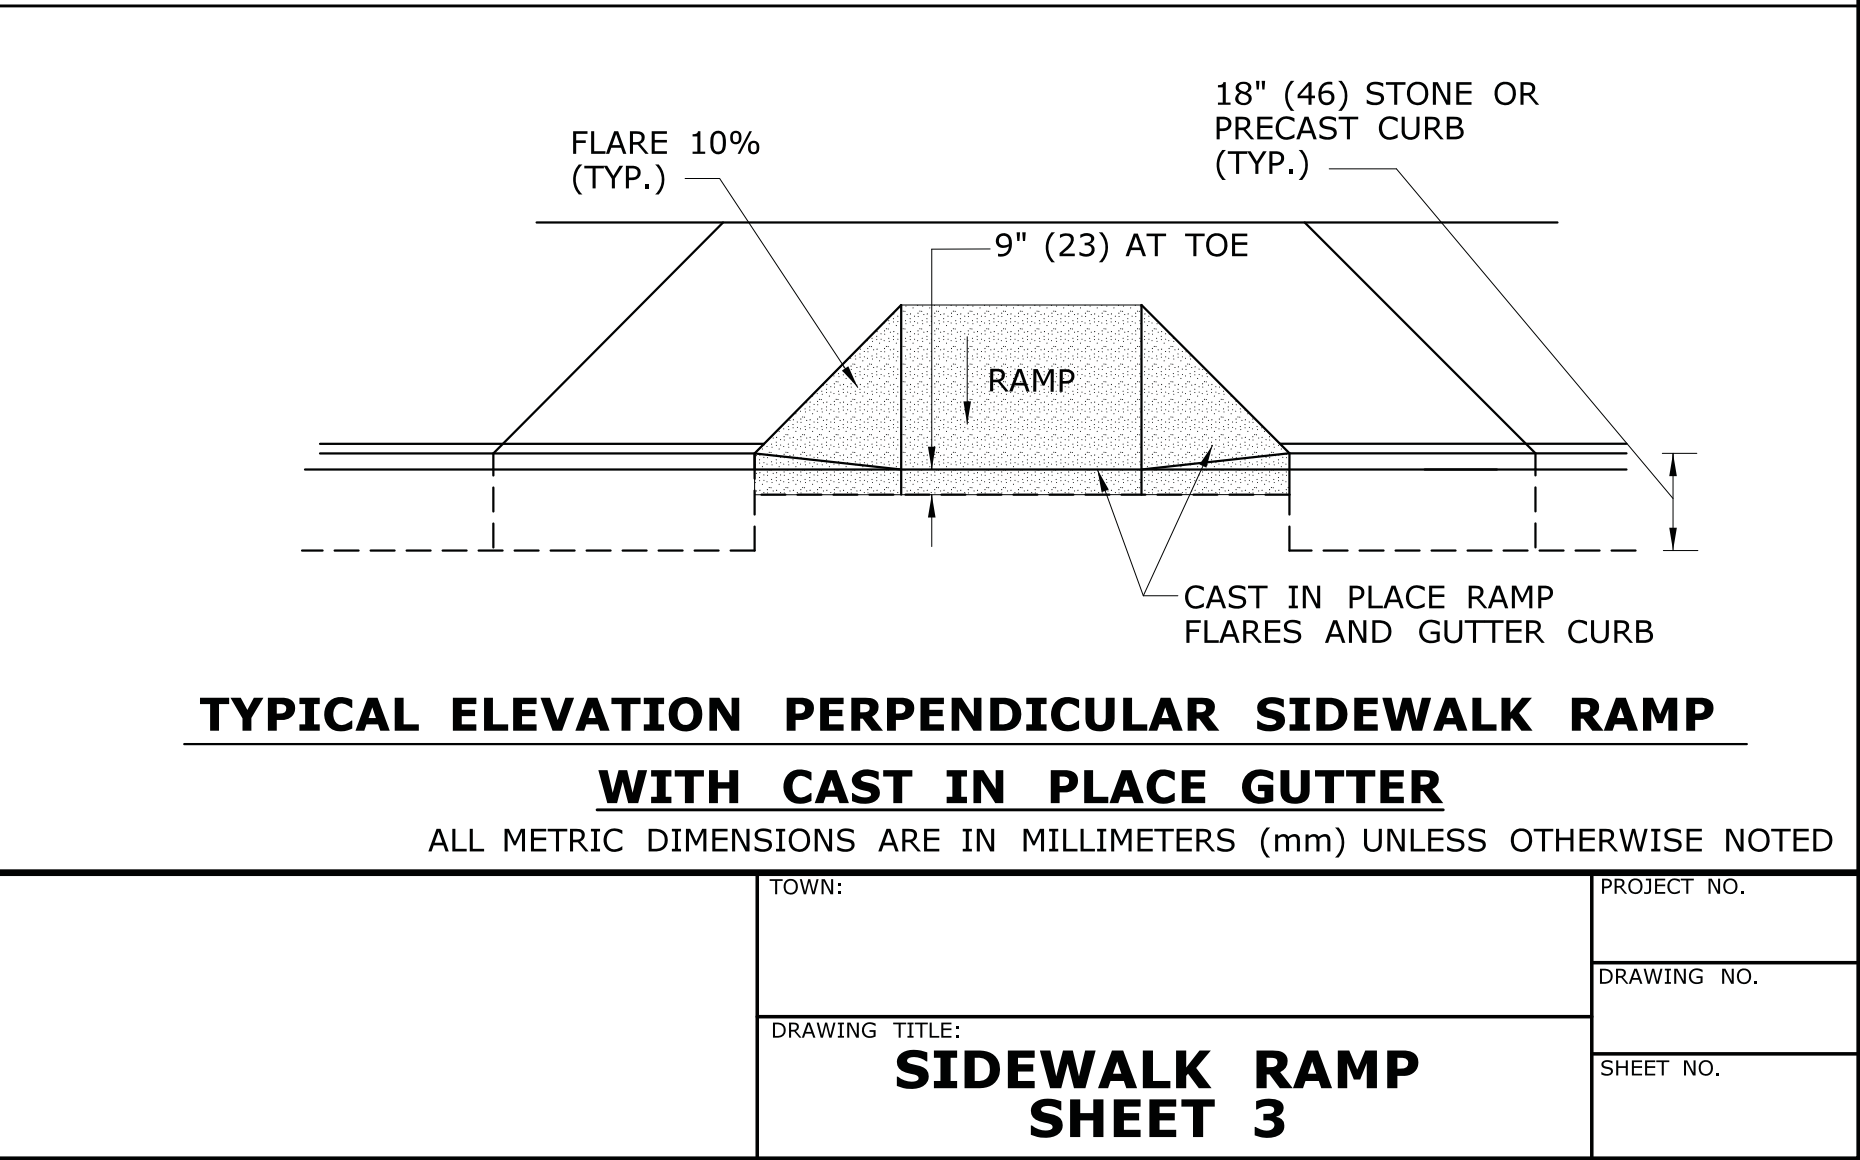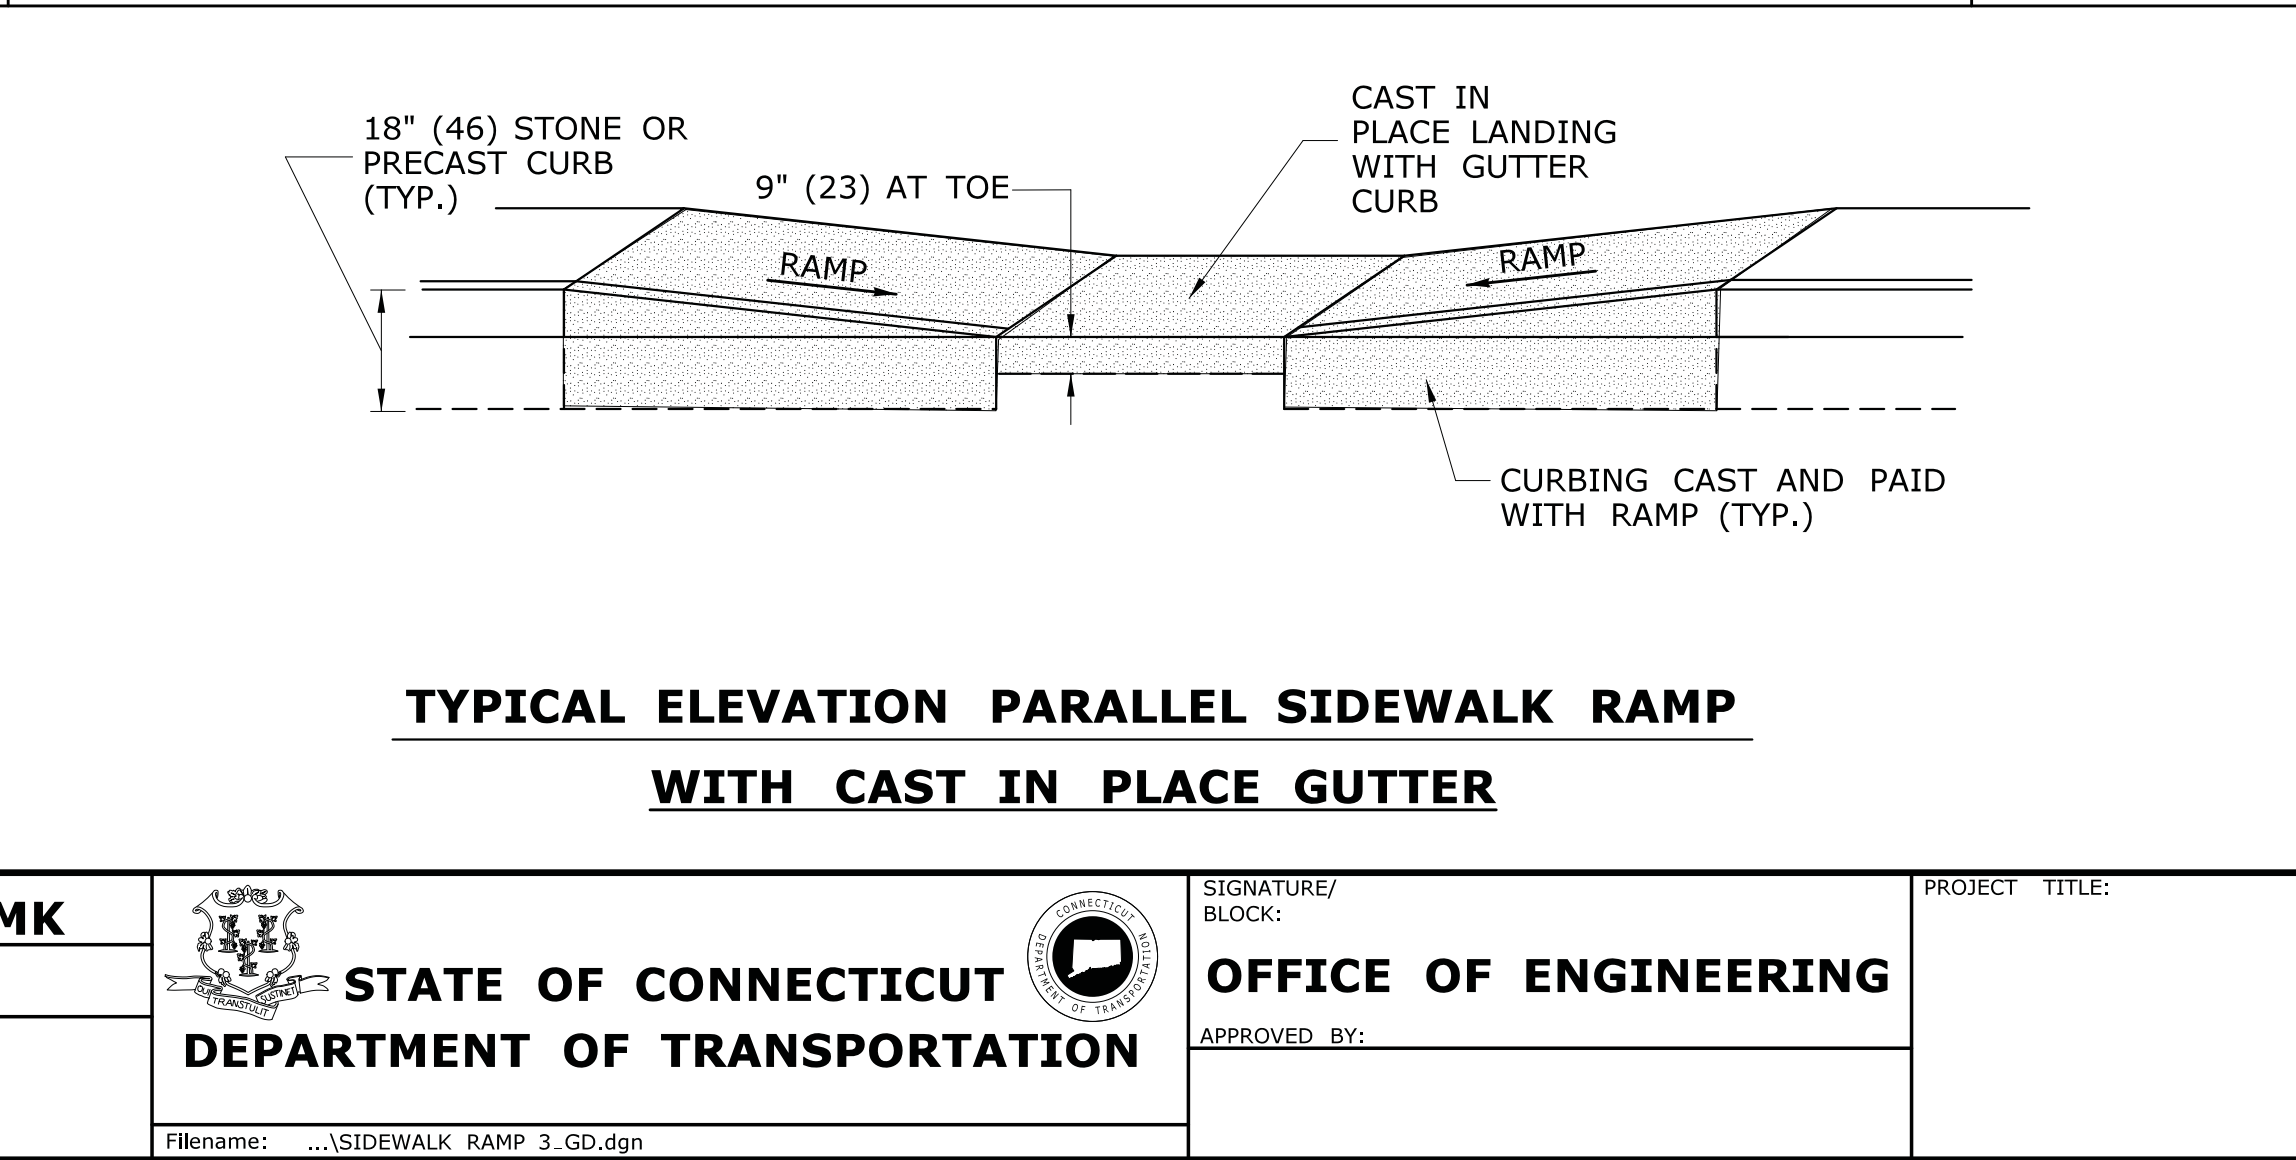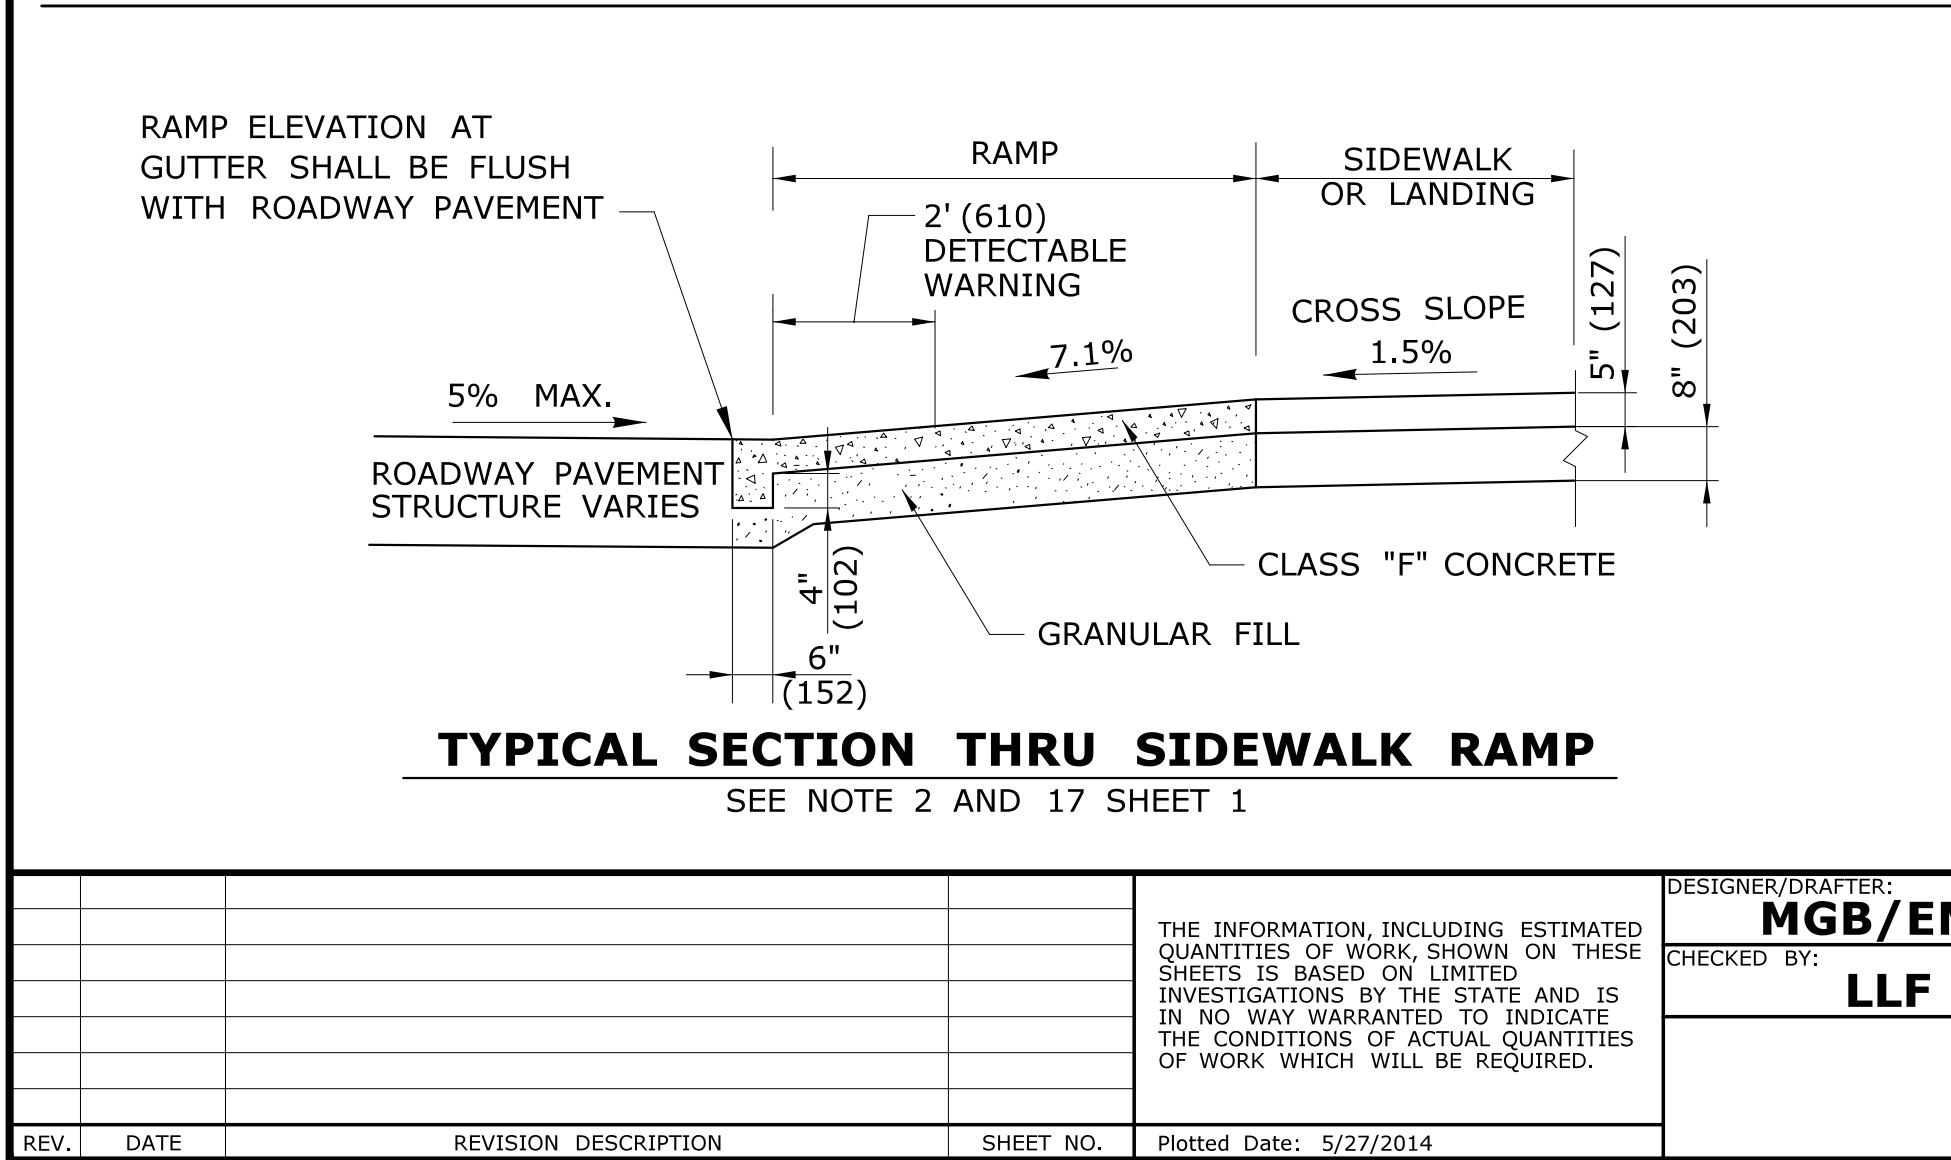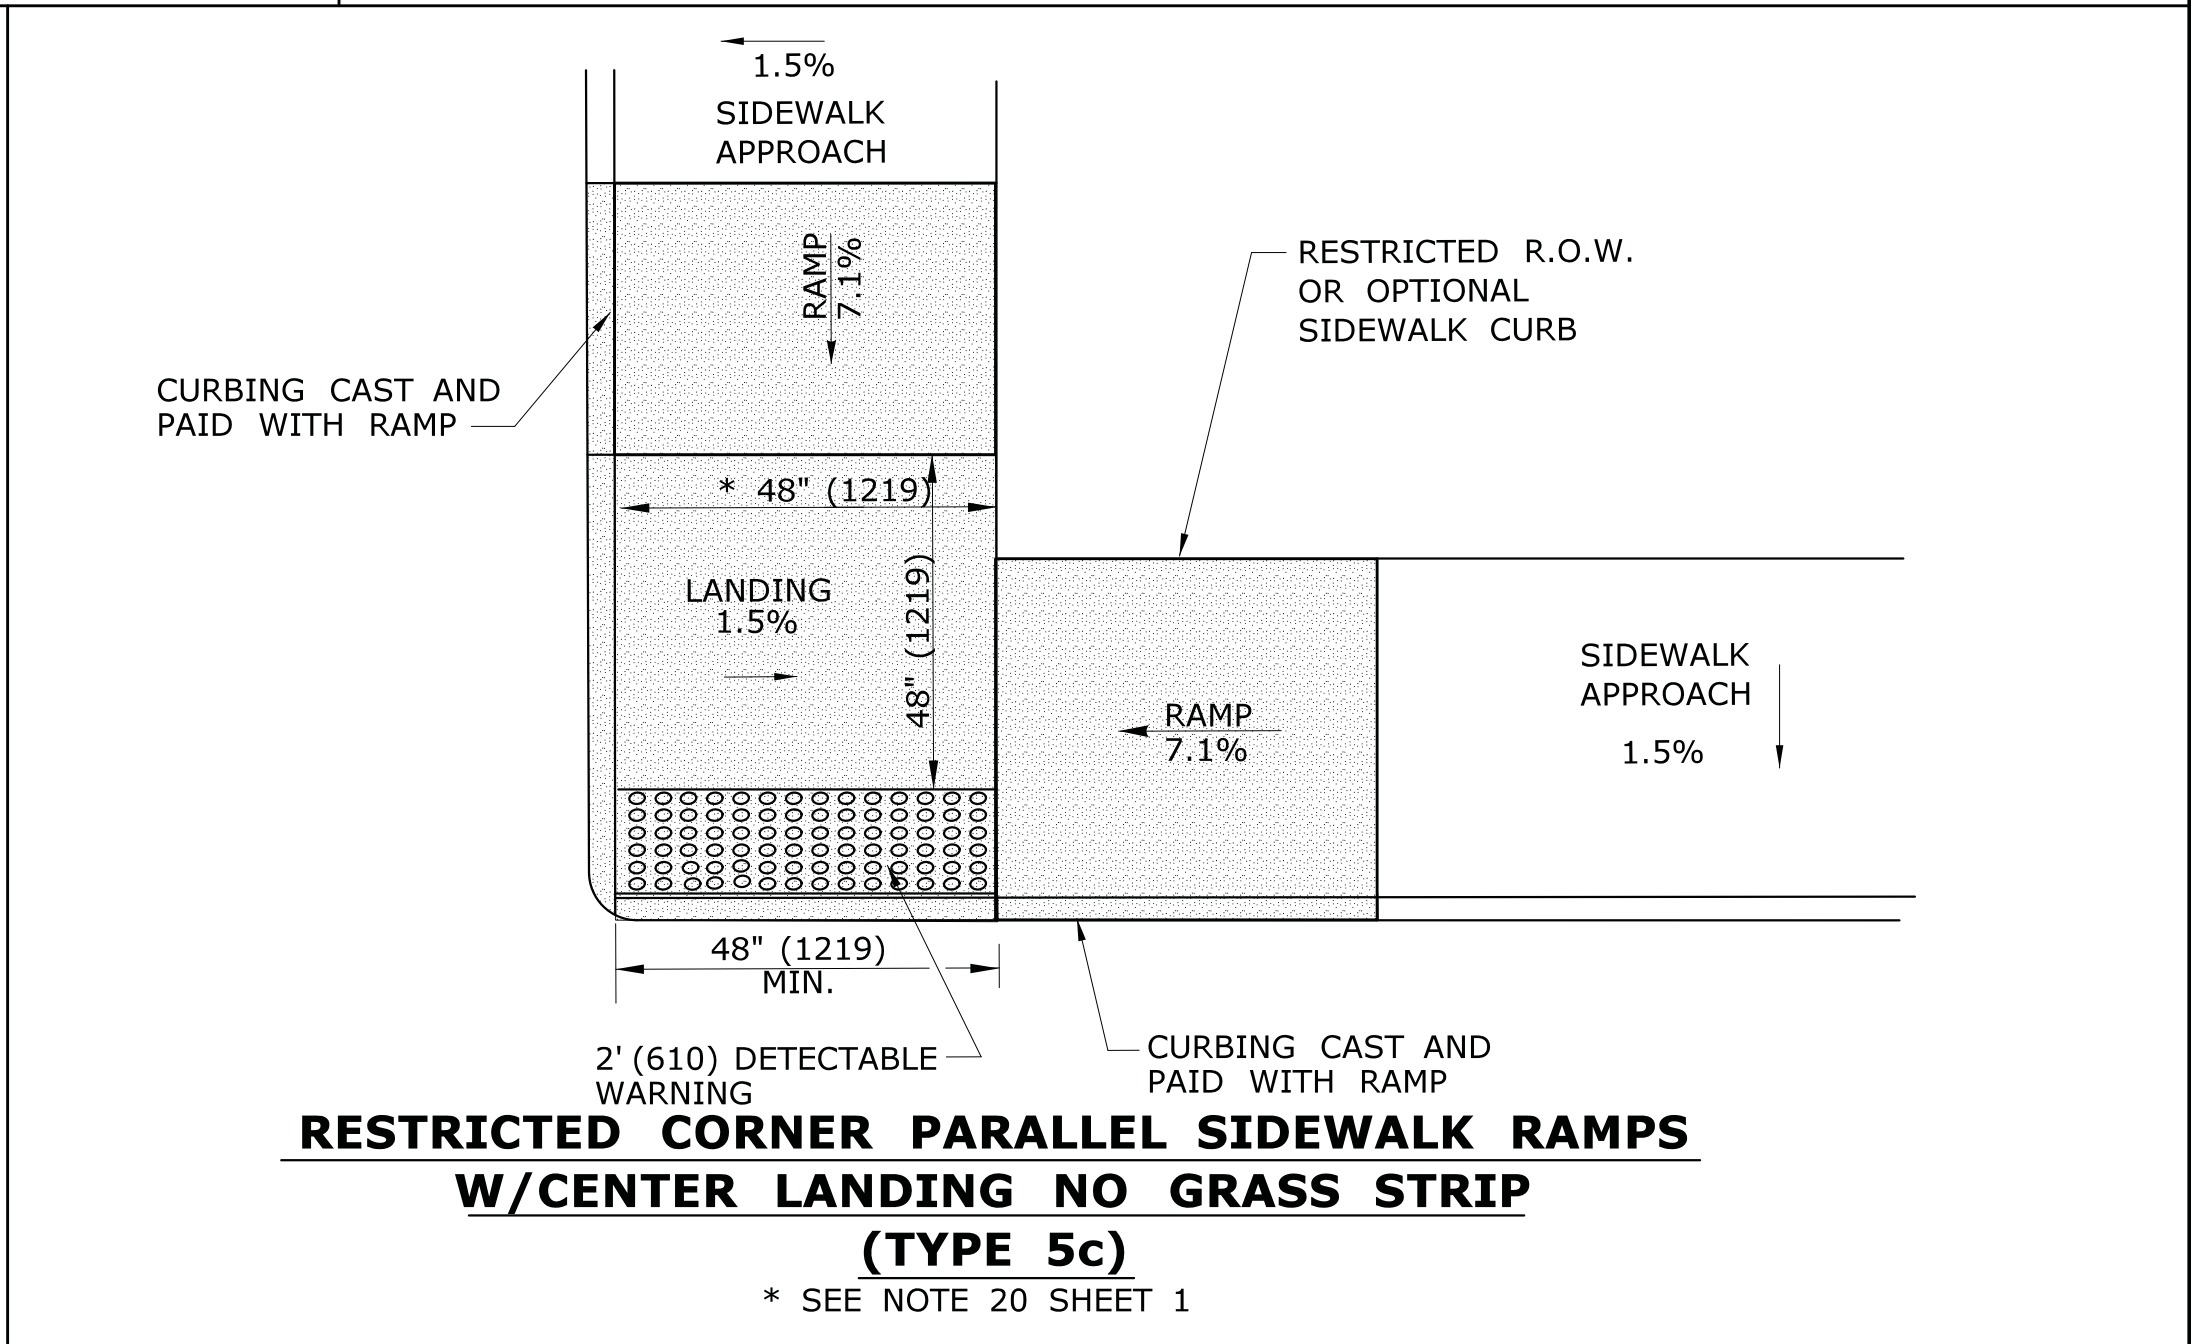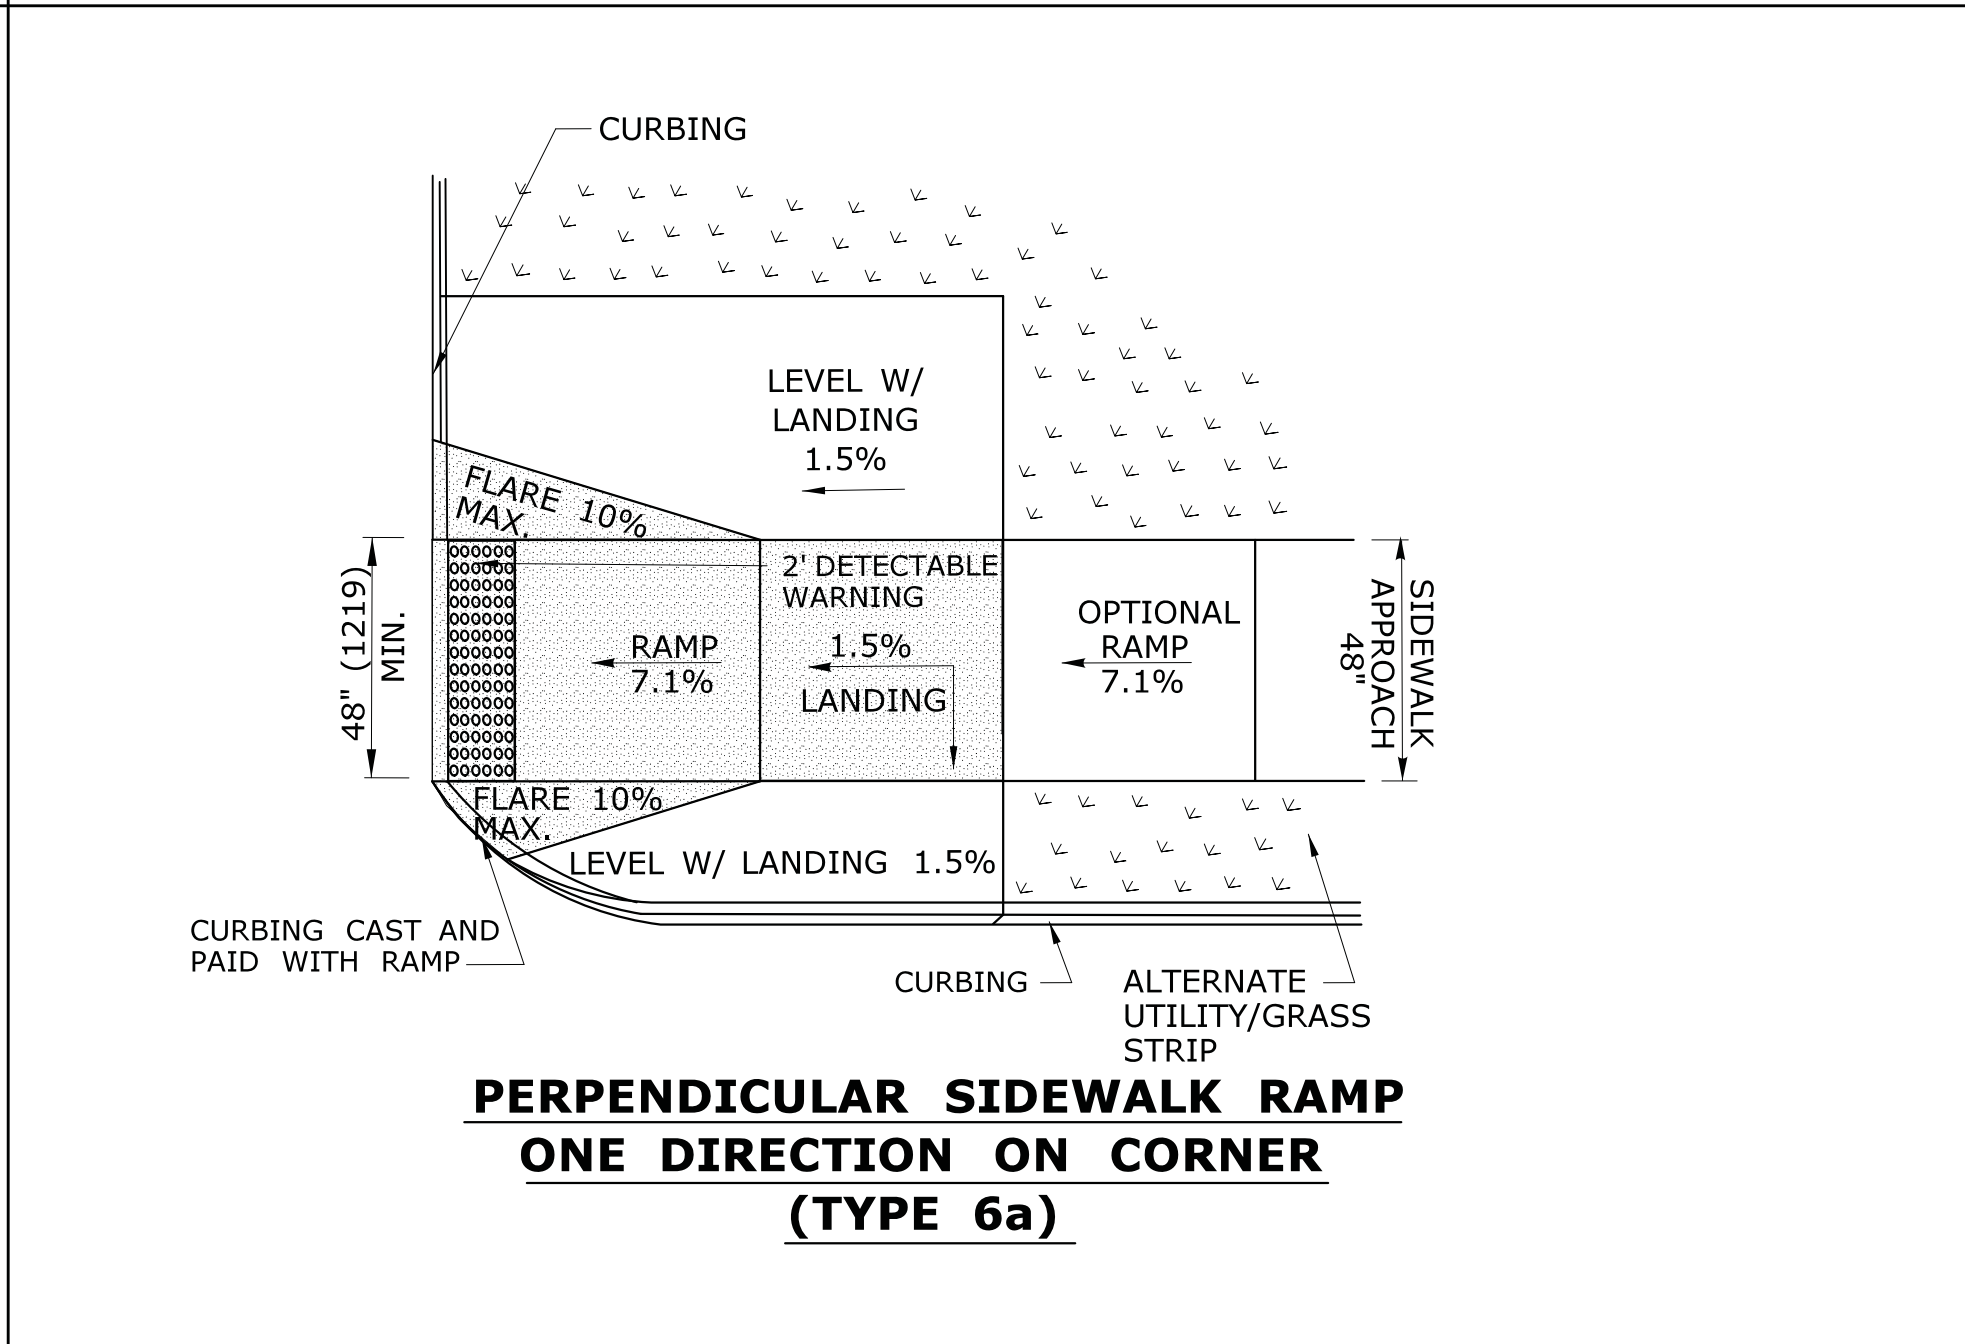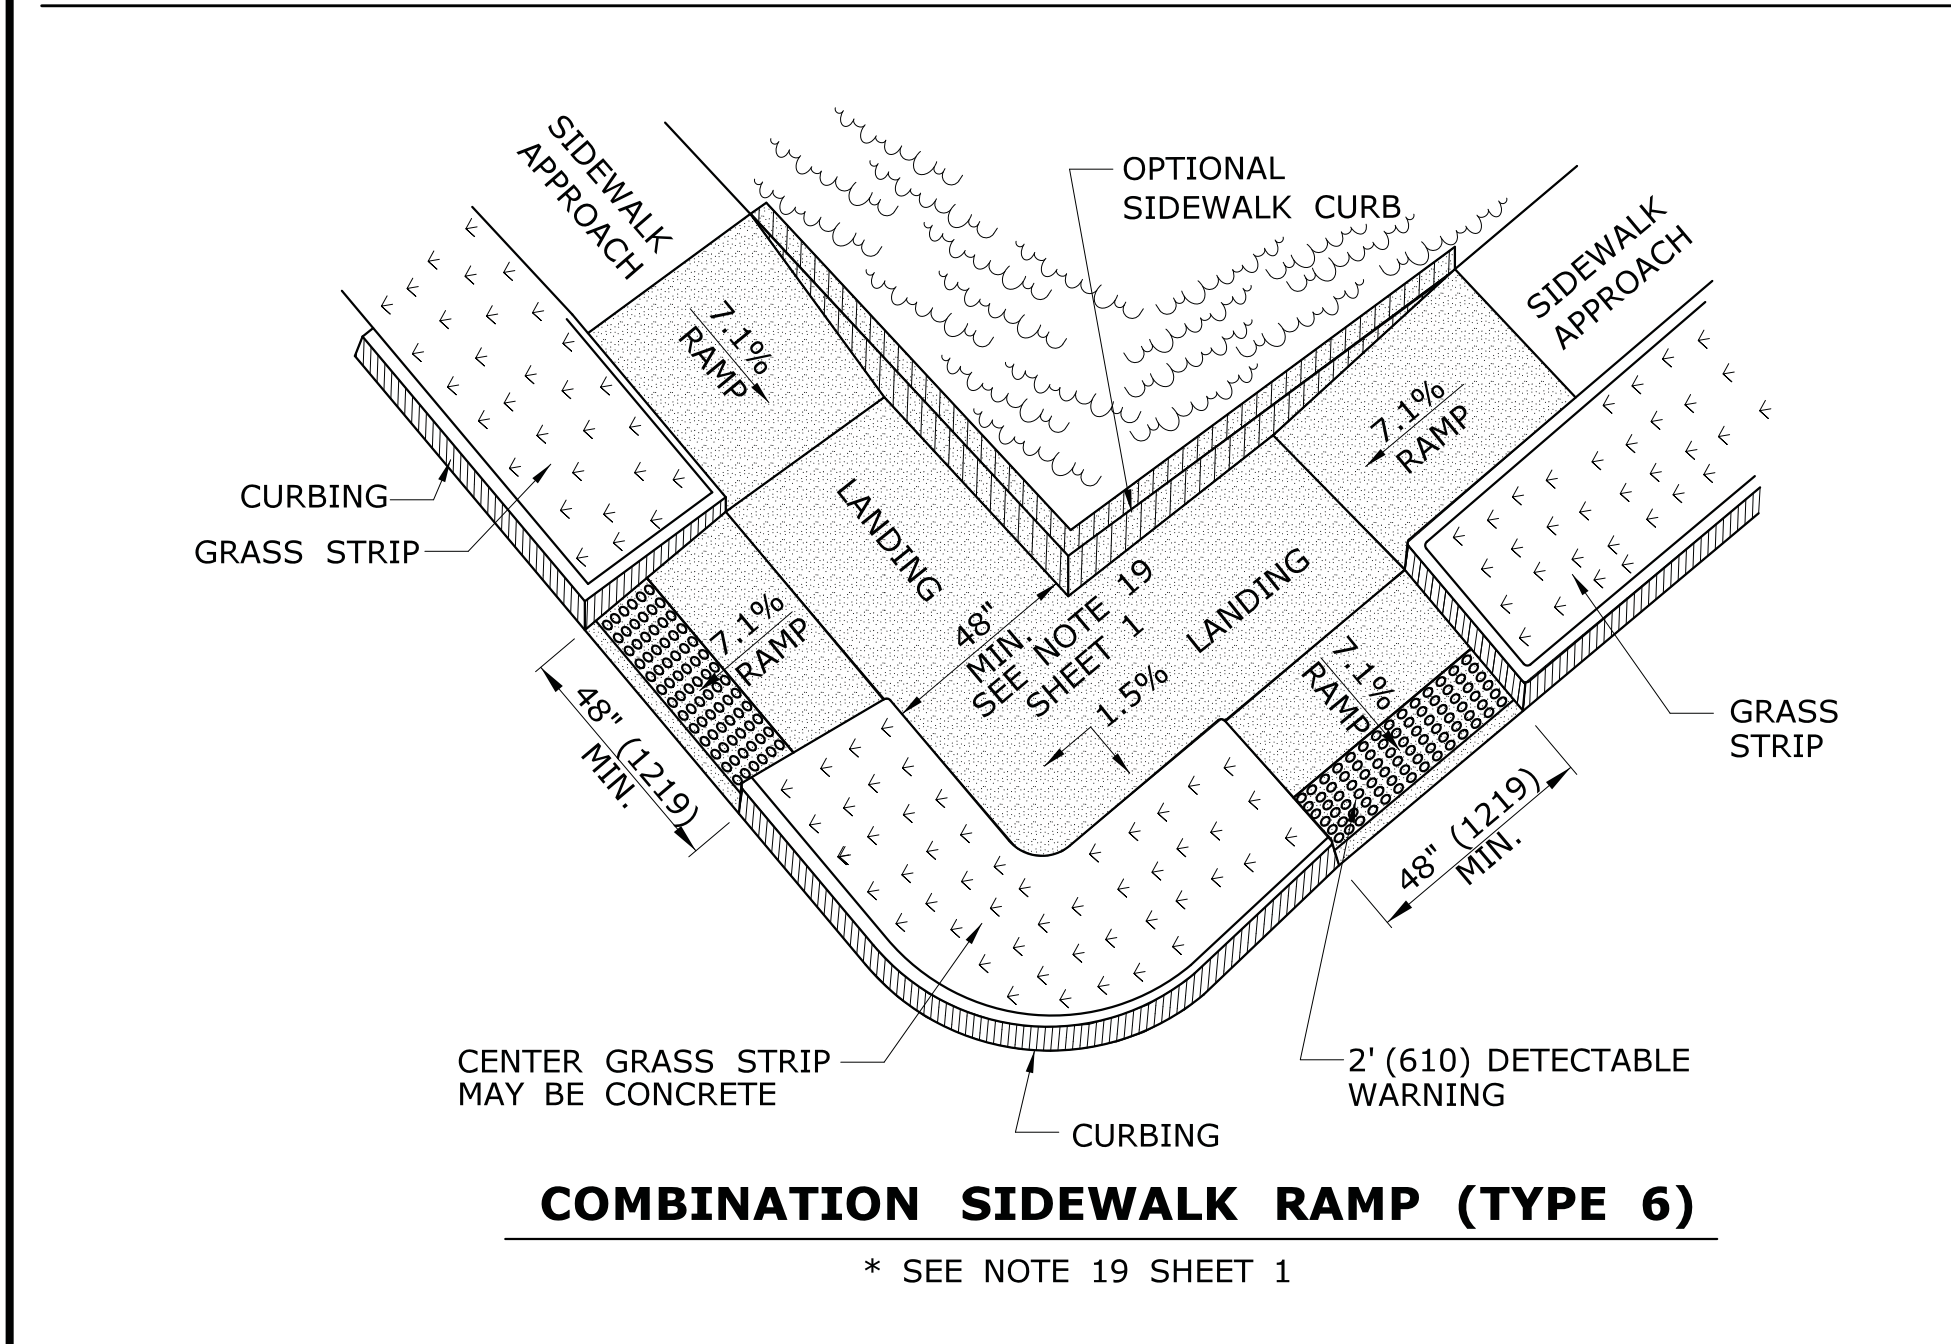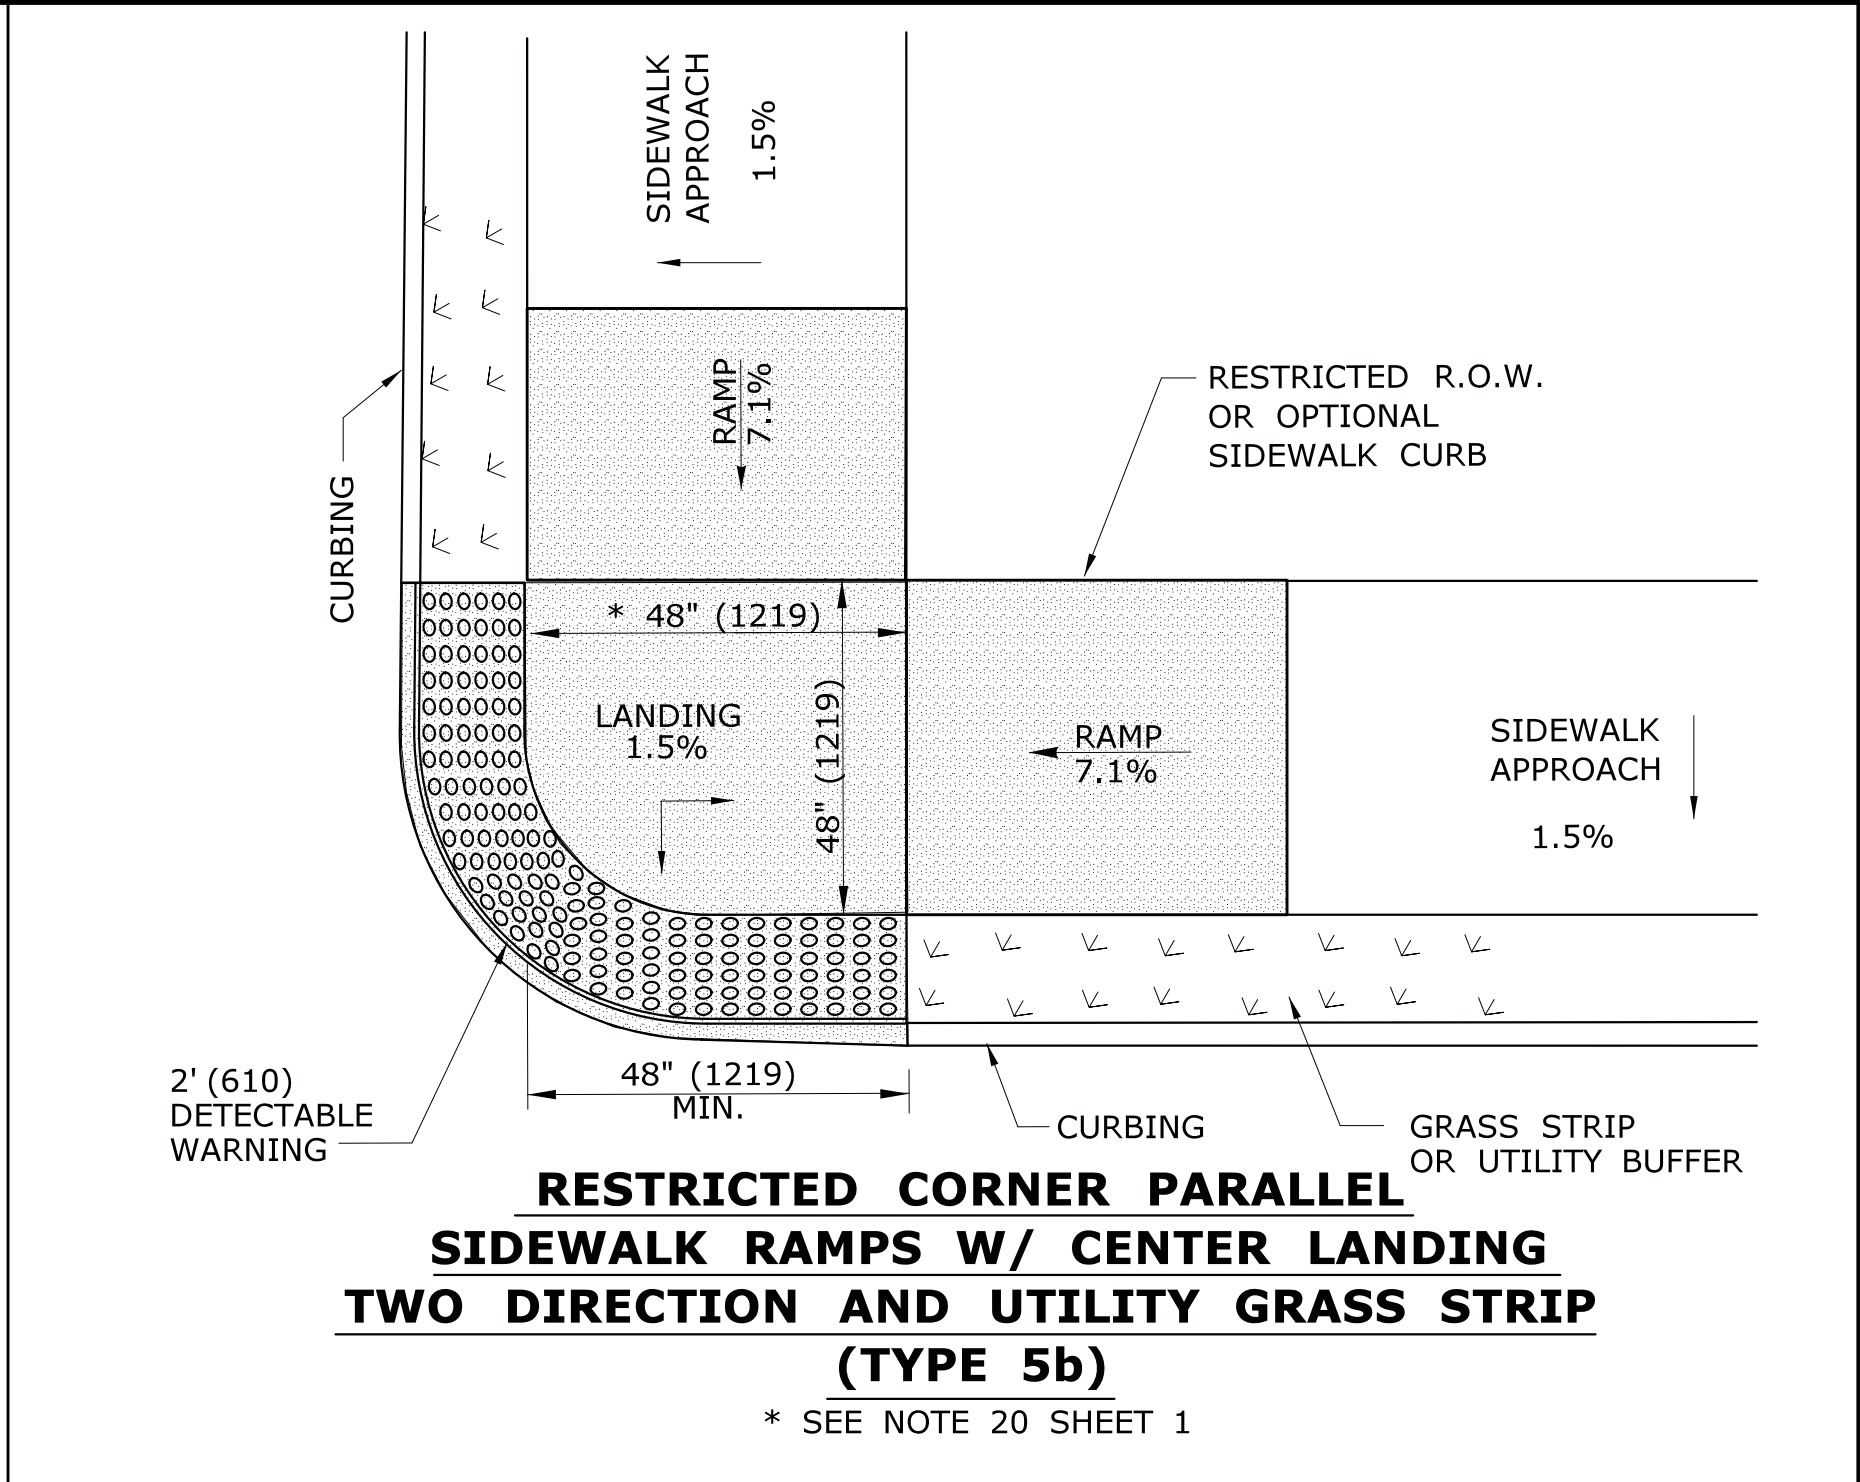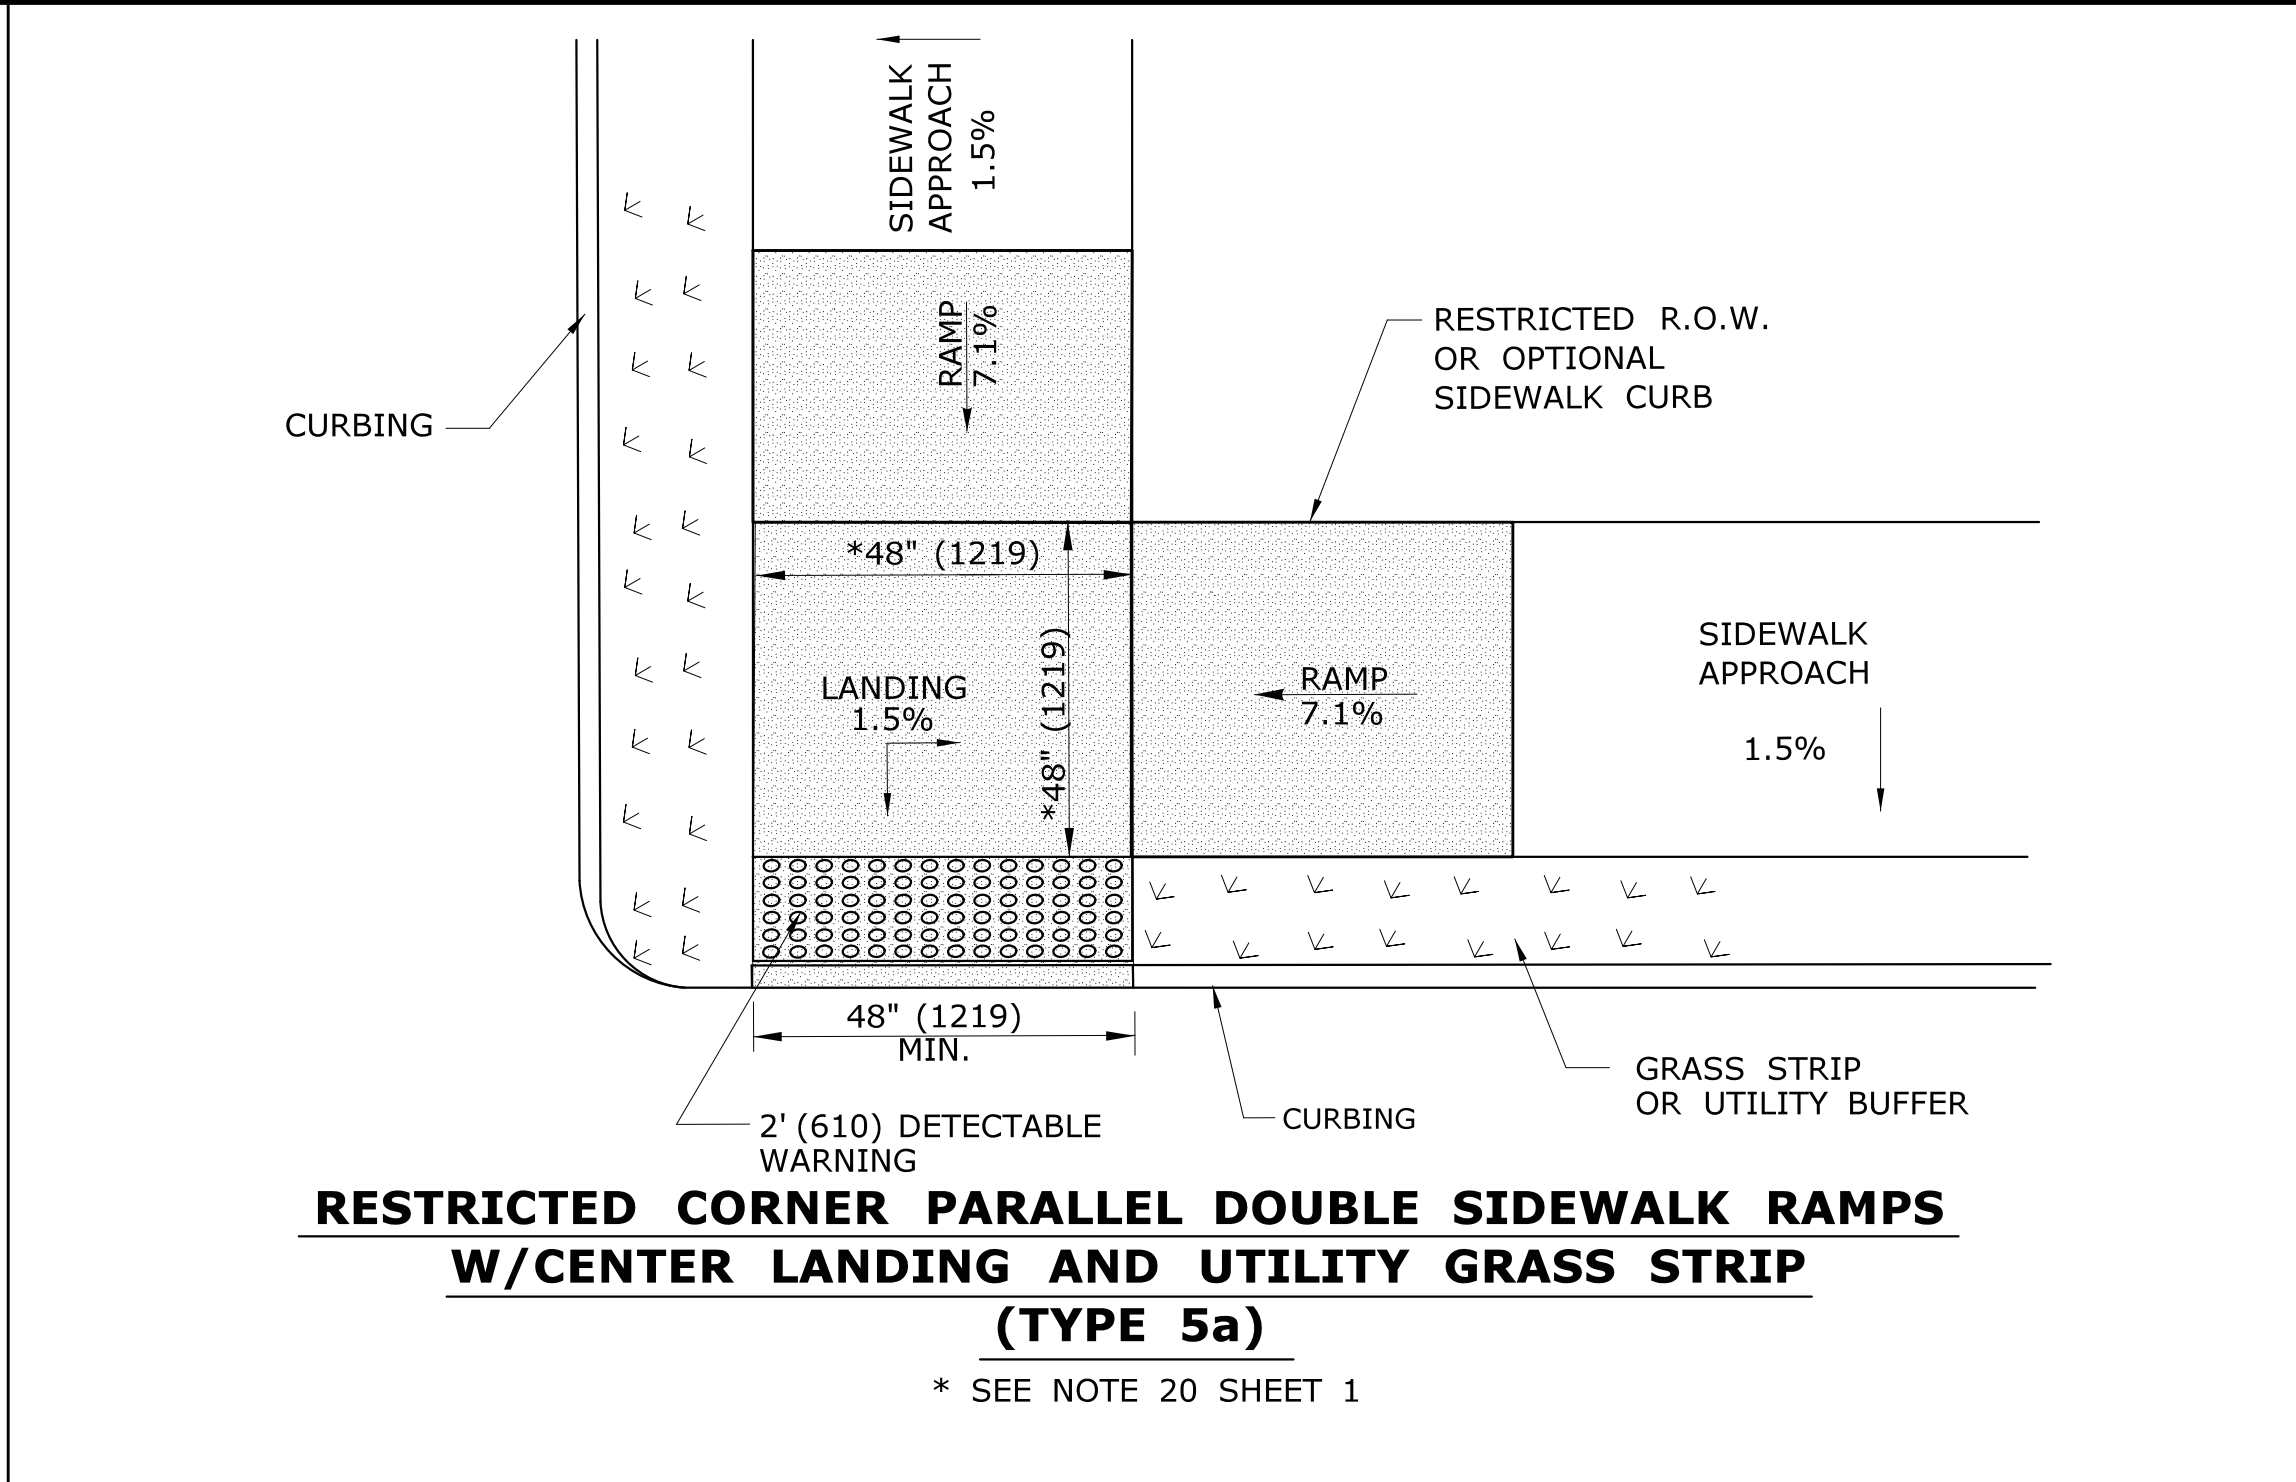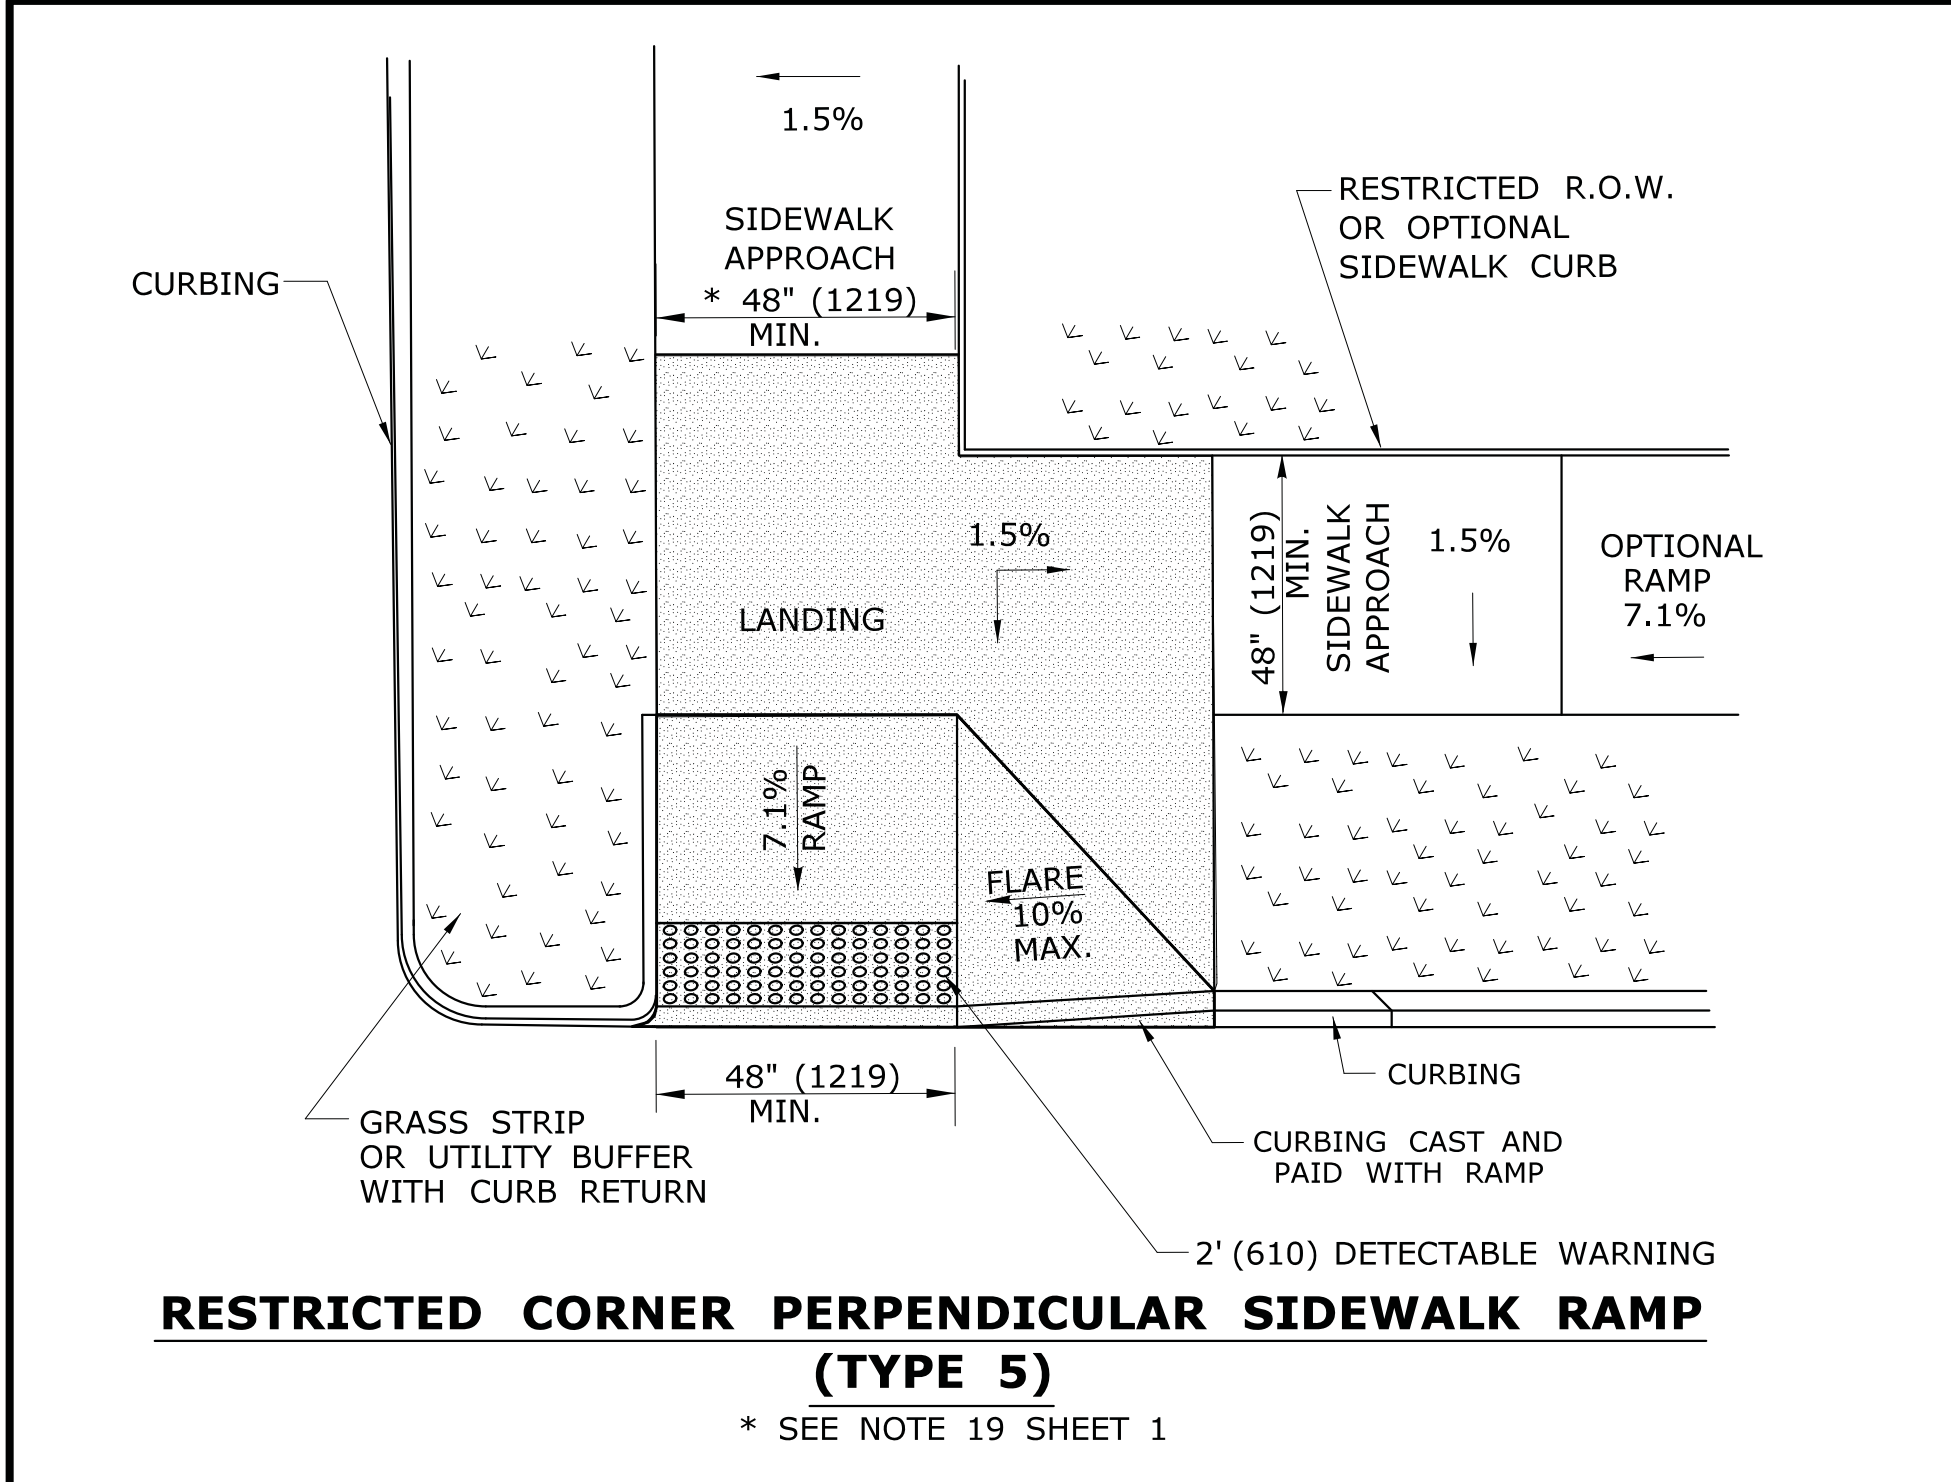				DESIGNER/DRAFTER: MGB/EMK		 STATE OF CONNECTICUT DEPARTMENT OF TRANSPORTATION	 OFFICE OF ENGINEERING	SIGNATURE/ BLOCK:	PROJECT TITLE:	TOWN:	PROJECT NO.	
				CHECKED BY: LLF								APPROVED BY:
						Filename: ...SIDEWALK RAMP 2.GD.dgn						
REV.	DATE	REVISION DESCRIPTION		SHEET NO.	Plotted Date: 5/27/2014							




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			CHECKED BY: LLF									APPROVED BY:	DRAWING TITLE: SIDEWALK RAMP SHEET 3	DRAWING NO.
REV.	DATE	REVISION DESCRIPTION	SHEET NO.	Plotted Date: 5/27/2014			Filename: ...SIDEWALK_RAMP 3.GD.dgn							

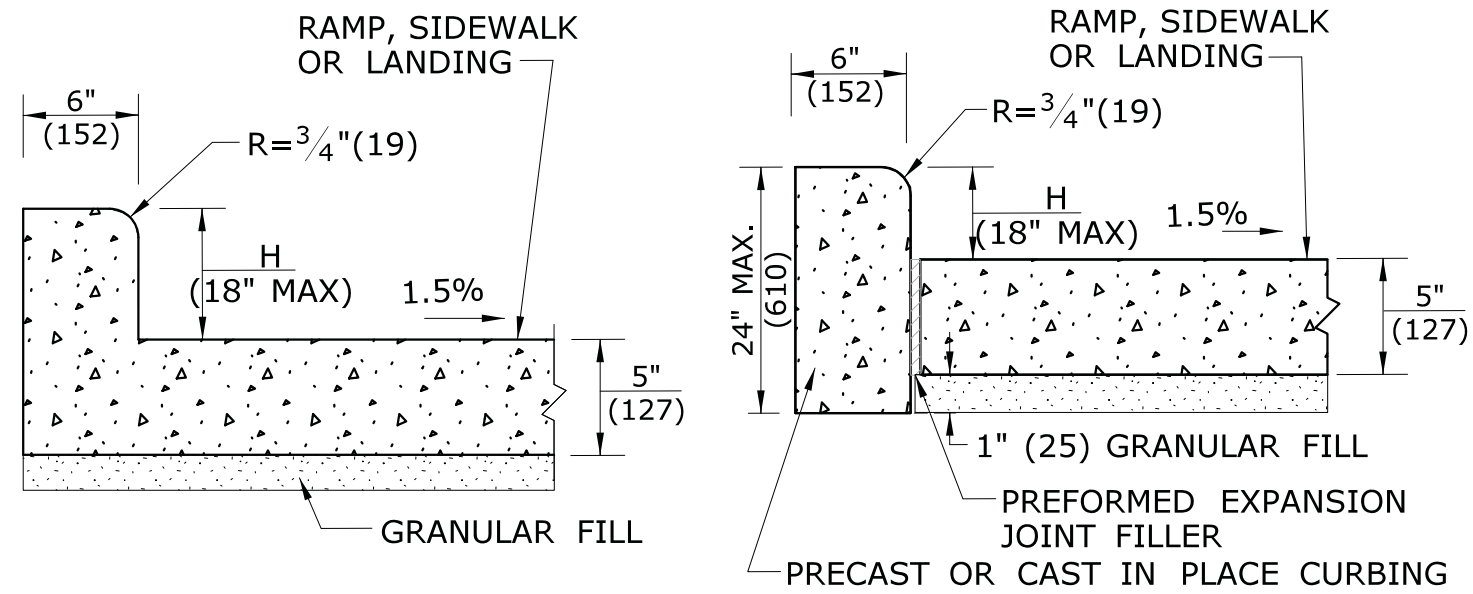


MONOLITHIC CAST CURB

SEPARATELY CAST CURB

SIDEWALK CURB OPTIONS AT BACK OF SIDEWALK

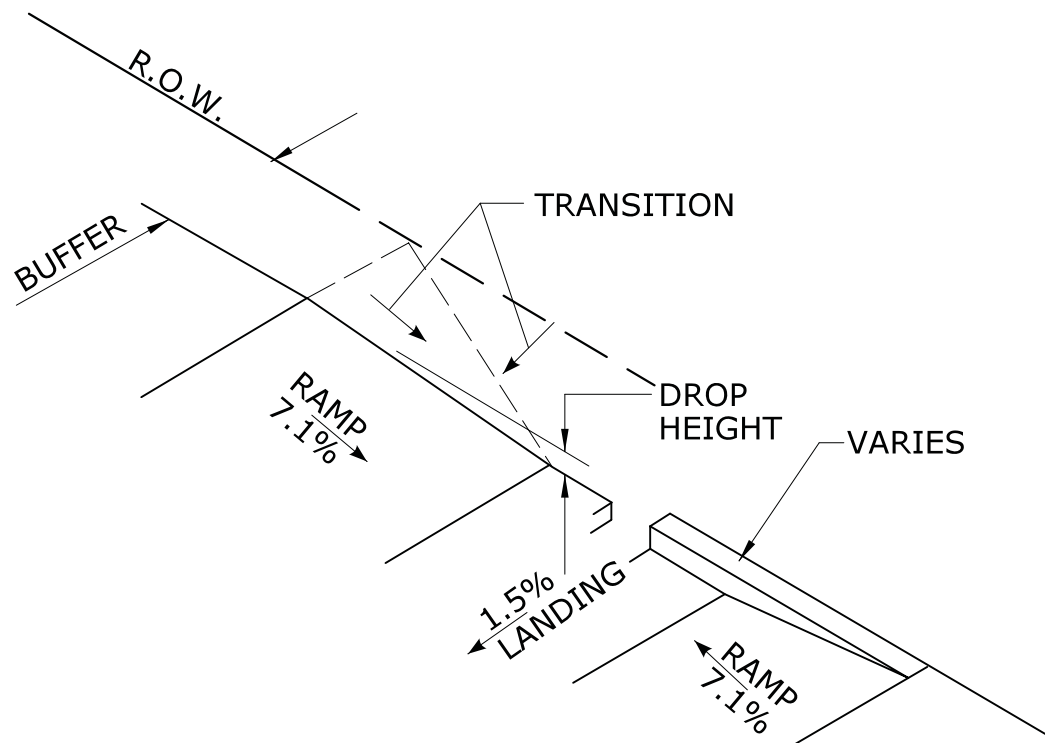


BACK OF SIDEWALK CURB OR BUFFER TRANSITION

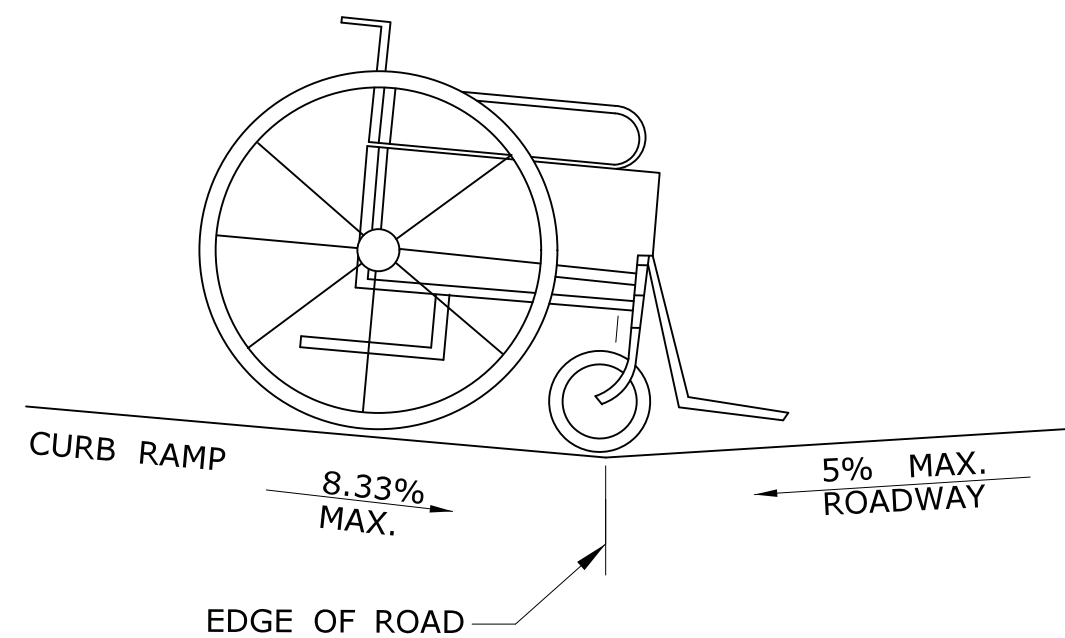

DETAIL 1
SEE GRADE CHANGE AT ROADWAY INTERFACE
SEE NOTE 1 SHEET HW-921 02a


GENERAL NOTES:

1. RAMPED MEDIANS SHALL HAVE A CURB RAMP AT EITHER END AND LEVEL LANDING A MINIMUM OF 5' x 5' (1.5m x 1.5m) IN BETWEEN. CUT-THROUGH MEDIANS SHALL BE A MINIMUM OF 6' (1.8m) LONG AND 5' (1.5m) WIDE. FOR ALL MEDIANS, CUT-THROUGH OR RAMPED, A 2' (610) STRIP OF DETECTABLE WARNINGS SHALL BE INSTALLED AT THE ENTRANCE AND EXIT.
2. SEE GENERAL NOTES ON SHEET 1.

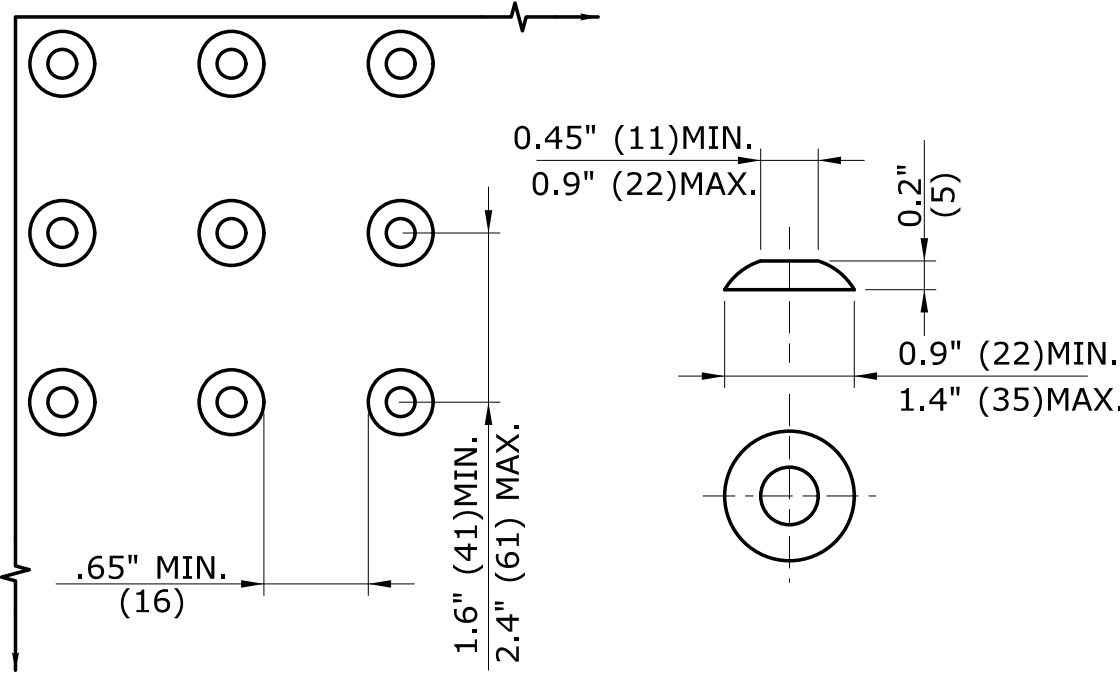


DOME SPACING DOME SECTION


STANDARD DOME ON DETECTABLE WARNING TILES

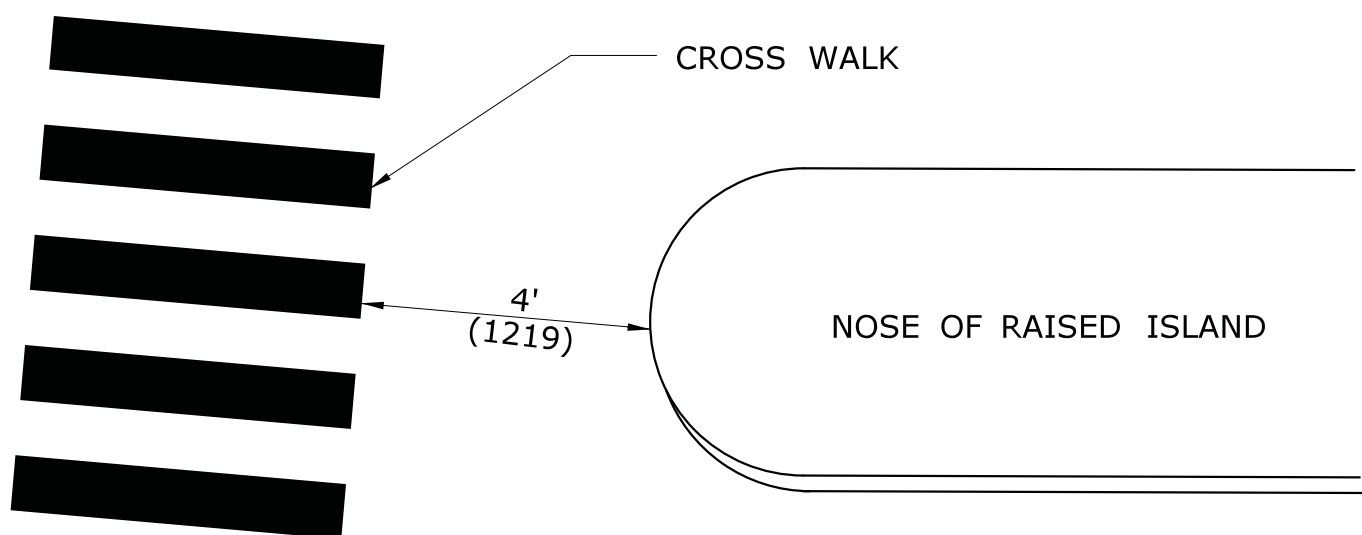

ALTERNATE CROSSWALK WITH MEDIAN ISLAND PULLED BACK

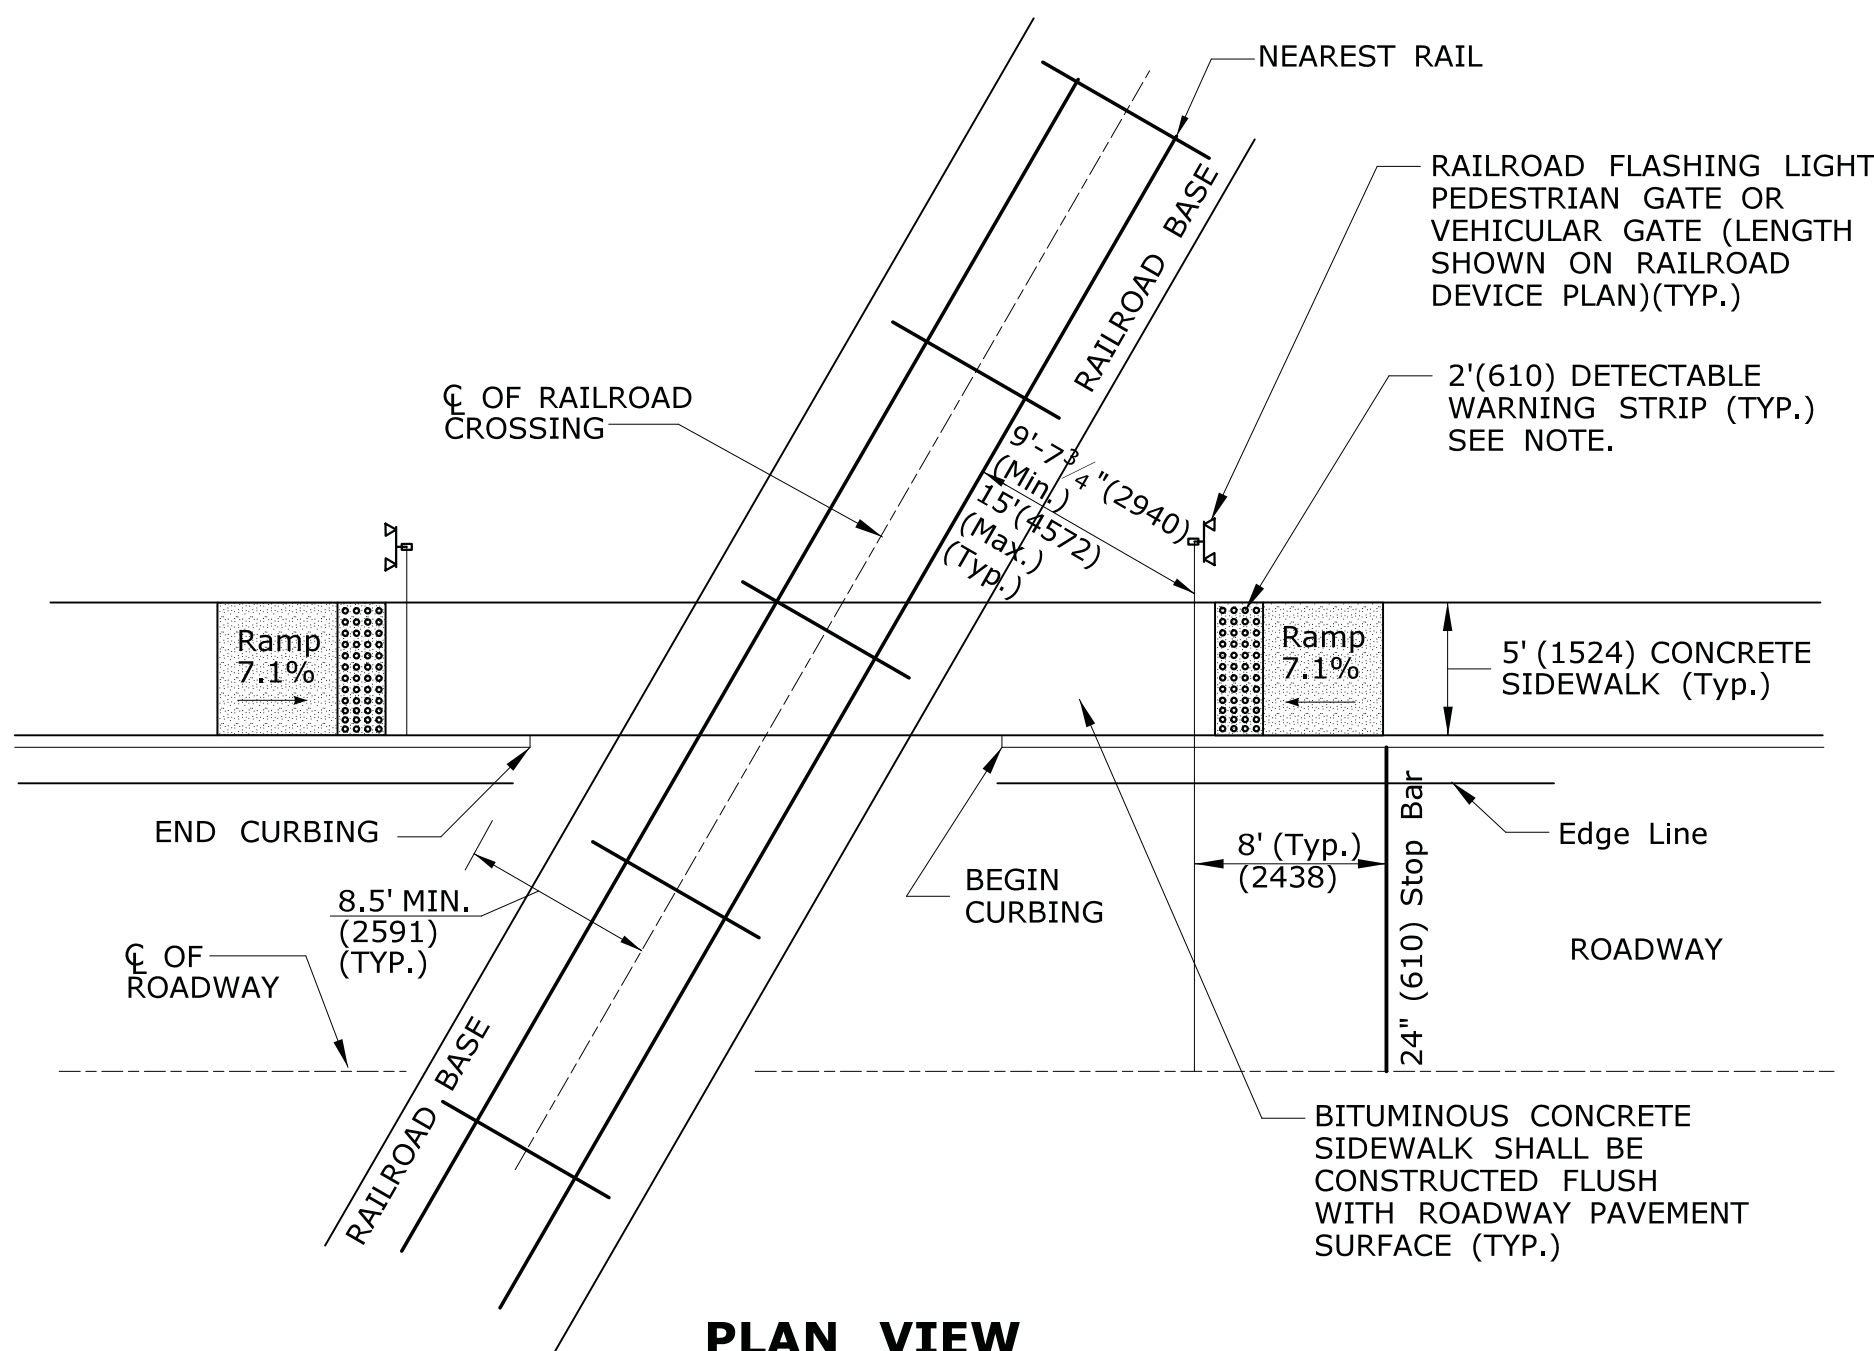


PLAN VIEW

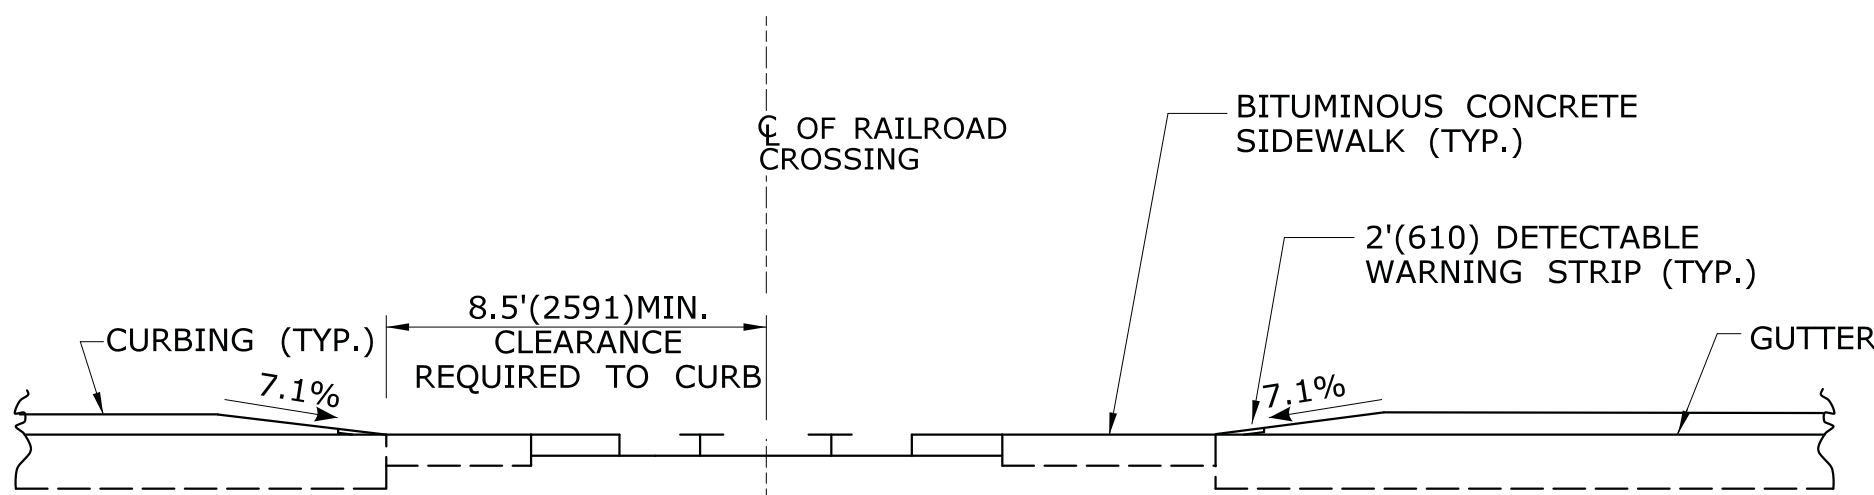


ELEVATION VIEW

DETECTABLE WARNINGS AT RAILROAD CROSSING


NOTE: WHEN NO GATE IS PRESENT, INSTALL DETECTABLE WARNING SURFACE 12' (3.6m) FROM THE NEAREST RAIL. IF GATE IS PRESENT, INSTALL DETECTABLE WARNING 2' (610) PRIOR TO GATE. THE ROWS OF TRUNCATED DOMES IN A DETECTABLE WARNING SURFACE SHALL BE INSTALLED PARALLEL WITH THE DIRECTION OF PEDESTRIAN TRAVEL.

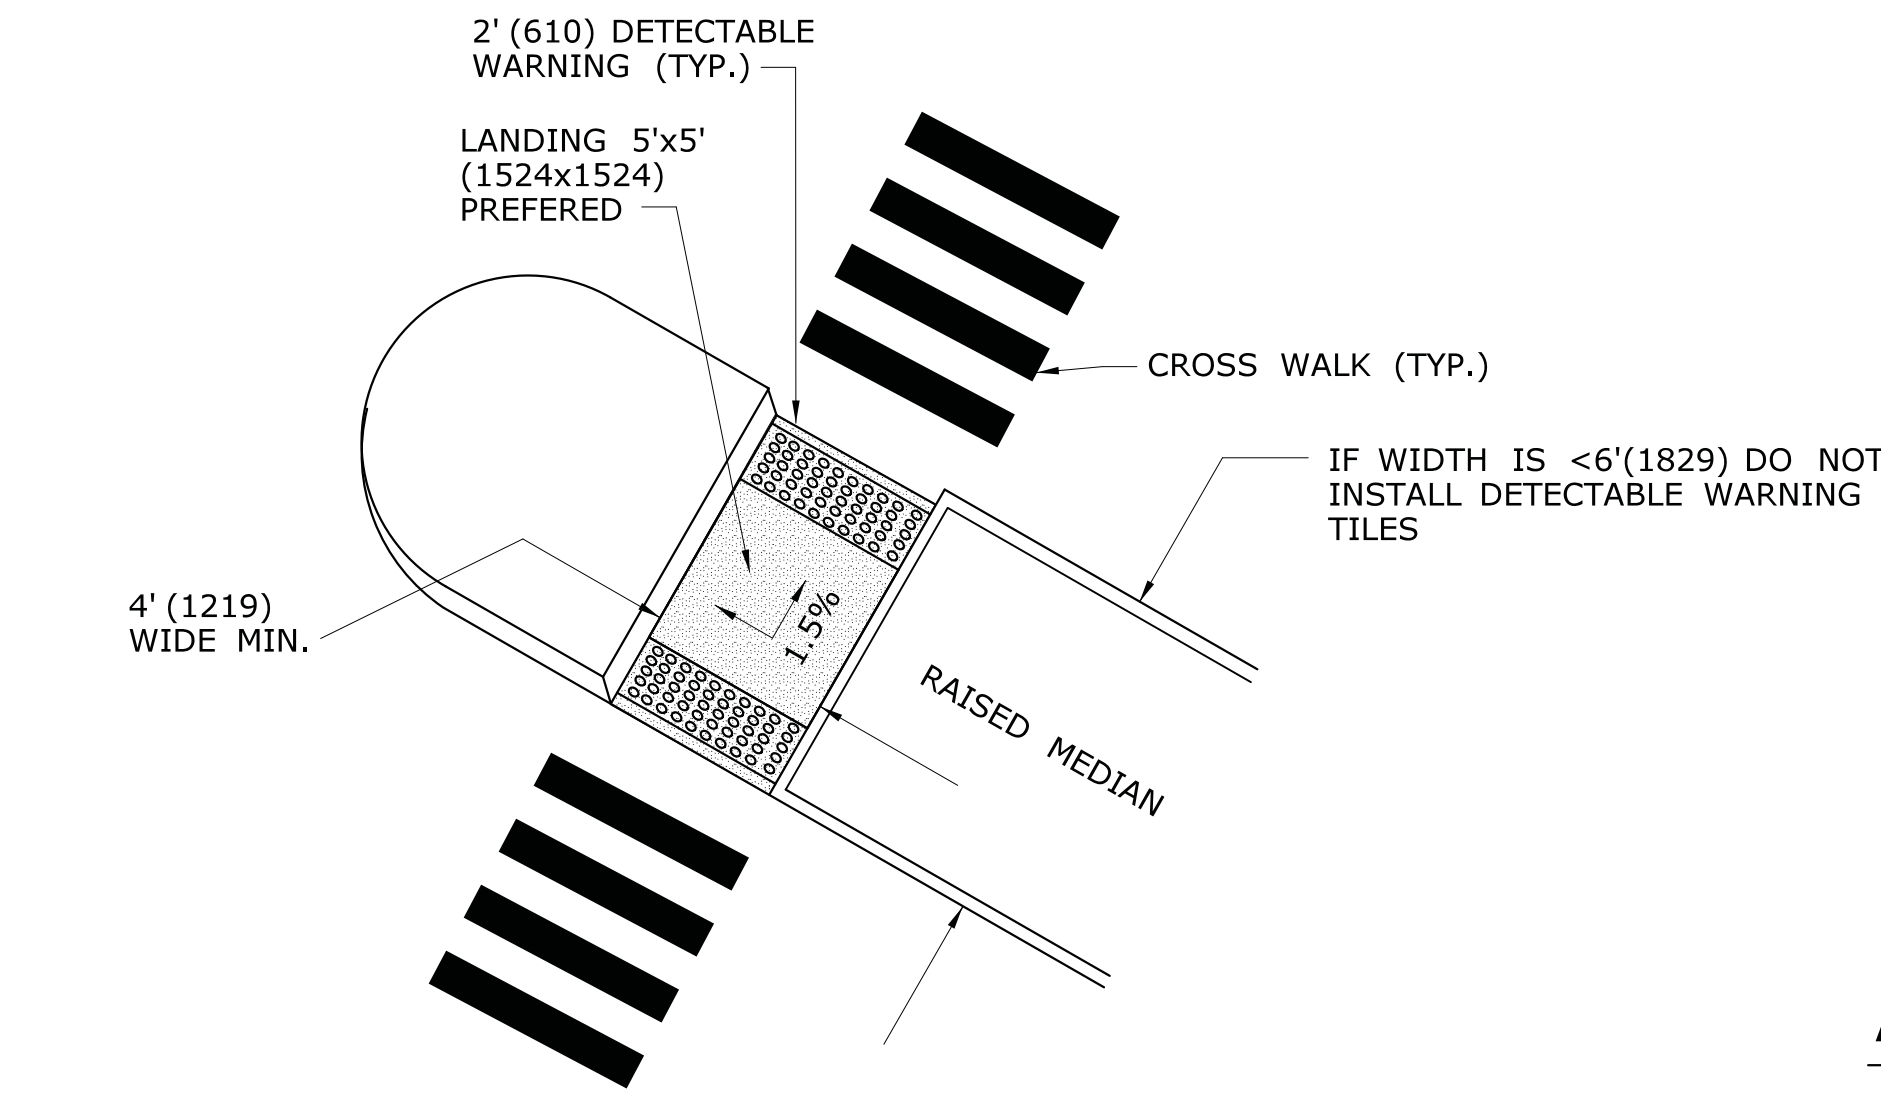


CUT-THROUGH MEDIAN ISLAND

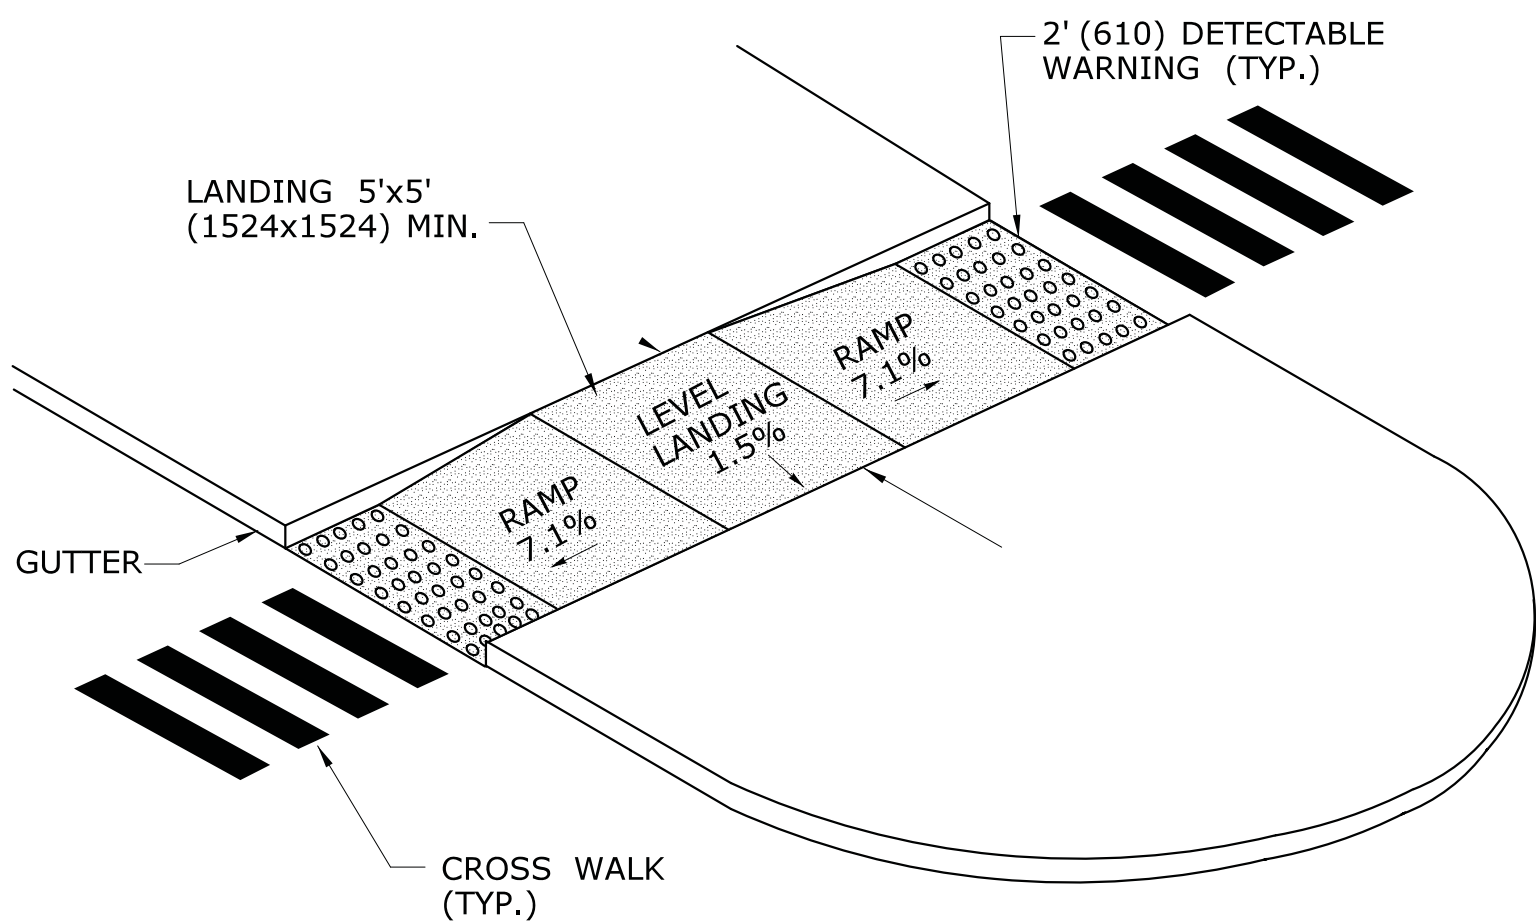

RAISED MEDIAN ISLAND WITH LANDING AND RAMPS

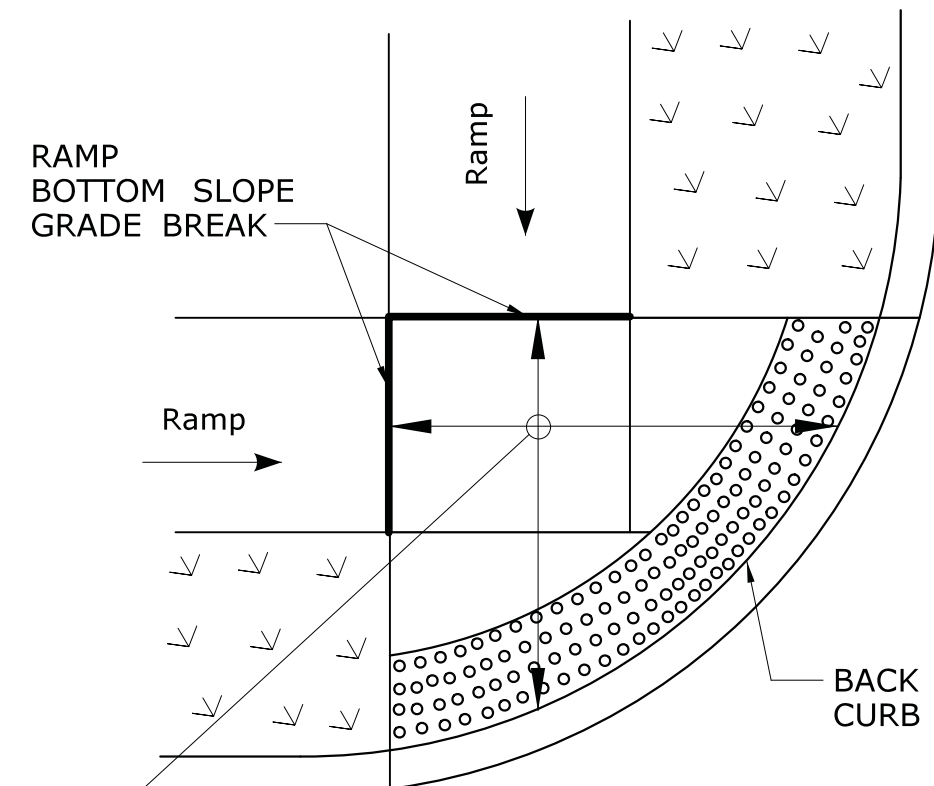

DETECTABLE WARNING PLACEMENT DETAIL 1

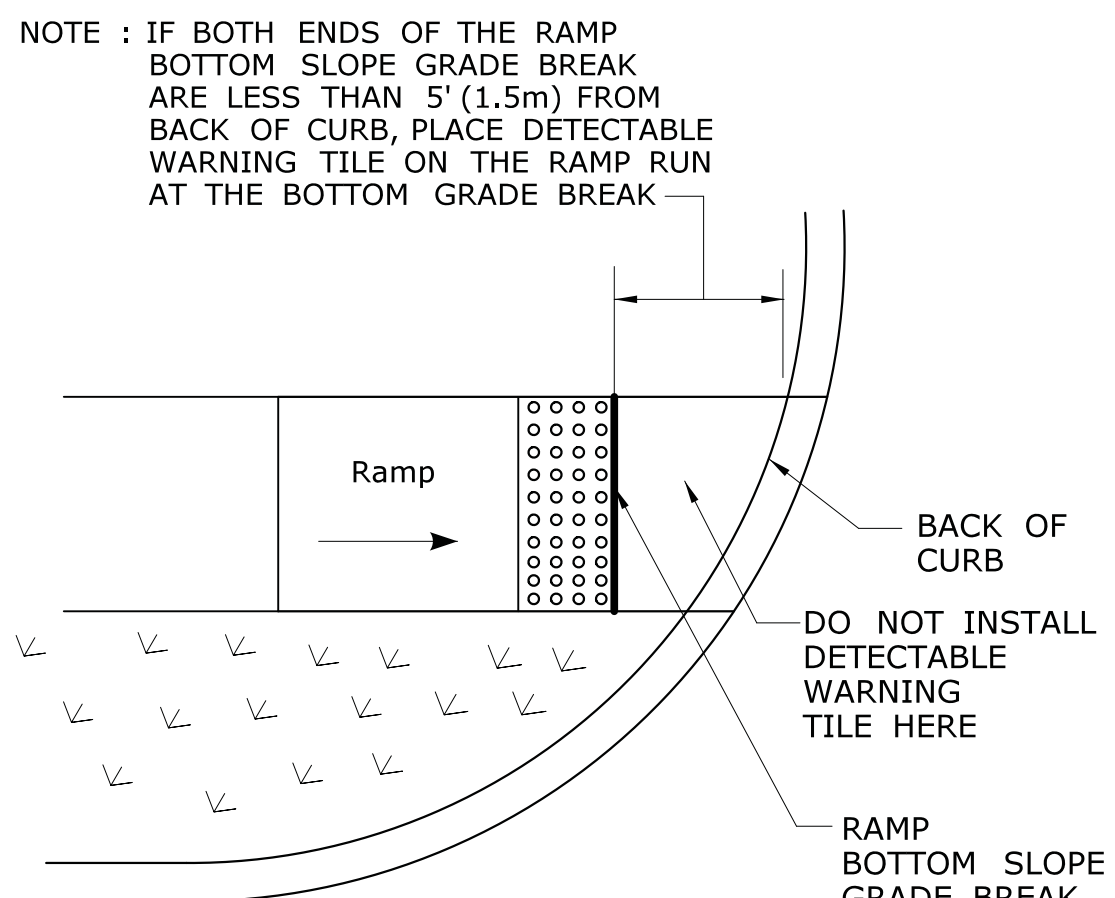


DETECTABLE WARNING PLACEMENT DETAIL 2

ALL METRIC DIMENSIONS ARE IN MILLIMETERS (mm) UNLESS OTHERWISE NOTED

REV.	DATE	REVISION DESCRIPTION	SHEET NO.

DESIGNER/DRAFTER: MGB/EMK
CHECKED BY: LLF

 STATE OF CONNECTICUT DEPARTMENT OF TRANSPORTATION
Filename: ...SIDEWALK RAMP 4.GD.dgn

SIGNATURE/ BLOCK: OFFICE OF ENGINEERING
APPROVED BY:

PROJECT TITLE:

TOWN:
DRAWING TITLE: SIDEWALK RAMP SHEET 4

PROJECT NO.
DRAWING NO.
SHEET NO.

R1 - SERIES					R2 - SERIES					R3 - SERIES															R4 - SERIES					R5 - SERIES																																																																																																																																																																																																																																																																																																																
<div>R1-1</div> <div>*</div> <div></div> <div>LEGEND - WHITE BACKGROUND - RED</div> <table><tr><th>AREA (SQ. FT)</th><th>SIZE (INCHES)</th><th>CONN. D.O.T. #</th><th>POSTS</th><th>ALUM. THK.</th></tr><tr><td>3.31</td><td>24</td><td>31-0536</td><td>1</td><td>.080</td></tr><tr><td>5.19</td><td>30</td><td>31-0552</td><td>1</td><td>.080</td></tr><tr><td>7.98</td><td>36</td><td>31-0553</td><td>1</td><td>.080</td></tr><tr><td>13.3</td><td>48</td><td>31-0557</td><td>2</td><td>.100</td></tr></table>					AREA (SQ. FT)	SIZE (INCHES)	CONN. D.O.T. #	POSTS	ALUM. THK.	3.31	24	31-0536	1	.080	5.19	30	31-0552	1	.080	7.98	36	31-0553	1	.080	13.3	48	31-0557	2	.100	<div>R2-1</div> <div></div> <div>SPEED LIMIT 00</div> <table><tr><th>AREA (SQ. FT)</th><th>SIZE (INCHES)</th><th>CONN. D.O.T. #</th><th>POSTS</th><th>ALUM. THK.</th></tr><tr><td>5.00</td><td>24X30</td><td>31-5505</td><td>1</td><td>.080</td></tr><tr><td>7.50</td><td>30X36</td><td>31-5504</td><td>1</td><td>.080</td></tr><tr><td>12.00</td><td>36X48</td><td>31-5506</td><td>2</td><td>.100</td></tr><tr><td>20.00</td><td>48X60</td><td>31-5507</td><td>2</td><td>.100</td></tr></table>					AREA (SQ. FT)	SIZE (INCHES)	CONN. D.O.T. #	POSTS	ALUM. THK.	5.00	24X30	31-5505	1	.080	7.50	30X36	31-5504	1	.080	12.00	36X48	31-5506	2	.100	20.00	48X60	31-5507	2	.100	<div>R3-1</div> <div></div> <div>NO RIGHT TURN</div> <div>31-1604 OVERHEAD MTD</div> <div>LEGEND - BLACK BACKGROUND - WHITE CIRCLE & DIAGONAL - RED</div> <table><tr><th>AREA (SQ. FT)</th><th>SIZE (INCHES)</th><th>CONN. D.O.T. #</th><th>POSTS</th><th>ALUM. THK.</th></tr><tr><td>4.00</td><td>24X24</td><td>31-1604</td><td></td><td>.080</td></tr><tr><td>6.25</td><td>30X30</td><td>31-1617</td><td>1</td><td>.080</td></tr><tr><td>5.00</td><td>30X24</td><td>31-1618</td><td></td><td>.080</td></tr><tr><td>9.00</td><td>36X36</td><td>31-1627</td><td>2</td><td>.080</td></tr><tr><td>7.50</td><td>36X30</td><td>31-1628</td><td></td><td>.080</td></tr></table>					AREA (SQ. FT)	SIZE (INCHES)	CONN. D.O.T. #	POSTS	ALUM. THK.	4.00	24X24	31-1604		.080	6.25	30X30	31-1617	1	.080	5.00	30X24	31-1618		.080	9.00	36X36	31-1627	2	.080	7.50	36X30	31-1628		.080	<div>R3-5</div> <div></div> <div>ONLY (L)</div> <div></div> <div>ONLY (R)</div> <table><tr><th>AREA (SQ. FT)</th><th>SIZE (INCHES)</th><th>CONN. D.O.T. #</th><th>POSTS</th><th>ALUM. THK.</th></tr><tr><td>4.00</td><td>24X24</td><td>31-0135L</td><td>1</td><td>.080</td></tr><tr><td>4.00</td><td>24X24</td><td>31-0138R</td><td>1</td><td>.080</td></tr><tr><td>6.25</td><td>30X30</td><td>31-0165</td><td>1</td><td>.080</td></tr><tr><td>7.50</td><td>30X36</td><td>31-0183L</td><td>1</td><td>.080</td></tr><tr><td>7.50</td><td>30X36</td><td>31-0184R</td><td>1</td><td>.080</td></tr></table>					AREA (SQ. FT)	SIZE (INCHES)	CONN. D.O.T. #	POSTS	ALUM. THK.	4.00	24X24	31-0135L	1	.080	4.00	24X24	31-0138R	1	.080	6.25	30X30	31-0165	1	.080	7.50	30X36	31-0183L	1	.080	7.50	30X36	31-0184R	1	.080	<div>R3-8b</div> <div></div> <div>LEFT LANE MUST TURN LEFT</div> <div></div> <div>RIGHT LANE MUST TURN RIGHT</div> <table><tr><th>AREA (SQ. FT)</th><th>SIZE (INCHES)</th><th>CONN. D.O.T. #</th><th>POSTS</th><th>ALUM. THK.</th></tr><tr><td>10.00</td><td>48X30</td><td>31-0302</td><td>2</td><td>.100</td></tr><tr><td>20.00</td><td>48X60</td><td>31-0121L</td><td>2</td><td>.100</td></tr><tr><td>20.00</td><td>48X60</td><td>31-0122R</td><td>2</td><td>.100</td></tr></table>					AREA (SQ. FT)	SIZE (INCHES)	CONN. D.O.T. #	POSTS	ALUM. THK.	10.00	48X30	31-0302	2	.100	20.00	48X60	31-0121L	2	.100	20.00	48X60	31-0122R	2	.100	<div>R4-1</div> <div></div> <div>DO NOT PASS</div> <table><tr><th>AREA (SQ. FT)</th><th>SIZE (INCHES)</th><th>CONN. D.O.T. #</th><th>POSTS</th><th>ALUM. THK.</th></tr><tr><td>5.00</td><td>24X30</td><td>31-1502</td><td>1</td><td>.080</td></tr><tr><td>20.00</td><td>48X60</td><td>31-1574</td><td>2</td><td>.100</td></tr></table>					AREA (SQ. FT)	SIZE (INCHES)	CONN. D.O.T. #	POSTS	ALUM. THK.	5.00	24X30	31-1502	1	.080	20.00	48X60	31-1574	2	.100	<div>R5-1</div> <div>*</div> <div></div> <div>DO NOT ENTER</div> <div>PROHIBITED PEDESTRIANS MOTOR BIKES MOTOR SCOOTERS BICYCLES</div> <table><tr><th>AREA (SQ. FT)</th><th>SIZE (INCHES)</th><th>CONN. D.O.T. #</th><th>POSTS</th><th>ALUM. THK.</th></tr><tr><td>6.25</td><td>30X30</td><td>31-1119</td><td>1</td><td>.080</td></tr><tr><td>9.00</td><td>36X36</td><td>31-1120</td><td>1</td><td>.080</td></tr><tr><td>16.00</td><td>48X48</td><td>31-1121</td><td>2</td><td>.100</td></tr></table>					AREA (SQ. FT)	SIZE (INCHES)	CONN. D.O.T. #	POSTS	ALUM. THK.	6.25	30X30	31-1119	1	.080	9.00	36X36	31-1120	1	.080	16.00	48X48	31-1121	2	.100	<div>R5-1</div> <div>*</div> <div></div> <div>WRONG WAY</div> <div>EMERGENCY AND AUTHORIZED VEHICLES ONLY</div> <table><tr><th>AREA (SQ. FT)</th><th>SIZE (INCHES)</th><th>CONN. D.O.T. #</th><th>POSTS</th><th>ALUM. THK.</th></tr><tr><td>6.00</td><td>36X24</td><td>31-1122</td><td>2</td><td>.080</td></tr><tr><td>8.75</td><td>42X30</td><td>31-1123</td><td>2</td><td>.100</td></tr></table>					AREA (SQ. FT)	SIZE (INCHES)	CONN. D.O.T. #	POSTS	ALUM. THK.	6.00	36X24	31-1122	2	.080	8.75	42X30	31-1123	2	.100	<div>R5-3</div> <div>**</div> <div></div> <div>NO MOTOR VEHICLES</div> <div>LEGEND - BLACK BACKGROUND - WHITE</div> <table><tr><th>AREA (SQ. FT)</th><th>SIZE (INCHES)</th><th>CONN. D.O.T. #</th><th>POSTS</th><th>ALUM. THK.</th></tr><tr><td>27.00</td><td>54X72</td><td>31-1719</td><td>2</td><td>.125</td></tr><tr><td>4.00</td><td>24X24</td><td>31-1727</td><td>1</td><td>.080</td></tr></table>					AREA (SQ. FT)	SIZE (INCHES)	CONN. D.O.T. #	POSTS	ALUM. THK.	27.00	54X72	31-1719	2	.125	4.00	24X24	31-1727	1	.080																																																																																															
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<div>R1-2</div> <div>*</div> <div></div> <div>LEGEND - RED BACKGROUND - WHITE</div> <table><tr><th>AREA (SQ. FT)</th><th>SIZE (INCHES)</th><th>CONN. D.O.T. #</th><th>POSTS</th><th>ALUM. THK.</th></tr><tr><td>3.90</td><td>36</td><td>31-0523</td><td>1</td><td>.080</td></tr><tr><td>6.77</td><td>48</td><td>31-0522</td><td>2B</td><td>.100</td></tr><tr><td>10.83</td><td>60</td><td>31-0528</td><td>2B</td><td>.100</td></tr></table>					AREA (SQ. FT)	SIZE (INCHES)	CONN. D.O.T. #	POSTS	ALUM. THK.	3.90	36	31-0523	1	.080	6.77	48	31-0522	2B	.100	10.83	60	31-0528	2B	.100	<div>R2-4a</div> <div></div> <div>SPEED LIMIT 00 MINIMUM 00</div> <table><tr><th>AREA (SQ. FT)</th><th>SIZE (INCHES)</th><th>CONN. D.O.T. #</th><th>POSTS</th><th>ALUM. THK.</th></tr><tr><td>32.00</td><td>48X96</td><td>31-5510</td><td>2B</td><td>.125</td></tr></table>					AREA (SQ. FT)	SIZE (INCHES)	CONN. D.O.T. #	POSTS	ALUM. THK.	32.00	48X96	31-5510	2B	.125	<div>R3-2</div> <div></div> <div>NO LEFT TURN</div> <div>31-1603 OVERHEAD MTD</div> <div>LEGEND - BLACK BACKGROUND - WHITE CIRCLE & DIAGONAL - RED</div> <table><tr><th>AREA (SQ. FT)</th><th>SIZE (INCHES)</th><th>CONN. D.O.T. #</th><th>POSTS</th><th>ALUM. THK.</th></tr><tr><td>4.00</td><td>24X24</td><td>31-1603</td><td></td><td>.080</td></tr><tr><td>6.25</td><td>30X30</td><td>31-1619</td><td>1</td><td>.080</td></tr><tr><td>5.00</td><td>30X24</td><td>31-1620</td><td></td><td>.080</td></tr><tr><td>9.00</td><td>36X36</td><td>31-1629</td><td>2</td><td>.080</td></tr><tr><td>7.50</td><td>36X30</td><td>31-1630</td><td></td><td>.080</td></tr></table>					AREA (SQ. FT)	SIZE (INCHES)	CONN. D.O.T. #	POSTS	ALUM. THK.	4.00	24X24	31-1603		.080	6.25	30X30	31-1619	1	.080	5.00	30X24	31-1620		.080	9.00	36X36	31-1629	2	.080	7.50	36X30	31-1630		.080	<div>R3-6</div> <div></div> <div>ONLY (L)</div> <div></div> <div>ONLY (R)</div> <table><tr><th>AREA (SQ. FT)</th><th>SIZE (INCHES)</th><th>CONN. D.O.T. #</th><th>POSTS</th><th>ALUM. THK.</th></tr><tr><td>4.00</td><td>24X24</td><td>31-0157L</td><td>1</td><td>.080</td></tr><tr><td>7.50</td><td>30X36</td><td>31-0158R</td><td>1</td><td>.080</td></tr><tr><td>5.00</td><td>30X24</td><td>31-0290</td><td>1</td><td>.080</td></tr><tr><td>7.50</td><td>36X30</td><td></td><td></td><td></td></tr></table>					AREA (SQ. FT)	SIZE (INCHES)	CONN. D.O.T. #	POSTS	ALUM. THK.	4.00	24X24	31-0157L	1	.080	7.50	30X36	31-0158R	1	.080	5.00	30X24	31-0290	1	.080	7.50	36X30				<div>R3-0295</div> <div></div> <div>ONLY (L)</div> <div></div> <div>ONLY (R)</div> <table><tr><th>AREA (SQ. FT)</th><th>SIZE (INCHES)</th><th>CONN. D.O.T. #</th><th>POSTS</th><th>ALUM. THK.</th></tr><tr><td>7.50</td><td>36X30</td><td></td><td></td><td></td></tr></table>					AREA (SQ. FT)	SIZE (INCHES)	CONN. D.O.T. #	POSTS	ALUM. THK.	7.50	36X30				<div>R3-0219</div> <div></div> <div>ONLY (L)</div> <div></div> <div>ONLY (R)</div> <table><tr><th>AREA (SQ. FT)</th><th>SIZE (INCHES)</th><th>CONN. D.O.T. #</th><th>POSTS</th><th>ALUM. THK.</th></tr><tr><td>7.50</td><td>36X30</td><td></td><td></td><td></td></tr></table>					AREA (SQ. FT)	SIZE (INCHES)	CONN. D.O.T. #	POSTS	ALUM. THK.	7.50	36X30				<div>R3-0307</div> <div></div> <div>ONLY (L)</div> <div></div> <div>ONLY (R)</div> <table><tr><th>AREA (SQ. FT)</th><th>SIZE (INCHES)</th><th>CONN. D.O.T. #</th><th>POSTS</th><th>ALUM. THK.</th></tr><tr><td>10.00</td><td>48X30</td><td></td><td></td><td></td></tr></table>					AREA (SQ. FT)	SIZE (INCHES)	CONN. D.O.T. #	POSTS	ALUM. THK.	10.00	48X30				<div>R3-0372</div> <div></div> <div>ONLY (L)</div> <div></div> <div>ONLY (R)</div> <table><tr><th>AREA (SQ. FT)</th><th>SIZE (INCHES)</th><th>CONN. D.O.T. #</th><th>POSTS</th><th>ALUM. 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THK.	6.25	30X30				<div>R3-7L</div> <div></div> <div>LEFT LANE MUST TURN LEFT</div> <div>R3-7R</div> <div></div> <div>RIGHT LANE MUST TURN RIGHT</div> <table><tr><th>AREA (SQ. FT)</th><th>SIZE (INCHES)</th><th>CONN. D.O.T. #</th><th>POSTS</th><th>ALUM. THK.</th></tr><tr><td>6.25</td><td>30X30</td><td>31-0117L</td><td>1</td><td>.080</td></tr><tr><td>6.25</td><td>30X30</td><td>31-0118R</td><td>1</td><td>.080</td></tr><tr><td>9.00</td><td>36X36</td><td>31-0120L</td><td>1</td><td>.080</td></tr><tr><td>9.00</td><td>36X36</td><td>31-0123R</td><td>1</td><td>.080</td></tr></table>					AREA (SQ. FT)	SIZE (INCHES)	CONN. D.O.T. #	POSTS	ALUM. THK.	6.25	30X30	31-0117L	1	.080	6.25	30X30	31-0118R	1	.080	9.00	36X36	31-0120L	1	.080	9.00	36X36	31-0123R	1	.080	<div>R3-48</div> <div></div> <div>ONLY (L)</div> <div></div> <div>ONLY (R)</div> <table><tr><th>AREA (SQ. FT)</th><th>SIZE (INCHES)</th><th>CONN. D.O.T. #</th><th>POSTS</th><th>ALUM. THK.</th></tr><tr><td>6.25</td><td>30X30</td><td>31-0262L</td><td>1</td><td>.080</td></tr><tr><td>6.25</td><td>30X30</td><td>31-0261R</td><td>1</td><td>.080</td></tr></table>					AREA (SQ. FT)	SIZE (INCHES)	CONN. D.O.T. #	POSTS	ALUM. THK.	6.25	30X30	31-0262L	1	.080	6.25	30X30	31-0261R	1	.080	<div>R3-0370</div> <div></div> <div>ONLY (L)</div> <div></div> <div>ONLY (R)</div> <table><tr><th>AREA (SQ. FT)</th><th>SIZE (INCHES)</th><th>CONN. D.O.T. #</th><th>POSTS</th><th>ALUM. THK.</th></tr><tr><td>8.75</td><td>42X30</td><td></td><td></td><td></td></tr></table>					AREA (SQ. FT)	SIZE (INCHES)	CONN. D.O.T. #	POSTS	ALUM. THK.	8.75	42X30				<div>R3-0371</div> <div></div> <div>ONLY (L)</div> <div></div> <div>ONLY (R)</div> <table><tr><th>AREA (SQ. FT)</th><th>SIZE (INCHES)</th><th>CONN. D.O.T. #</th><th>POSTS</th><th>ALUM. THK.</th></tr><tr><td>8.75</td><td>42X30</td><td></td><td></td><td></td></tr></table>					AREA (SQ. FT)	SIZE (INCHES)	CONN. D.O.T. #	POSTS	ALUM. 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6.25	30X30	31-0262L	1	.080																																																																																																																																																																																																																																																																																																																																										
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20.00	48X60	31-1564	2	.100																																																																																																																																																																																																																																																																																																																																										
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5.00	24X30	31-1526	1	.080																																																																																																																																																																																																																																																																																																																																										
12.00	36X48	31-1536	2	.100																																																																																																																																																																																																																																																																																																																																										
20.00	48X60	31-1546	2	.100																																																																																																																																																																																																																																																																																																																																										
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2.00	24X12	31-1776	1	.080																																																																																																																																																																																																																																																																																																																																										
<div>R6 - SERIES</div> <div>R6-1</div> <div></div> <div>ONE WAY</div> <div>LEGEND - WHITE BACKGROUND - BLUE</div> <table><tr><th>AREA (SQ. FT)</th><th>SIZE (INCHES)</th><th>CONN. D.O.T. #</th><th>POSTS</th><th>ALUM. THK.</th></tr><tr><td>3.00</td><td>36X12</td><td>31-1188L</td><td>1</td><td>.080</td></tr><tr><td>3.00</td><td>36X12</td><td>31-1177R</td><td>1</td><td>.080</td></tr><tr><td>6.75</td><td>54X18</td><td>31-1189L</td><td>1</td><td>.100</td></tr><tr><td>6.75</td><td>54X18</td><td>31-1178R</td><td>1</td><td>.100</td></tr></table>					AREA (SQ. FT)	SIZE (INCHES)	CONN. D.O.T. #	POSTS	ALUM. THK.	3.00	36X12	31-1188L	1	.080	3.00	36X12	31-1177R	1	.080	6.75	54X18	31-1189L	1	.100	6.75	54X18	31-1178R	1	.100	<div>R7 - SERIES</div> <div>R7-1</div> <div></div> <div>NO PARKING ANY TIME</div> <table><tr><th>AREA (SQ. FT)</th><th>SIZE (INCHES)</th><th>CONN. D.O.T. #</th><th>POSTS</th><th>ALUM. THK.</th></tr><tr><td>1.50</td><td>12X18</td><td>31-0630</td><td>1</td><td>.080</td></tr></table>					AREA (SQ. FT)	SIZE (INCHES)	CONN. D.O.T. #	POSTS	ALUM. THK.	1.50	12X18	31-0630	1	.080	<div>R7-2</div> <div></div> <div>NO PARKING 0:00 AM TO 0:00 PM</div> <table><tr><th>AREA (SQ. FT)</th><th>SIZE (INCHES)</th><th>CONN. D.O.T. #</th><th>POSTS</th><th>ALUM. THK.</th></tr><tr><td>1.50</td><td>12X18</td><td>31-0603</td><td>1</td><td>.080</td></tr></table>					AREA (SQ. FT)	SIZE (INCHES)	CONN. D.O.T. #	POSTS	ALUM. THK.	1.50	12X18	31-0603	1	.080	<div>R8 - SERIES</div> <div>R8-7</div> <div></div> <div>EMERGENCY STOPPING ONLY</div> <table><tr><th>AREA (SQ. FT)</th><th>SIZE (INCHES)</th><th>CONN. D.O.T. #</th><th>POSTS</th><th>ALUM. THK.</th></tr><tr><td>13.50</td><td>54X36</td><td>31-0667</td><td>2</td><td>.100</td></tr></table>					AREA (SQ. FT)	SIZE (INCHES)	CONN. D.O.T. #	POSTS	ALUM. THK.	13.50	54X36	31-0667	2	.100	<div>R9 - SERIES</div> <div>R9</div> <div></div> <div>HITCHHIKING PROHIBITED DO NOT STOP</div> <table><tr><th>AREA (SQ. FT)</th><th>SIZE (INCHES)</th><th>CONN. D.O.T. #</th><th>POSTS</th><th>ALUM. THK.</th></tr><tr><td>27.50</td><td>66X60</td><td>31-1733</td><td>2B</td><td>.125</td></tr></table>					AREA (SQ. FT)	SIZE (INCHES)	CONN. D.O.T. #	POSTS	ALUM. THK.	27.50	66X60	31-1733	2B	.125	<div>R10 - SERIES</div> <div>R10-6</div> <div></div> <div>STOP HERE ON RED</div> <div>31-0801</div> <div></div> <div>STOP HERE ON RED</div> <div>31-0802</div> <div>OVERHEAD MOUNTED</div> <table><tr><th>AREA (SQ. FT)</th><th>SIZE (INCHES)</th><th>CONN. D.O.T. #</th><th>POSTS</th><th>ALUM. THK.</th></tr><tr><td>6.00</td><td>24X36</td><td></td><td>1</td><td>.080</td></tr><tr><td>2.25</td><td>18X18</td><td>31-0817</td><td></td><td>.080</td></tr><tr><td>4.00</td><td>24X24</td><td>31-0823</td><td></td><td>.080</td></tr><tr><td>9.00</td><td>36X36</td><td>31-0816</td><td></td><td>.080</td></tr></table>					AREA (SQ. FT)	SIZE (INCHES)	CONN. D.O.T. #	POSTS	ALUM. THK.	6.00	24X36		1	.080	2.25	18X18	31-0817		.080	4.00	24X24	31-0823		.080	9.00	36X36	31-0816		.080	<div>R10-10L</div> <div></div> <div>LEFT TURN SIGNAL</div> <table><tr><th>AREA (SQ. FT)</th><th>SIZE (INCHES)</th><th>CONN. D.O.T. #</th><th>POSTS</th><th>ALUM. THK.</th></tr><tr><td>5.00</td><td>24X30</td><td>31-0803</td><td>1</td><td>.080</td></tr><tr><td>12.00</td><td>36X48</td><td>31-0804</td><td>2</td><td>.100</td></tr></table>					AREA (SQ. FT)	SIZE (INCHES)	CONN. D.O.T. #	POSTS	ALUM. THK.	5.00	24X30	31-0803	1	.080	12.00	36X48	31-0804	2	.100	<div>R10-11a</div> <div></div> <div>NO TURN ON RED</div> <table><tr><th>AREA (SQ. FT)</th><th>SIZE (INCHES)</th><th>CONN. D.O.T. #</th><th>POSTS</th><th>ALUM. THK.</th></tr><tr><td>3.00</td><td>18X24</td><td>31-0818</td><td>1</td><td>.080</td></tr><tr><td>5.00</td><td>24X30</td><td>31-0824</td><td>1</td><td>.080</td></tr><tr><td>7.50</td><td>30X36</td><td>31-0830</td><td>1</td><td>.080</td></tr><tr><td>12.00</td><td>36X48</td><td>31-0819</td><td>2</td><td>.100</td></tr></table>					AREA (SQ. FT)	SIZE (INCHES)	CONN. D.O.T. #	POSTS	ALUM. THK.	3.00	18X24	31-0818	1	.080	5.00	24X30	31-0824	1	.080	7.50	30X36	31-0830	1	.080	12.00	36X48	31-0819	2	.100	<div>R11 - SERIES</div> <div>R11-1</div> <div></div> <div>KEEP OFF MEDIAN</div> <table><tr><th>AREA (SQ. FT)</th><th>SIZE (INCHES)</th><th>CONN. D.O.T. #</th><th>POSTS</th><th>ALUM. THK.</th></tr><tr><td>5.00</td><td>24X30</td><td>31-1915</td><td>1</td><td>.080</td></tr><tr><td>20.00</td><td>48X60</td><td>31-1918</td><td>2</td><td>.100</td></tr></table>					AREA (SQ. FT)	SIZE (INCHES)	CONN. D.O.T. #	POSTS	ALUM. THK.	5.00	24X30	31-1915	1	.080	20.00	48X60	31-1918	2	.100	<div>NOTES:</div> <div>FOR METRIC SEE CONVERSION CHART.</div> <div>1. THE LEGEND "O.S.T.A." SHALL APPEAR ON ALL R- SERIES SIGNS EXCEPT WHEN SUFFIXED WITH THE LETTER "Z".</div> <div>2. FOR SPECIFIC SIGN DESIGN CONTACT CONN. D.O.T., DIVISION OF TRAFFIC ENGINEERING. FOR BOLT HOLE PATTERN REFER TO FHWA PUBLICATION "STANDARD HIGHWAY SIG</div>																																																																																																																																																
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